

DRAWING LIST - SITE DEVELOPMENT

NUMBER	NAME
C-000	COVER SHEET
C-001	NOTES, LEGEND AND ABBREVIATIONS
C-101	OVERALL SITE PLAN
C-401	ENLARGED SITE IMPROVEMENT PLANS
C-501	SITE IMPROVEMENT DETAILS


REDEVELOPMENT OF ONOVILLE MARINA PARK PHASE 1 - SIDEWALK IMPROVEMENTS

704 WEST PERIMETER ROAD, FREWSBURG, NY

BID DOCUMENTS

Owner
Cattaraugus County Department of Economic
Development, Planning & Tourism
303 Court Street
Little Valley, NY 14755
716.938.2310

Architect + Engineer
Beardsley Architects + Engineers
64 South Street
Auburn, NY 13021
315.253.7301

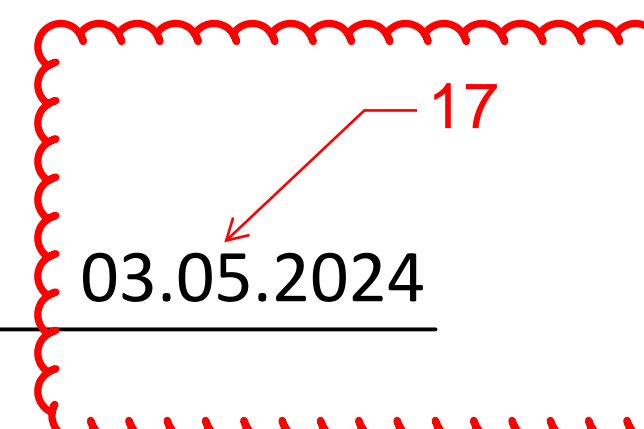

NOTES

REFERENCE NOTES

- CONSTRUCTION DRAWINGS ARE BASED ON ALTAIR'S LAND TITLE SURVEY, PROVIDED BY THEIR ASSOCIATES LAND SURVEYORS, PHONE: 315-386-2776.
- GEOTECHNICAL EVALUATION REPORT FORTHCOMING.

EXISTING WORK

- PROTECT FROM DAMAGE ALL EXISTING FEATURES NOT INDICATED OR REQUIRED TO BE REMOVED FOR THE WORK.
- REPAIR ITEMS THAT ARE TO REMAIN IF DAMAGED DURING THE PERFORMANCE OF THE WORK. REPAIR OR REPLACE TO THEIR ORIGINAL CONDITION AS DETERMINED BY THE OWNER'S REPRESENTATIVE, OR REPLACE WITH NEW IN-KIND.

LAYOUT

- ESTABLISH A CONSTRUCTION STAGING AREA AND EQUIPMENT STORAGE ON SITE. COORDINATE LOCATIONS WITH THE OWNER'S REPRESENTATIVE. RESTORE ANY AREAS DISTURBED BY STAGING, PARKING, OR OTHER CONSTRUCTION ACTIVITIES TO THEIR ORIGINAL CONDITION.
- ALL DIMENSIONS ARE TO FACE OF BUILDING, STRUCTURE, CURB OR EDGE OF PAVEMENT, UNLESS NOTED OTHERWISE.
- ALL WORK MUST CONFORM TO ANSI A117.1-2009 FOR ACCESSIBILITY.
- ENGAGE A LICENSED LAND SURVEYOR FOR SITE LAYOUT. PRIOR TO CONSTRUCTION, SET A MINIMUM OF TWO BENCHMARKS AND PROTECT THEM THROUGHOUT CONSTRUCTION. VERIFY ALL EXISTING CONDITIONS PRIOR TO CONSTRUCTION.

DEMOLITION

- CONDUCT REMOVAL OPERATIONS TO PREVENT INJURY TO PEOPLE AND DAMAGE TO ADJACENT EXISTING FEATURES TO REMAIN. ENSURE SAFE PASSAGE OF PEOPLE AND AUTHORIZED VEHICLES AROUND THE WORK AREA.
- PROVIDE CONSTRUCTION FENCES, BARRICADES OR OTHER SUITABLE DEVICES AS DIRECTED BY THE OWNER'S REPRESENTATIVE TO PREVENT DAMAGE BY VEHICLES AND UNAUTHORIZED ENTRY INTO WORK, CONSTRUCTION STAGING AND EQUIPMENT STORAGE AREAS.
- RESTRICT VEHICULAR TRAFFIC TO AREAS OUTSIDE THE DRIP LINE OF TREES. PREVENT COMPACTION OF SOIL WITHIN THE DRIP LINE OF TREES AND SHRUBS. DO NOT DRIVE OR PARK VEHICLES ON LAWNS.
- PROVIDE ALL REMOVALS INCIDENTAL TO AND NECESSARY TO PROVIDE THE WORK OF THIS CONTRACT AND LEGALLY DISPOSE OF OFF-SITE. REMOVE EXISTING FEATURES AND UNUSED EARTH MATERIALS INCLUDING EXCESS TOPSOIL IN THEIR ENTIRETY UNLESS OTHERWISE INDICATED BY THE OWNER'S REPRESENTATIVE.
- PROMPTLY DISPOSE OF DEMOLISHED MATERIALS AND TRASH. DO NOT ALLOW DEBRIS TO ACCUMULATE ON-SITE.
- UTILIZE SAW-CUTS IN AREAS WHERE PAVEMENT IS TO BE REMOVED FOR INSTALLATION OF IMPROVEMENTS AND WHERE NEW PAVEMENT IS JOINED WITH EXISTING. TREAT ALL JOINTS BETWEEN NEW AND EXISTING ASPHALT PAVEMENT WITH AN ASPHALT EMULSION.
- REMOVE EXISTING TREES AND VEGETATION AS REQUIRED TO INSTALL IMPROVEMENTS. NOT ALL TREE REMOVALS ARE EXPLICITLY IDENTIFIED IN WOODED AREAS. PRIOR TO CONSTRUCTION, STAKE OUT PROPOSED PIPE ROUTING AND STRUCTURE LOCATIONS FOR REVIEW AND APPROVAL BY THE OWNER'S REPRESENTATIVE. ALTERNATE ROUTINGS MAY BE SUGGESTED TO MINIMIZE IMPACTS TO EXISTING FEATURES. COORDINATE TIMING OF TREE REMOVALS WITH OWNER'S REPRESENTATIVE. THE EXTENT OF ALL CLEARING AND GRUBBING SHALL BE APPROVED BY THE OWNER'S REPRESENTATIVE PRIOR TO CONSTRUCTION.
- REMOVE ALL SECTIONS OF EXISTING ABANDONED UNDERGROUND UTILITIES WHERE THEY INTERFERE WITH NEW WORK OR AS NOTED, PERMANENTLY SEAL REMAINING SECTIONS WITH MORTAR OR END CAPS.
- CONTRACTOR TO COORDINATE AND NOTIFY OWNER'S REPRESENTATIVE OF ANY DISCREPANCIES.

SITE GRADING AND DRAINAGE NOTES

- RESTRICT GRADING OPERATIONS TO AREAS SHOWN ON THE DRAWINGS. GRADING OUTSIDE THE CONTRACT LIMIT LINE, UNLESS AUTHORIZED BY THE OWNER'S REPRESENTATIVE, WILL NOT BE PERMITTED.
- PERFORM ALL EXCAVATION OPERATIONS WITH EXTREME CAUTION. DETERMINE LOCATION AND ELEVATION OF EXISTING UTILITIES PRIOR TO COMMENCING GRADING.
- BLEND ALL LINES AND GRADES OF NEW WORK SMOOTHLY WITH EXISTING.
- GRADE ALL SURFACES TO DRAIN AWAY FROM ALL NEW AND EXISTING STRUCTURES. ALL AREAS MUST DRAIN TO AN OUTLET, WHETHER EXISTING OR NATURAL. AREAS WHICH POND IN EXCESS OF 1/4 INCH IN PAVED AREAS AND 1/2 INCH IN LAWN AREAS WILL NOT BE ACCEPTED.
- MAINTAIN EXISTING STORM DRAIN FACILITIES NOT INTERRUPTED BY CONSTRUCTION RELATED ACTIVITIES.
- ADJUST ALL MANHOLE AND OTHER UTILITY COVERS LOCATED WITHIN AREAS OF CONSTRUCTION OPERATIONS TO PROPOSED FINISHED GRADE.

UTILITIES

- THE LOCATION OF EXISTING UTILITIES INDICATED ON THE SITE SURVEY AND DRAWINGS ARE APPROXIMATE ONLY. ACCURATELY LOCATE EXISTING SUBSURFACE UTILITIES BEFORE EXCAVATION.
- PRIOR TO COMMENCING ANY CONSTRUCTION ACTIVITIES, CONTACT DIG SAFELY NEW YORK (1-800-962-7962) FOR INFORMATION ON EXISTING UNDERGROUND UTILITIES.
- CONTACT COMMERCIAL UTILITY COMPANIES TO OBTAIN INFORMATION ABOUT EXISTING UTILITIES. CONTACT OWNER'S REPRESENTATIVE TO OBTAIN UTILITY COMPANY INFORMATION.
- PERFORM EXCAVATION IN ACCORDANCE WITH ALL APPLICABLE LOCAL, STATE AND FEDERAL REQUIREMENTS.
- SLOPE OR SUPPORT THE SIDES OF ALL EXCAVATIONS AS REQUIRED BY SAFETY REGULATIONS.
- ALL WATER AND SEWER LINES TO BE INSTALLED IN STRICT COMPLIANCE WITH THE REQUIREMENTS OF THE WATER MAIN/SEWER CROSSING DETAIL PROVIDED IN THE CONSTRUCTION DOCUMENTS.
- PROVIDE NEW YORK STATE ELECTRICAL INSPECTION FOR THE WORK AT EACH BUILDING, PERFORMED BY LICENSED UNDERWRITER, PRIOR TO ENERGIZATION.

SOIL EROSION & SEDIMENTATION CONTROL

- ALL SOIL EROSION AND SEDIMENTATION CONTROL MEASURES SHALL CONFORM TO THE LATEST EDITION OF THE NEW YORK STANDARDS AND SPECIFICATIONS FOR EROSION AND SEDIMENT CONTROL, AND THE PROJECT STORMWATER POLLUTION PREVENTION PLAN (SWPPP). REFER TO EROSION CONTROL DRAWINGS FOR PRESCRIBED MEASURES, AND SUPPLEMENT AS REQUIRED BY SITE CONDITIONS AND THE OWNER'S REPRESENTATIVE.
- PROVIDE AND MAINTAIN EROSION AND SEDIMENT CONTROL MEASURES TO EFFECTIVELY CONTAIN ALL SOIL MATERIAL WITHIN THE SITE CONSTRUCTION AREA.
- ALL NECESSARY CONTROLS SHALL BE IN PLACE PRIOR TO STARTING EARTHWORK OPERATIONS AND SHALL REMAIN IN PLACE UNTIL THE DISTURBED AREAS ARE STABILIZED WITH SEEDING, PAVEMENTS AND/OR SLOPE PROTECTION.
- PROVIDE TEMPORARY SILT FENCING, AND SEED AND MULCH ALL SOIL STOCKPILES WHEN SOIL IS STORED FOR MORE THAN SEVEN DAYS.
- PERIODICALLY CLEAN, INSPECT, MAINTAIN AND REINSTALL EROSION AND SEDIMENT CONTROL MEASURES TO MAINTAIN INTEGRITY AND EFFECTIVENESS OF MEASURES.
- KEEP ROADS CLEAN OF MUD AND DEBRIS AT ALL TIMES. VEHICLES SHALL USE A WASH AREA TO CLEAN WHEELS OF ANY ACCUMULATED EARTH, CONCRETE, ETC. PRIOR TO EXITING PROJECT LIMITS. COORDINATE LOCATION OF THE WASH AREA WITH THE OWNER'S REPRESENTATIVE.
- TAKE ALL NECESSARY PRECAUTIONS TO PREVENT CONTAMINATION TO WATER BODIES, STREAMS, AND DRAINAGE COURSES FROM SILT, SEDIMENT, FUELS, SOLVENTS, LUBRICANTS, CONCRETE LEACHATE OR ANY OTHER POLLUTANTS ASSOCIATED WITH CONSTRUCTION.
- ALL EXCAVATED MATERIAL SHALL BE STABILIZED ON AN UPLAND SITE SO THAT IT CAN NOT ENTER ANY WATER BODY.
- ALL AREAS OF SOIL DISTURBANCE RESULTING FROM THIS PROJECT SHALL BE TOPSOILED AND SEEDED WITH THE SPECIFIED GRASS SEED MIX AND MULCHED WITH STRAW WITHIN ONE WEEK OF FINAL GRADING. MULCH SHALL BE MAINTAINED UNTIL A SUITABLE VEGETATIVE COVER IS APPROVED BY THE OWNER'S REPRESENTATIVE.
- TOPSOIL SHALL CONSIST OF LOOSE FRIABLE ORGANIC MATERIAL, FREE OF REFUSE, STONES, SUBSOIL, WEEDS, OR OTHER MATERIAL DELETERIOUS FOR PLANT OR LAWN GROWTH.

CONSTRUCTION DEWATERING

- PERFORM ALL EXCAVATION AND BACKFILL IN THE DRY. DEWATER, TO PERMIT SUITABLE PREPARATION OF THE SUBGRADE AND COMPACTION OF ANY SUBSEQUENT FILL AND BACKFILL MATERIALS.
- BE PREPARED TO DEWATER. OPERATE DEWATERING SYSTEM ISO THAT DISTURBANCE OR REMOVAL OF THE SUBGRADE SOIL DOES NOT OCCUR. COMPLY WITH ALL APPLICABLE ENVIRONMENTAL REGULATIONS, INCLUDING THOSE RELATED TO DISCHARGE OF WATER.
- DURING DEWATERING OPERATIONS, A DEWATERING BASIN WILL BE REQUIRED UNLESS THE PUMP DISCHARGE IS AS CLEAR AND FREE OF SEDIMENT AS THE RECEIVING WATERCOURSE. DEWATERING METHODS SHALL BE APPROVED BY THE OWNER'S REPRESENTATIVE.

RESTORATION OF SURFACES

- FINE GRADE AND SEED ALL AREAS DISTURBED BY THIS CONSTRUCTION, WHICH ARE NOT OTHERWISE NOTED.
- RESTRICT GROUND DISTURBANCES TO THE MINIMUM EXTENT PRACTICAL. ALL DISTURBED AREAS SHALL BE RESTORED TO EXISTING FINISH GRADE UNLESS INDICATED OTHERWISE.

PLANTING NOTES

- PROVIDE NAMED VARIETIES, SIZES AND QUANTITIES LISTED, SUBSTITUTIONS ARE NOT ALLOWED UNLESS APPROVED BY OWNER'S REPRESENTATIVE.
- ALL NURSERY GROWN PLANT MATERIAL IN SCHEDULE SHALL BE IN ACCORDANCE WITH ANSI Z.60.1 STANDARDS FOR MEASUREMENT OF NURSERY STOCK.
- ALL PLANTS SHALL BE GUARANTEED BY THE CONTRACTOR FOR A PERIOD OF ONE YEAR FROM DATE OF PHYSICAL COMPLETION AND ACCEPTANCE BY THE OWNER'S REPRESENTATIVE.
- REPLACEMENT PLANTINGS WILL BE REQUIRED PRIOR TO FINAL ACCEPTANCE, FOR ANY PLANT MATERIAL WHICH IS MISSING, NOT TRUE TO SPECIFICATIONS, HAS DIED, OR IS UNHEALTHY OR UNCHARACTERISTIC OF THE SPECIES (DUE TO EXCESSIVE PRUNING OR DIE BACK).
- LOCATE ALL UNDERGROUND UTILITIES IN AREAS TO BE LANDSCAPED PRIOR TO COMMENCING ANY EXCAVATION. ADJUSTMENTS TO TREE LOCATIONS WILL BE ALLOWED WHERE UTILITY CONFLICTS ARE CLEARLY A PROBLEM AND WITH PRIOR SITE APPROVAL BY THE OWNER'S REPRESENTATIVE.
- ALL TOPSOIL AND SEEDED AREAS ARE TO RECEIVE MINIMUM 4" MECHANICALLY SCREENED TOPSOIL.
- EXISTING PLANTINGS DAMAGED DURING THE COURSE OF CONSTRUCTION SHALL BE REPLACED IN-KIND TO THE SATISFACTION OF THE OWNER'S REPRESENTATIVE.

LEGEND

	EX BENCHMARK
	PAVEMENT CUT LINE
	EX SITE FEATURE TO BE REMOVED
	EX TREE TO BE REMOVED
	REMOVE EX SURFACE
	EX BOULDER
	EX PIPE BOLLARD
	EX CONCRETE CURB
	EX GRAVEL EDGE
	EX OVERHEAD ELECTRIC & GUY WIRE
	EX LIGHT POLE
	EX UTILITY POLE
	EX WATER SERVICE
	EX HYDRANT AND VALVE
	EX SANITARY MANHOLE
	EX STORMWATER
	EX STORM CATCH BASIN
	EX RIP RAP
	EX VEGETATION LINE
	EX TREE
	EX EDGE OF WATER
	EX SIGNAGE
	EX CONTOUR
	EX SPOT ELEVATION
	FULL DEPTH ASPHALT PAVEMENT
	CONCRETE PAVEMENT
	BOLLARD
	PARKING SIGN AND SCHEDULE
	CONCRETE WHEELSTOP
	ACCESSIBLE SYMBOL
	PAINTED LINES (NO PARKING AREA)
	OVERHEAD ELECTRIC
	UNDERGROUND ELECTRIC
	SITE LIGHTING
	UTILITY POLE
	TRANSFORMER
	ELECTRIC HANDHOLE
	UNDERGROUND COMMUNICATION LINE
	COMMUNICATION HANDHOLE
	WATER SERVICE
	POST INDICATOR VALVE / WATER VALVE
	SANITARY SEWER
	SANITARY FORCEMAIN
	SANITARY CLEAN OUT / MANHOLE
	CONTOURS
	SPOT ELEVATION
	TREES AND SHRUBS
	SILT FENCE
	TREE PROTECTION
	INLET PROTECTION

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ABBREVIATIONS

ADA AMERICANS WITH DISABILITIES ACT	GA GAUGE	RG&E ROCHESTER GAS AND ELECTRIC
APPROX APPROXIMATELY	GAL GALVANIZE	SA SANITARY PIPE
ASTM AMERICAN SOCIETY FOR TESTING AND MATERIALS	GV GATE VALVE	SAMH SANITARY MANHOLE
AVG AVERAGE	HC HANDICAP	SAN SANITARY
BBQ BARBECUE	HD HEAVY DUTY	SB SOIL BORING
BM BENCHMARK	HH HANDHOLE	SCD SCHEDULE
BLDG BUILDING	HORIZ HORIZONTAL	SDR STANDARD DIMENSION RATIO
BP BEGINNING POINT	ID INSIDE DIAMETER	SF SQUARE FEET
C CENTER	INV INVERT	SG SWITCHGEAR
CB CATCH BASIN	JT JOINT	SICPP SMOOTH INTERIOR CORRUGATED POLYETHYLENE PIPE
CL CENTER LINE	LP LIQUID PROPANE GAS	SPEC SPECIFICATION
CMP CORRUGATED METAL PIPE	MAX MAXIMUM	SQ SQUARE
CONC CONCRETE	MDO MEDIUM DENSITY OVERLAY	SS STAINLESS STEEL
CONT CONTINUOUS	MH MANHOLE	ST STORMWATER DRAIN / SEPTIC TANK
CPEP CORRUGATED POLYETHYLENE PIPE	MIN MINIMUM	STA STATION
DEMO DEMOLISH / DEMOLITION	MISC MISCELLANEOUS	STMH STORMWATER MANHOLE
DF DRINKING FOUNTAIN	MUTCD MANUAL ON UNIFORMED TRAFFIC CONTROL DEVICES	TBD TO BE DETERMINED
DI DROP INLET / DUCTILE IRON	N NORTH / NORTHING	TYP TYPICAL
DIA DIAMETER	NIC NOT IN CONTRACT	UE UNDERGROUND ELECTRIC
DV DRAIN VALVE	NYS NEW YORK STATE	UEP UNDERGROUND ELECTRIC PRIMARY
DWG DRAWING	NYSDEC NEW YORK STATE DEPARTMENT OF ENVIRONMENTAL CONSERVATION	UES UNDERGROUND ELECTRIC SECONDARY
E EAST / EASTING / ELECTRIC	NYSDOT NEW YORK STATE DEPARTMENT OF TRANSPORTATION	UNO UNLESS NOTED OTHERWISE
EA EACH	NYSOPRHP NEW YORK STATE OFFICE OF PARKS, RECREATION AND HISTORIC PRESERVATION	XF TRANSFORMER
EL / ELEV ELEVATION	OC ON CENTER	VERT VERTICAL
ELEC ELECTRICAL	OSHA OCCUPATIONAL SAFETY AND HEALTH ADMINISTRATION	W WATER
EJ EXPANSION JOINT	PC POINT OF CURVATURE	W/ WITH
EMH ELECTRIC MANHOLE	PCL PAVEMENT CUT LINE	W/O WITH OUT
EP END POINT	PE POLYETHYLENE	WV WATER VALVE
EQ EQUAL	PI POINT OF INTERSECTION	WWM WELDED WIRE MESH
ES END SECTION	PL PROPERTY LINE	
ETC ETCETERA	PSI POUNDS PER SQUARE INCH	
EW EACH WAY	PT POINT / POINT OF TANGENCY	
EX EXISTING	PVC POLYVINYL CHLORIDE	
FFE FINISH FLOOR ELEVATION	PV1 POINT OF VERTICAL CURVE	
FT FEET	R RADIUS	

* NOTE * NOT ALL ABBREVIATIONS MAY BE USED

NOT FOR CONSTRUCTION



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ONOVILLE MARINA PARK
PHASE 1 - SIDEWALK IMPROVEMENTS
CATTARAUGUS COUNTY, NEW YORK
704 West Perimeter Road, Frewsburg, NY 14738

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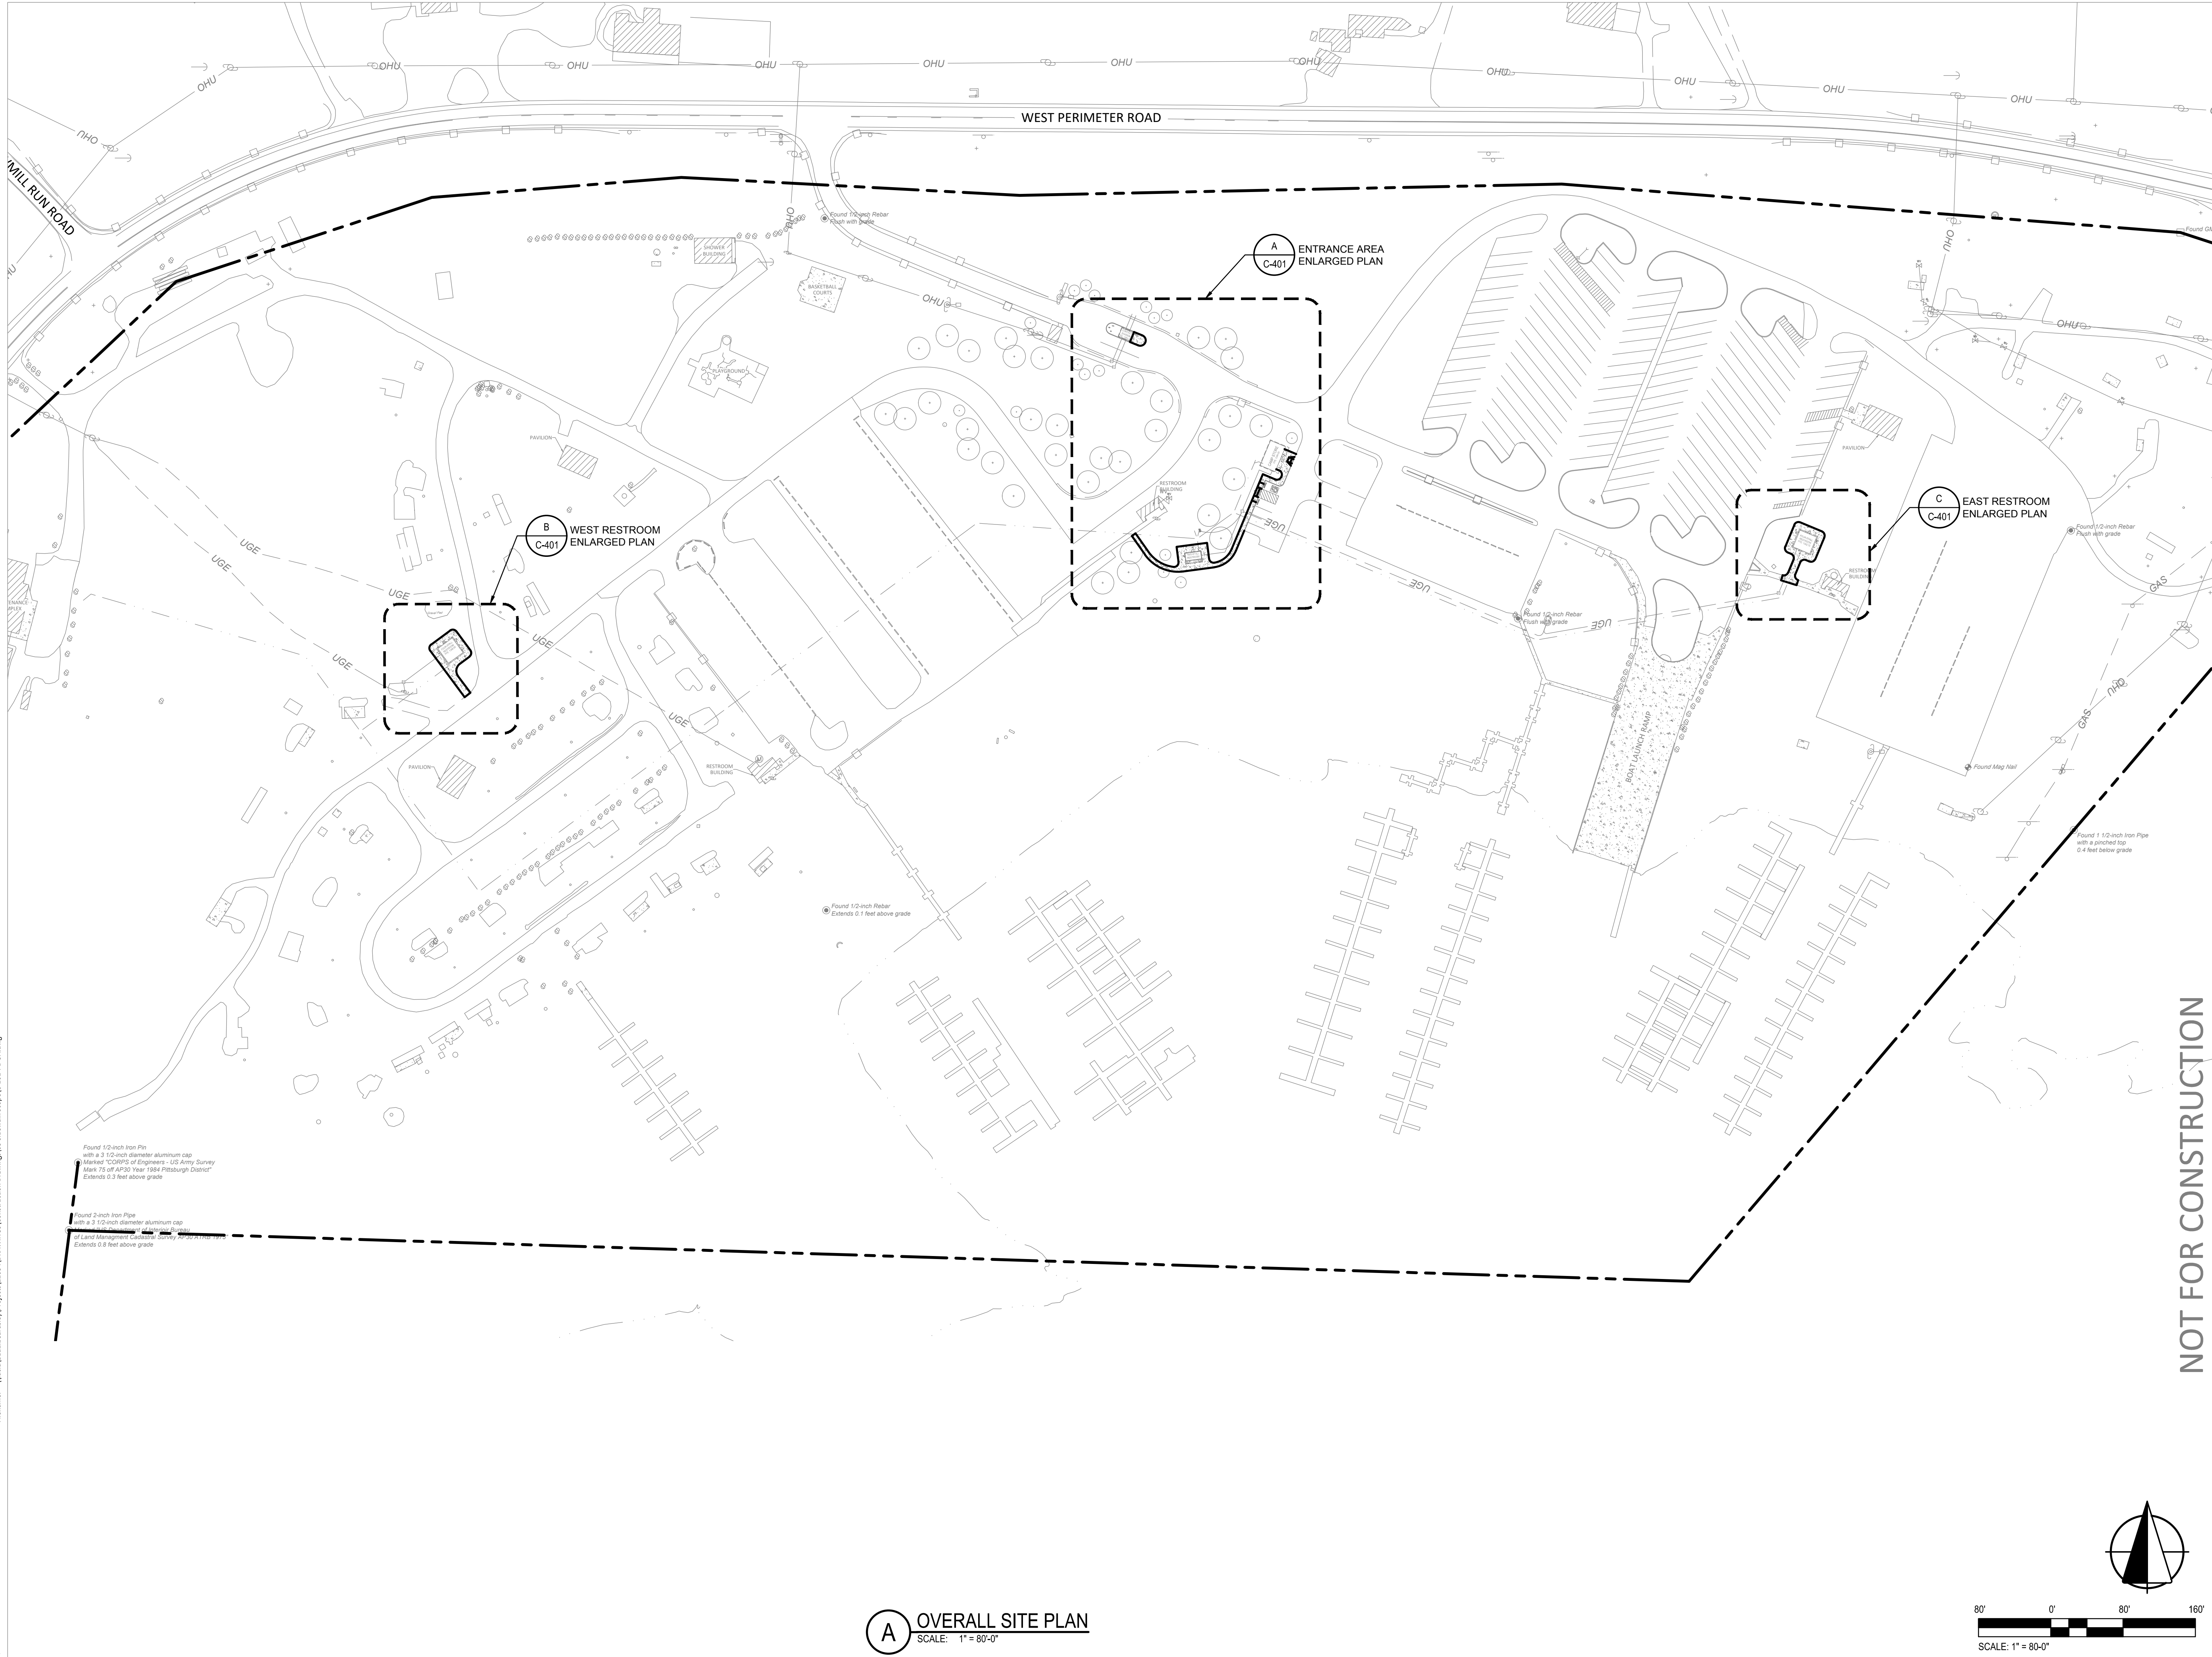
BID DOCUMENTS
03.05.2024

Beardsley Project Number: 22034

Drawn By: JLB
Designed By: JLB
Reviewed By: JRH

CIVIL
NOTES, LEGEND AND ABBREVIATIONS

C-001



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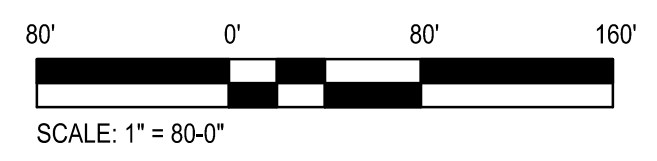
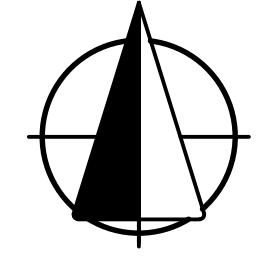
Drawn By: CEB
Designed By: CEB
Reviewed By: JRH

**ONOVILLE MARINA PARK
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no.	revision description	by	date


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OVERALL SITE PLAN




A OVERALL SITE PLAN
SCALE: 1" = 80'-0"


C-101

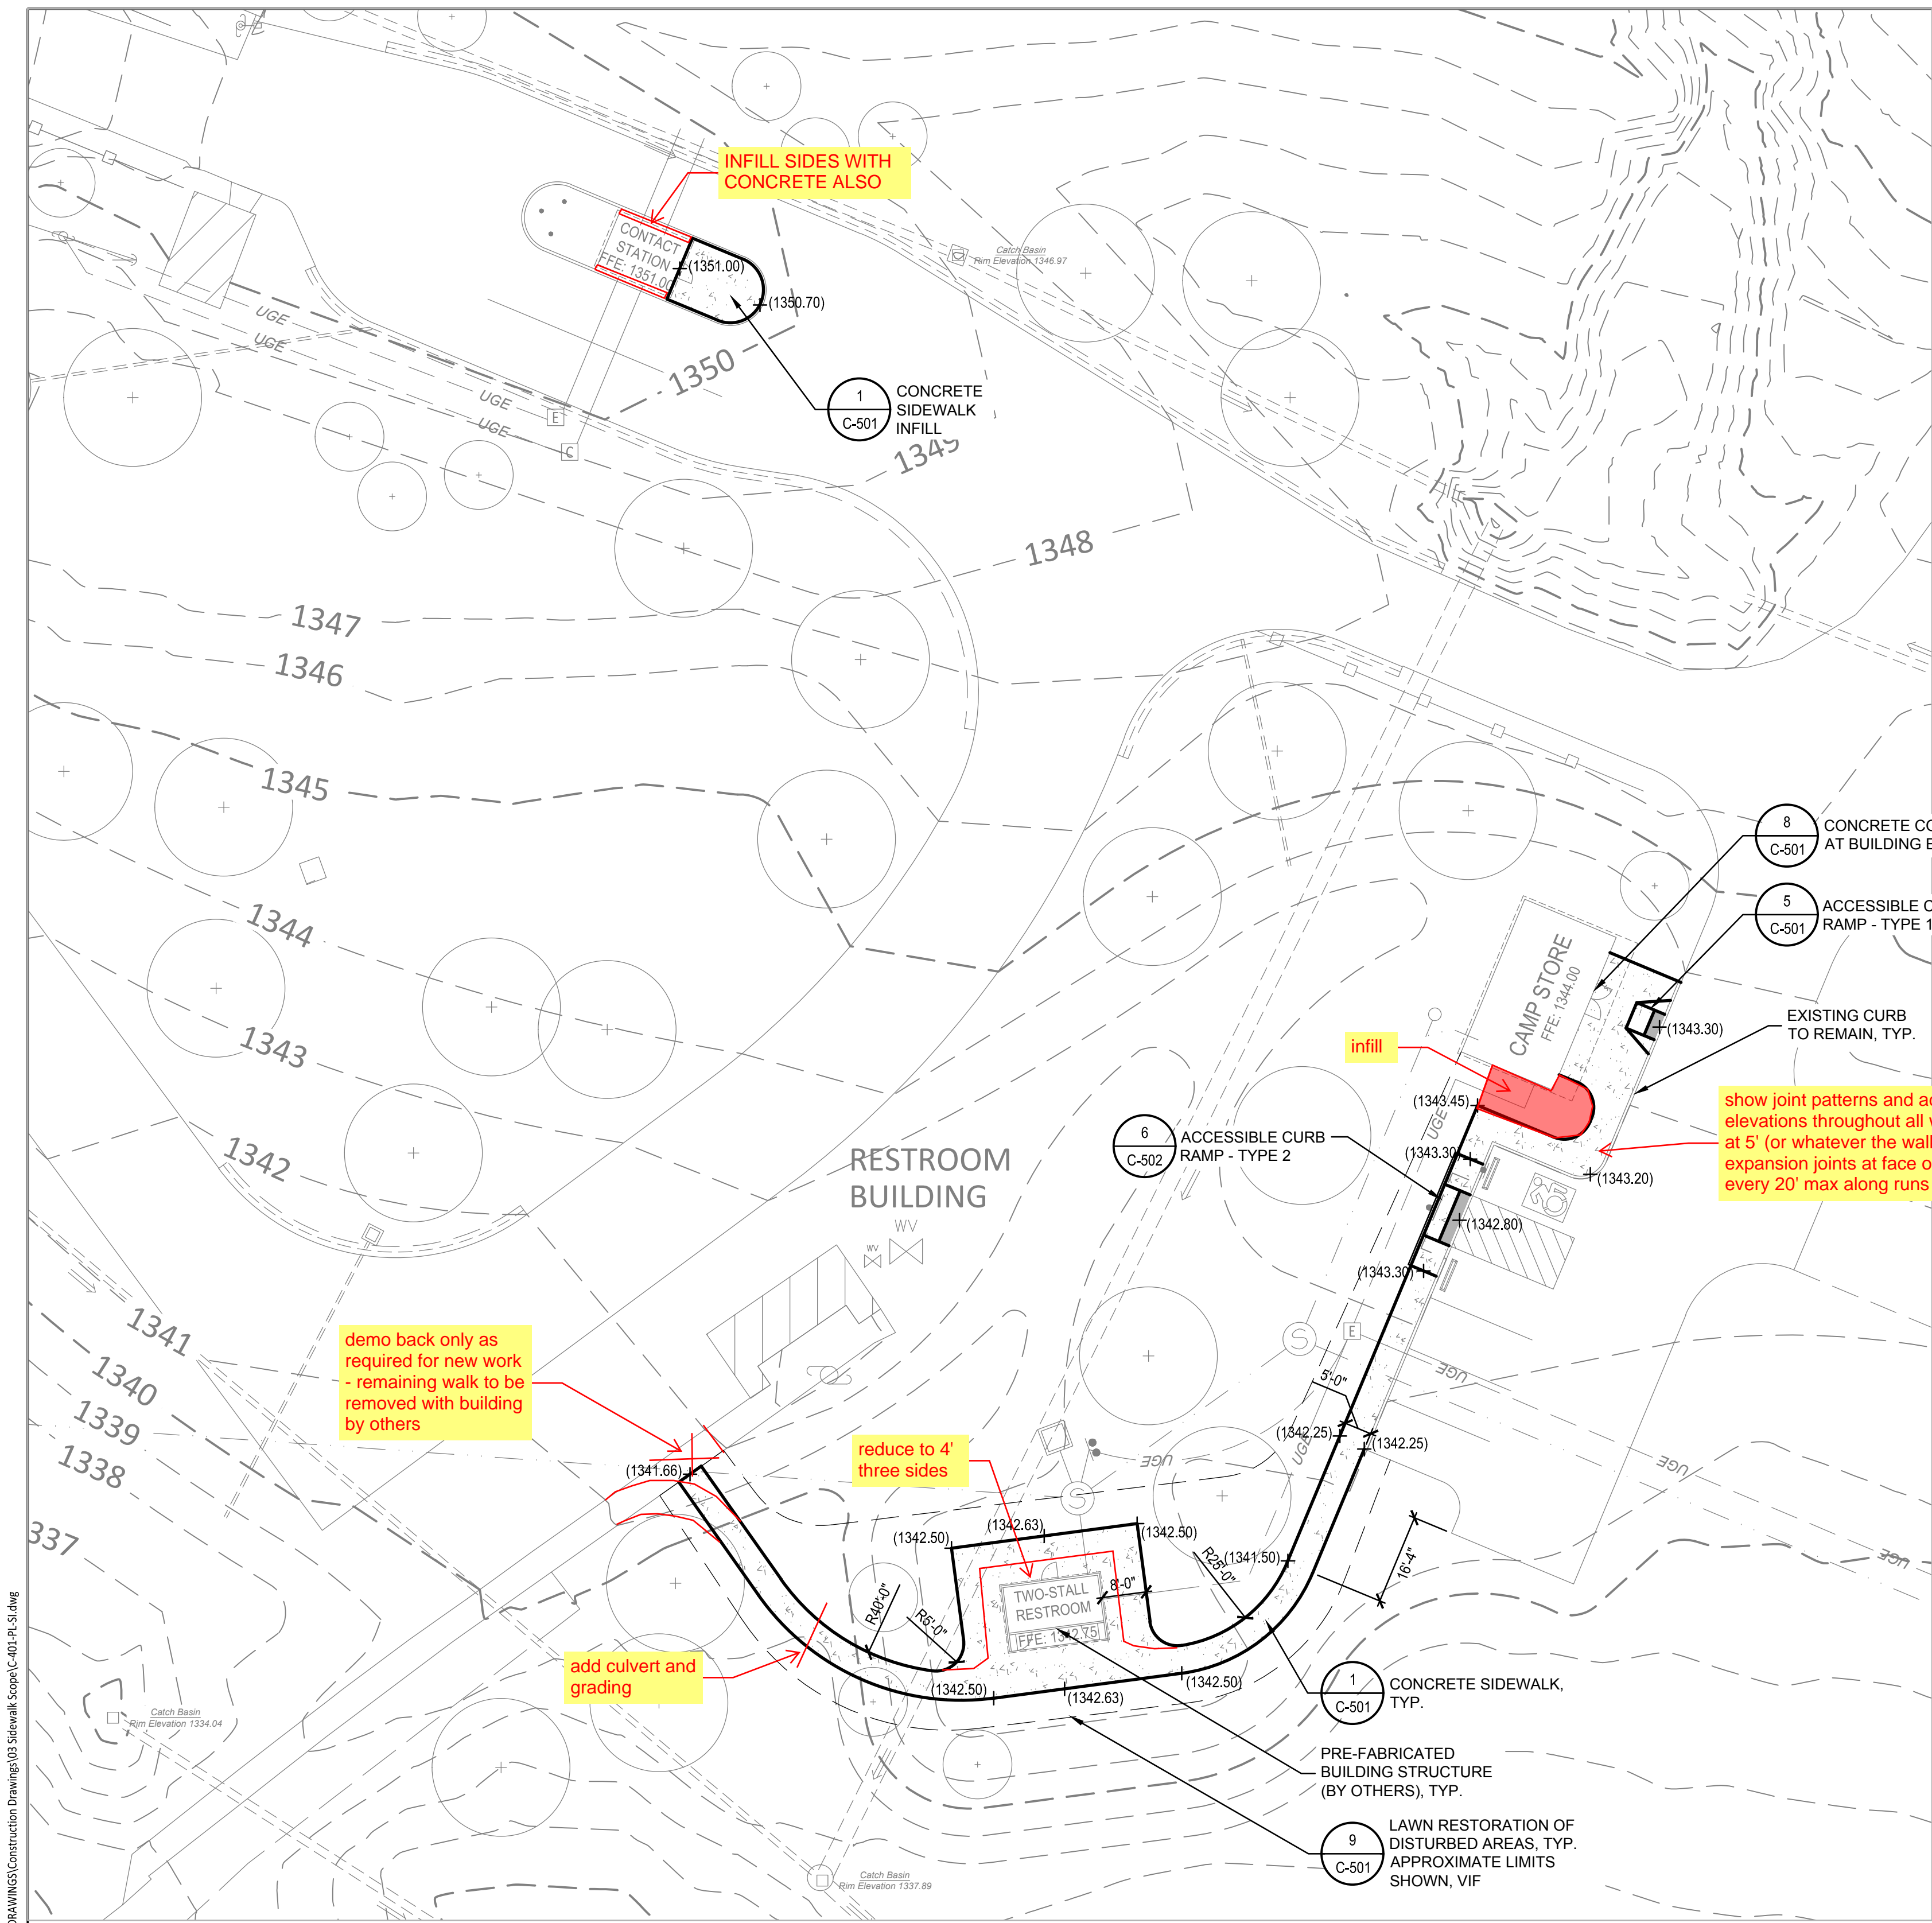

A SITE IMPROVEMENT PLAN - ENTRANCE AREA
SCALE: 1" = 20'-0"

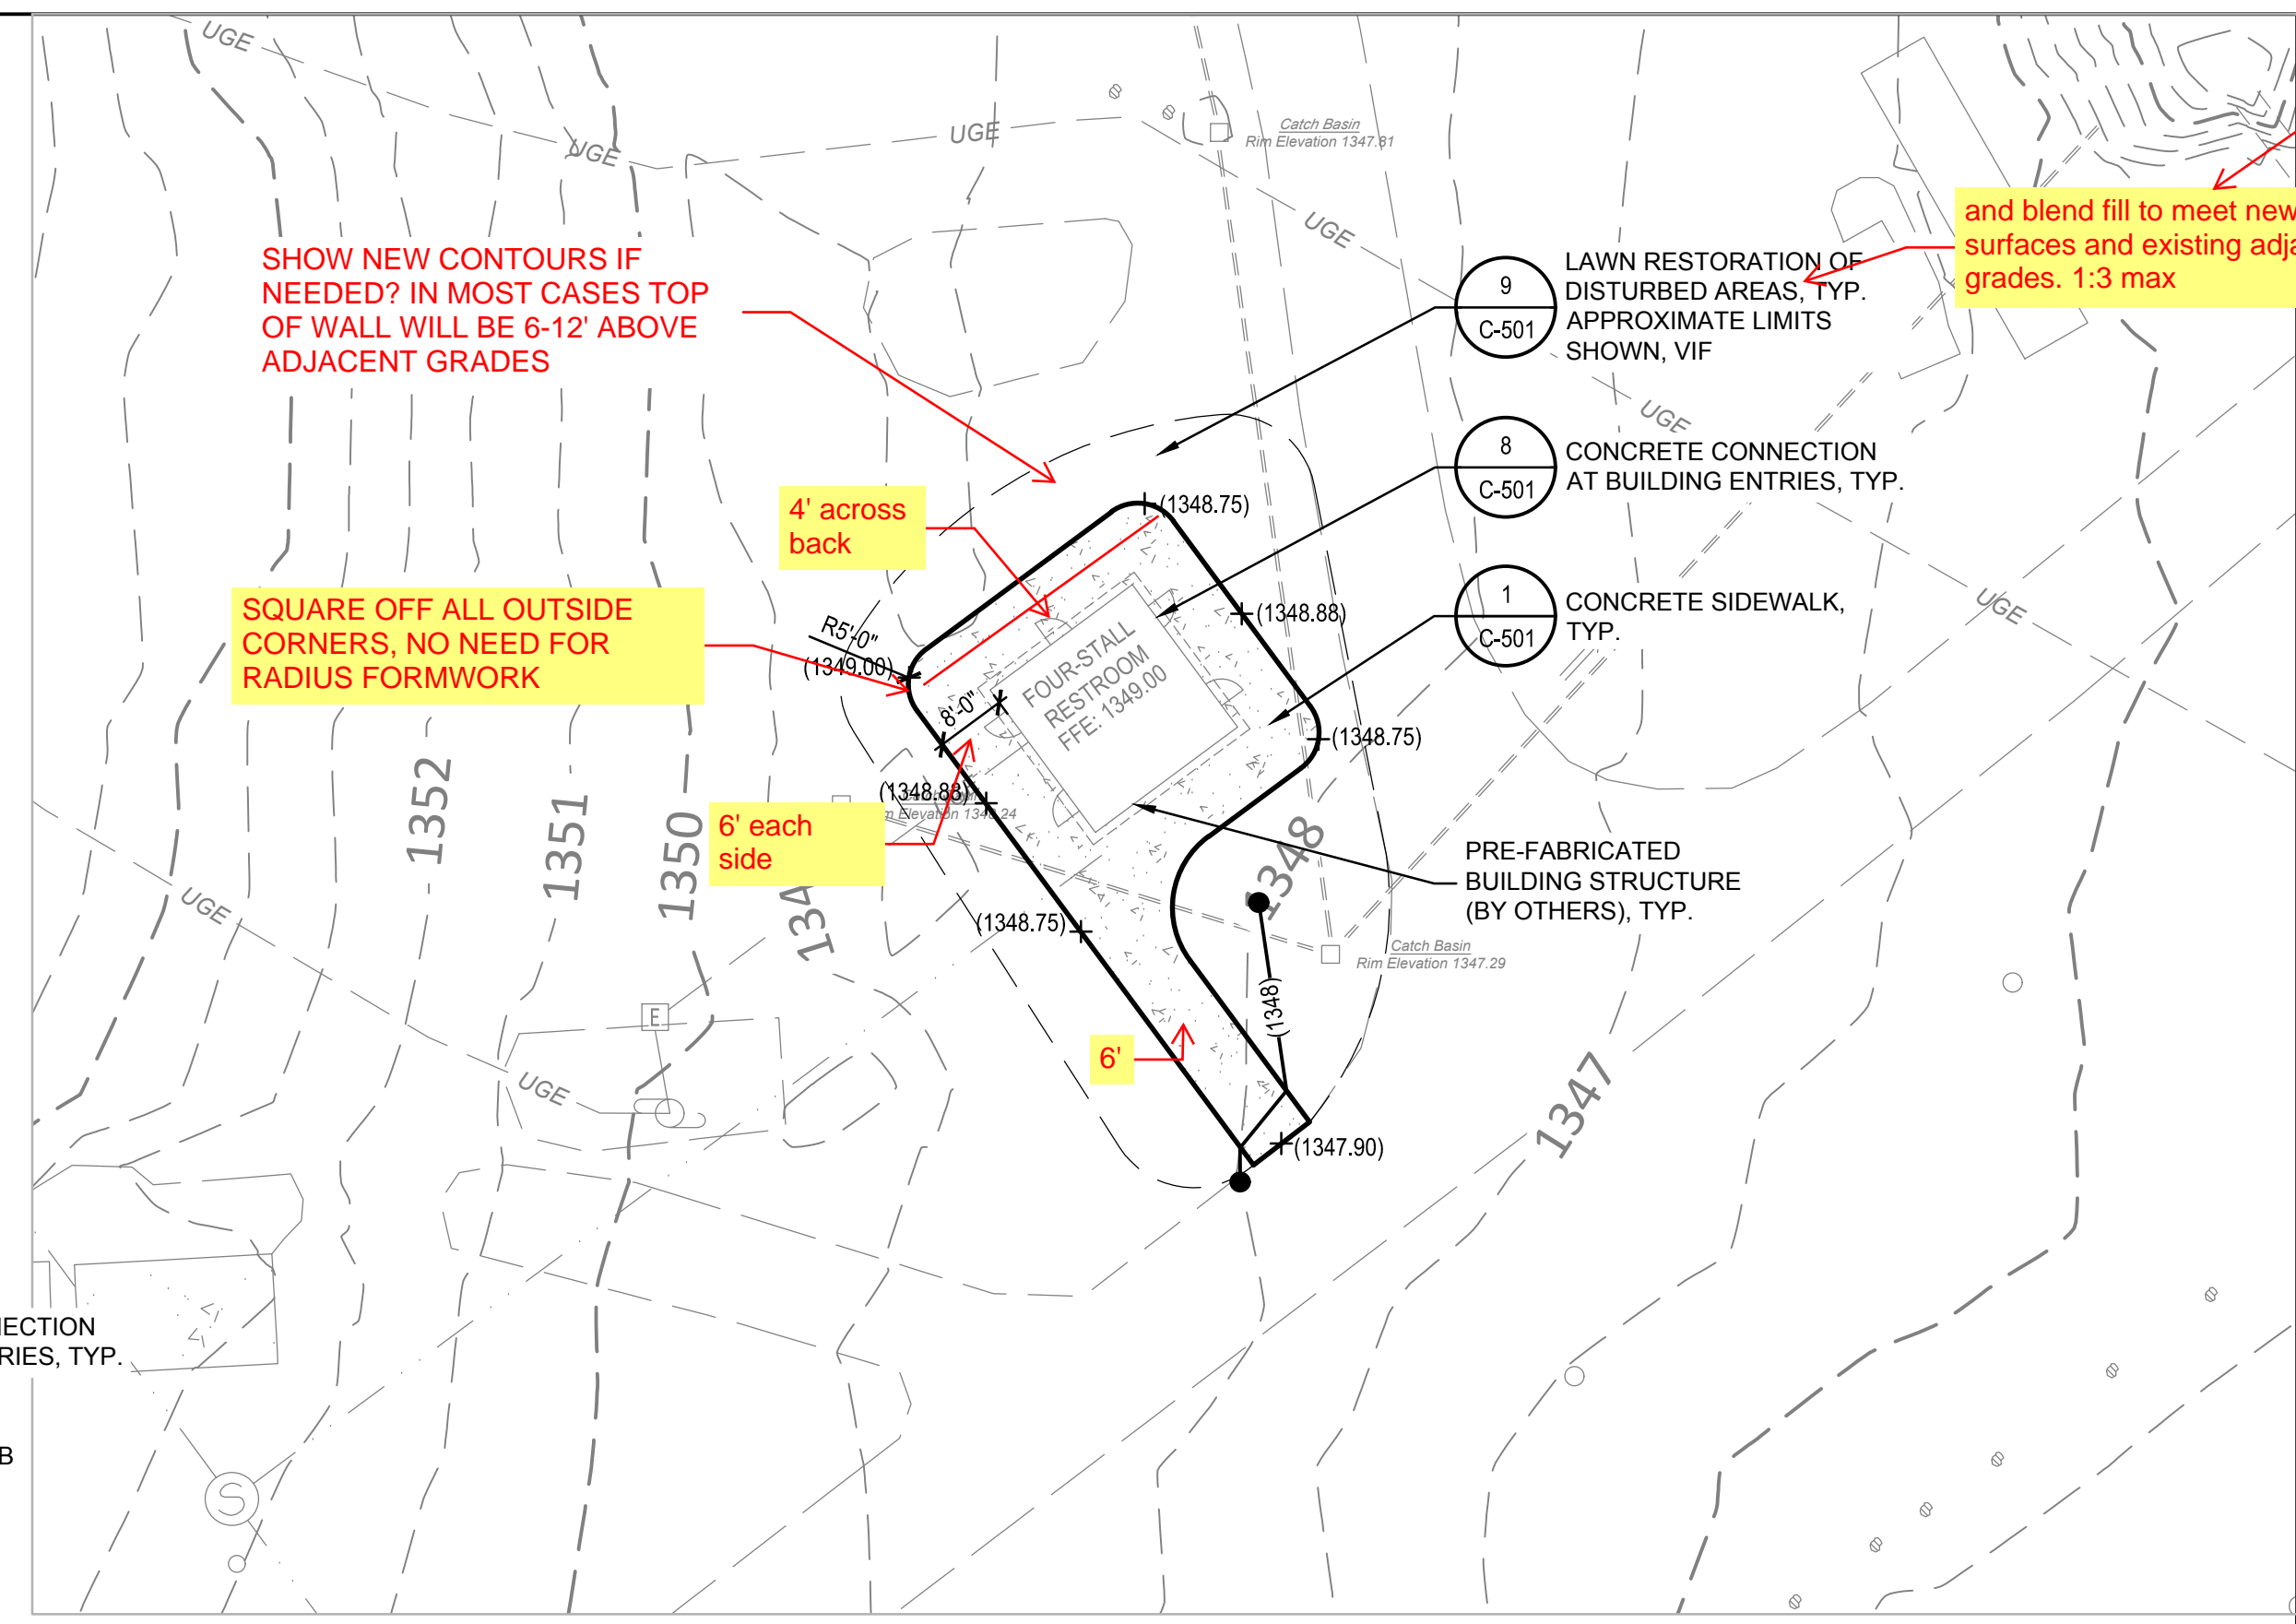

B SITE IMPROVEMENT PLAN - WEST RESTROOM AREA
SCALE: 1" = 20'-0"

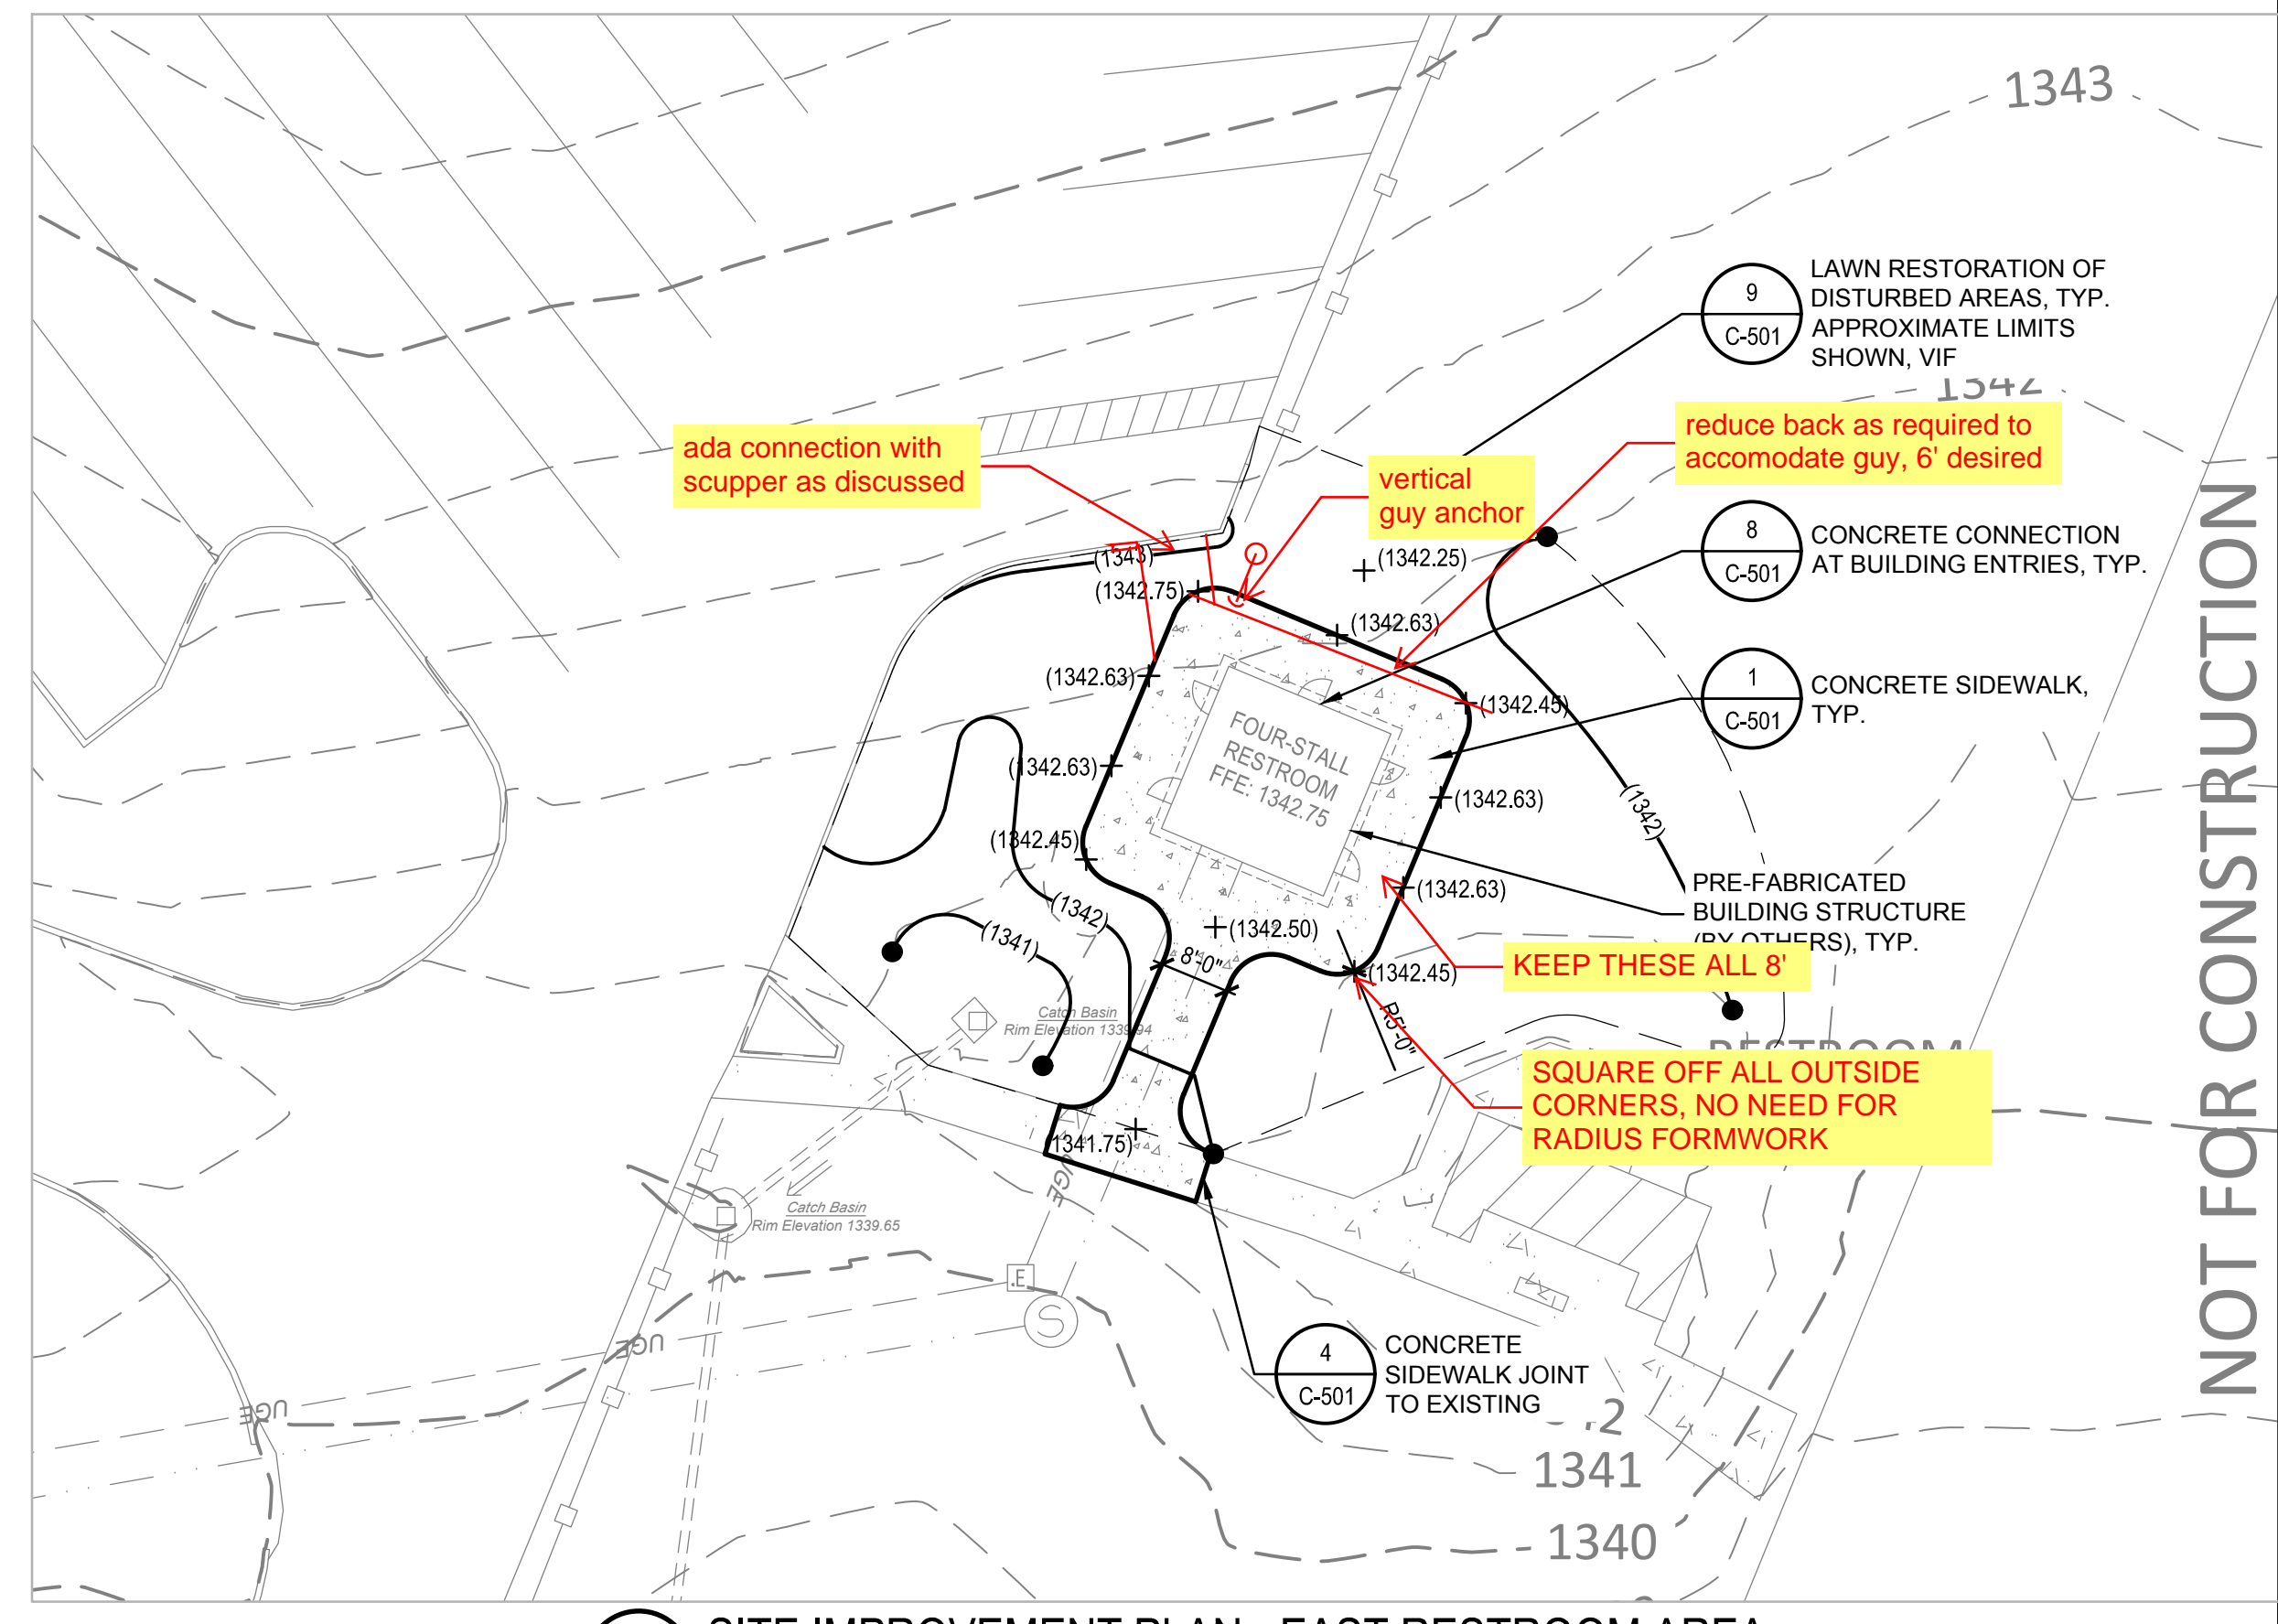

C SITE IMPROVEMENT PLAN - EAST RESTROOM AREA
SCALE: 1" = 20'-0"

GRADING SURFACE TOLERANCES:
 1. PERIMETER OF ALL SIDEWALK WORK SHALL BE BLENDED SMOOTHLY TO PROVIDE POSITIVE DRAINAGE AND MEET EXISTING AND PROPOSED SURFACES. PROVIDE 1V:3H MAXIMUM TRANSITION SLOPES.
 2. ALL CONCRETE SURFACES SHALL BE SET TO THE GRADES AS DESIGNED, OR AS OTHERWISE DIRECTED BY THE ENGINEER DURING CONSTRUCTION. SURFACES SHALL DRAIN AWAY FROM STRUCTURES AT 1% (MIN), 2% (MAX) SLOPE.
 3. GRADE TO MEET EXISTING TOP OF CURB, ADJOINING PAVEMENT SURFACES, DOOR THRESHOLDS, OR OTHER FEATURES.

FEEL FREE TO EXPAND THESE IF YOU HAVE ANY IDEAS



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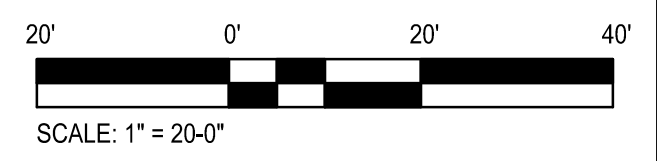
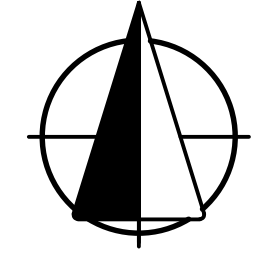
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 PHASE 1 - SIDEWALK IMPROVEMENTS
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 704 West Perimeter Road, Frewsburg, NY 14738**

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C-401

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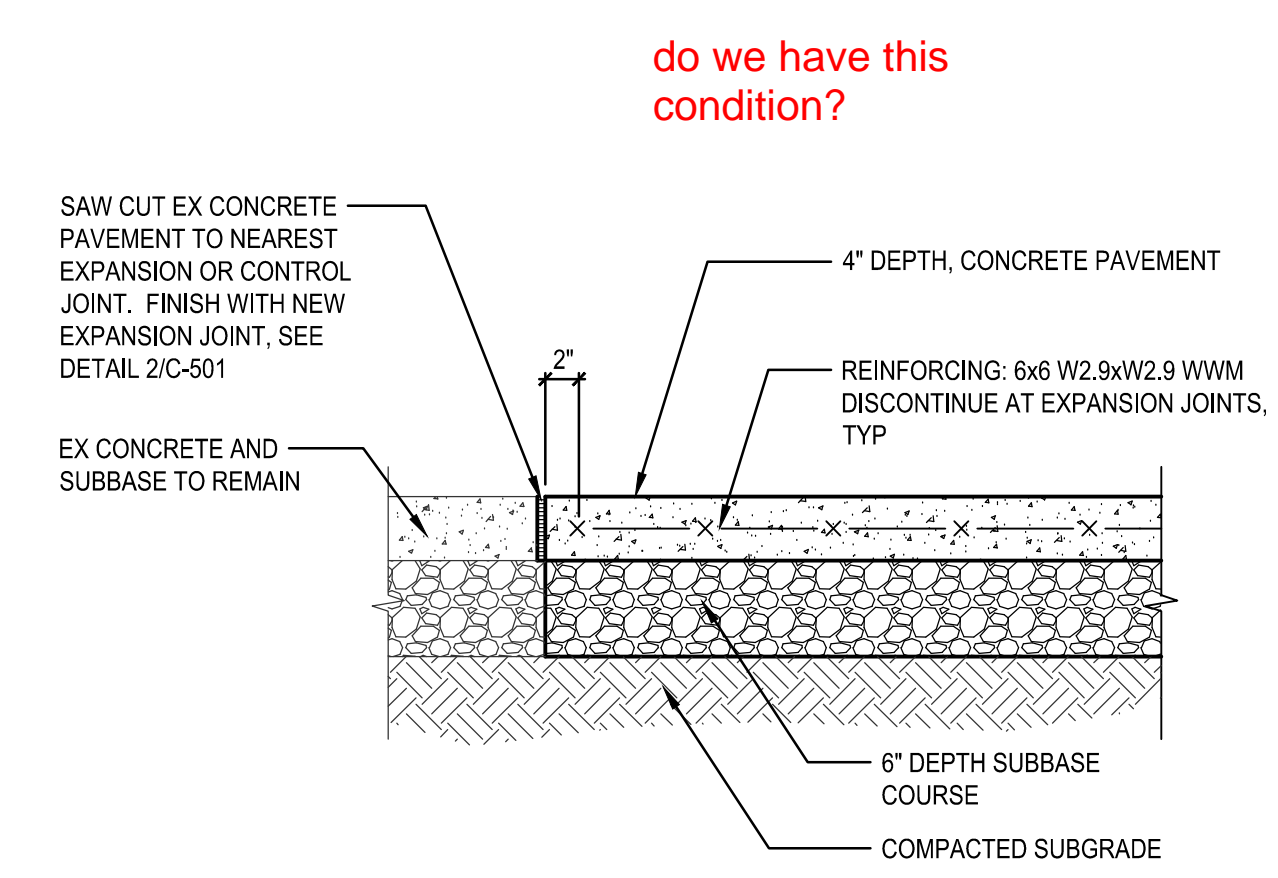
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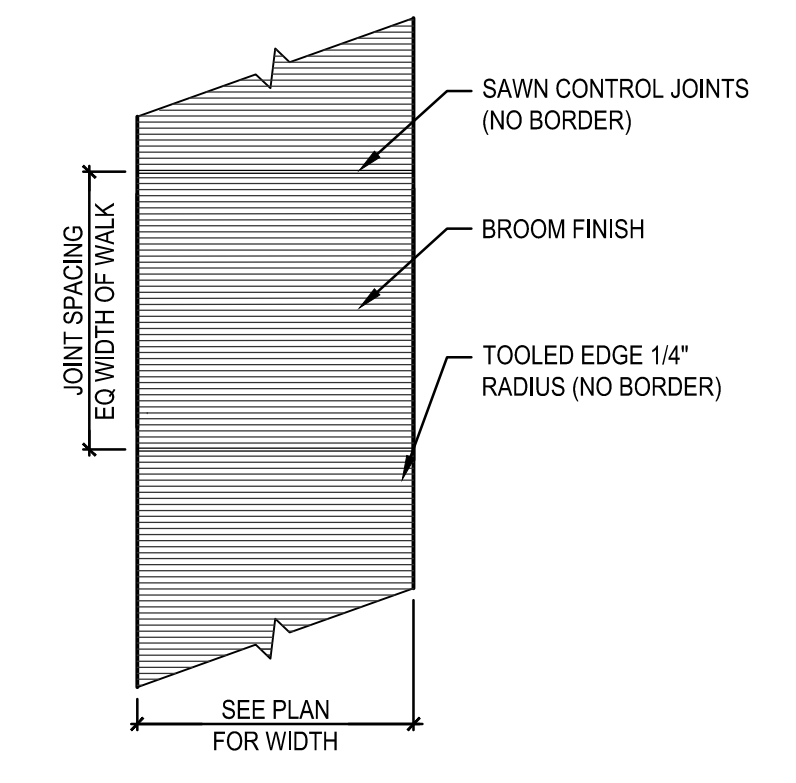
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**SITE IMPROVEMENT
DETAILS**

C-501




4 CONCRETE PAVEMENT JOINT TO EXISTING
SCALE: NONE




- NOTES:**
1. PROVIDE BROOM FINISH IN ONE DIRECTION PERPENDICULAR TO DIRECTION OF TRAFFIC.
 2. WINDOW PANE BORDERS AT EDGE OF PAVEMENT AND AT JOINTS IS NOT PERMITTED.


3 CONCRETE PAVEMENT FINISH
SCALE: NONE

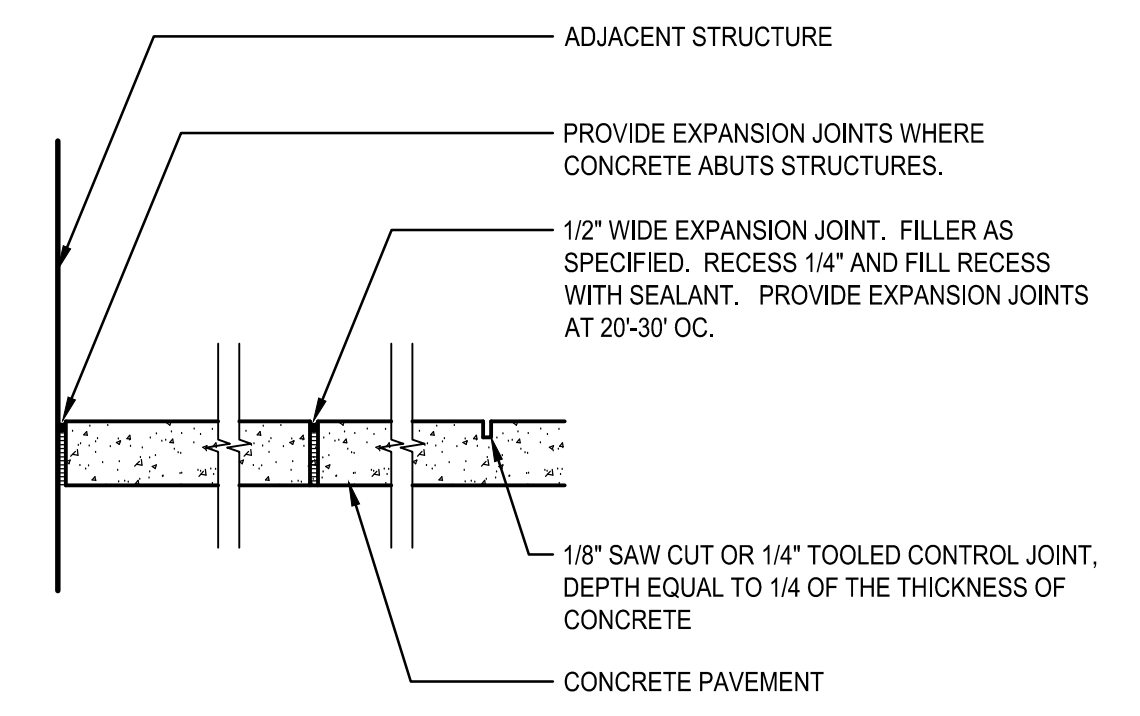


2 CONCRETE PAVEMENT JOINTS
SCALE: NONE

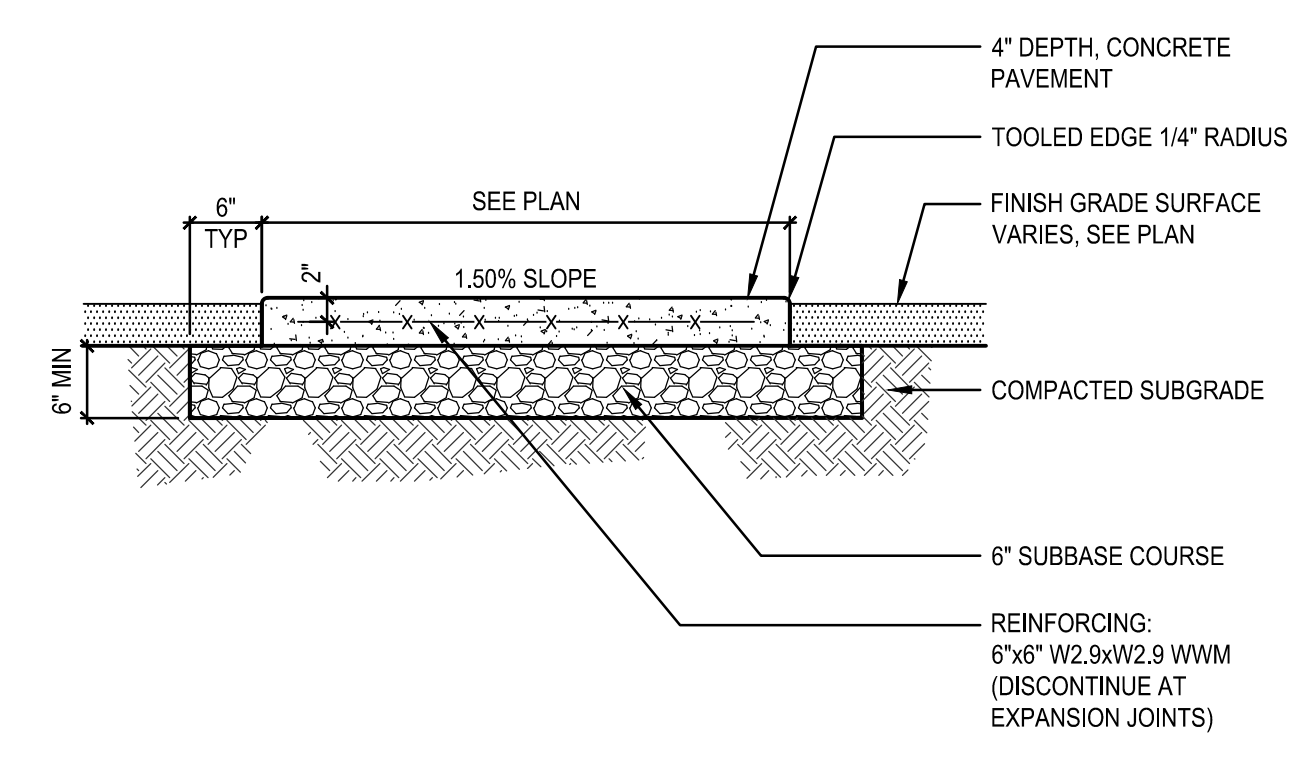

1 CONCRETE SIDEWALK
SCALE: NONE

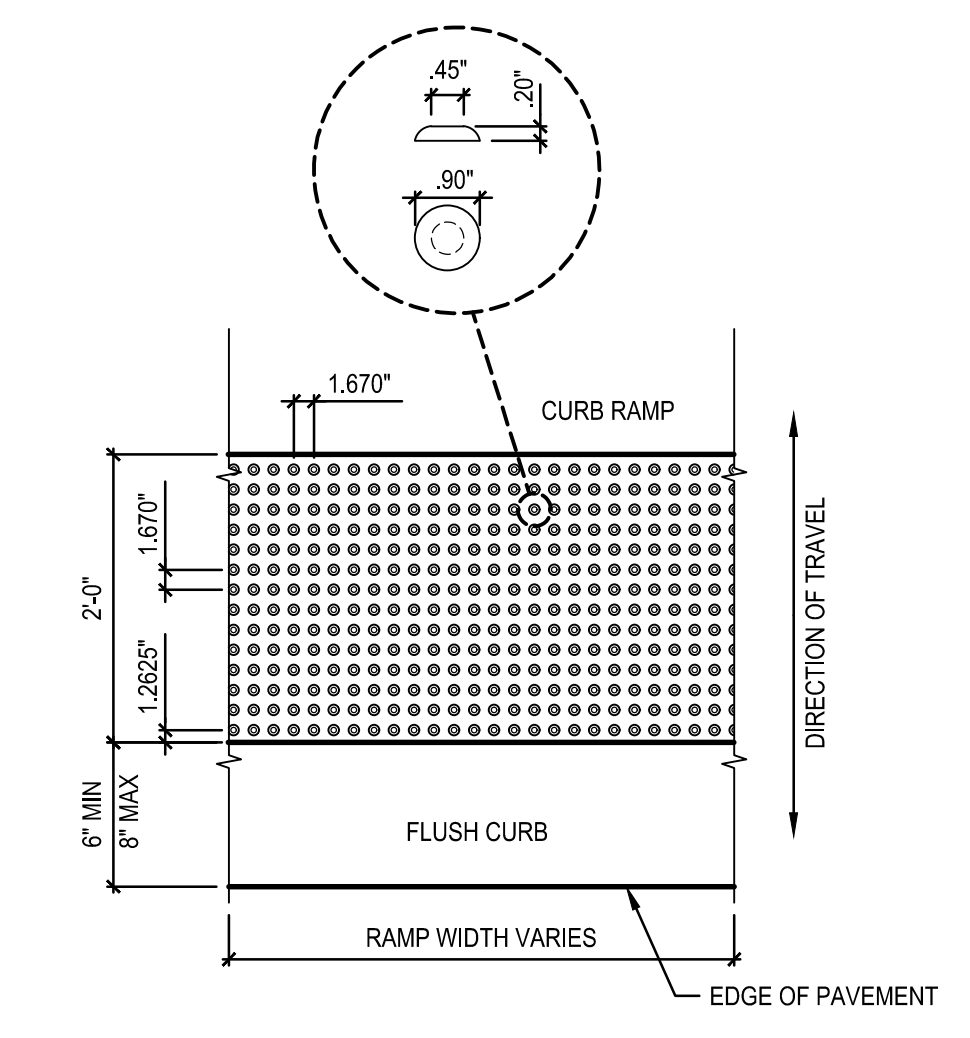


7 DETECTABLE WARNING STRIP
SCALE: NONE

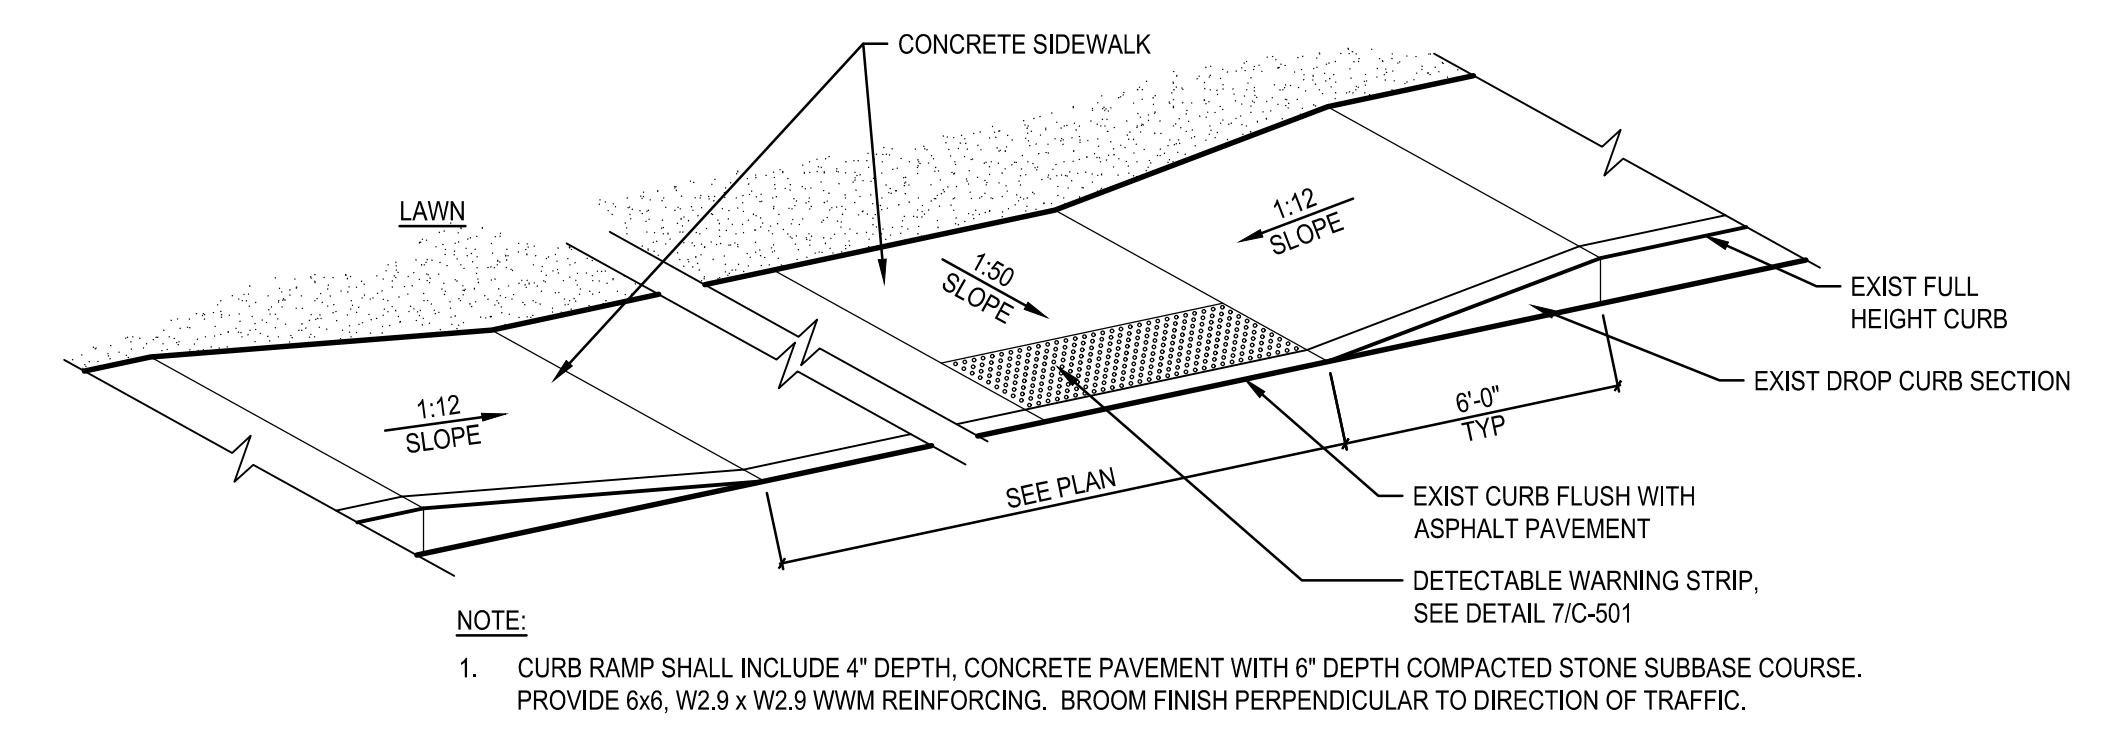


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1. CURB RAMP SHALL INCLUDE 4\"/>

6 ACCESSIBLE CURB RAMP - TYPE 2
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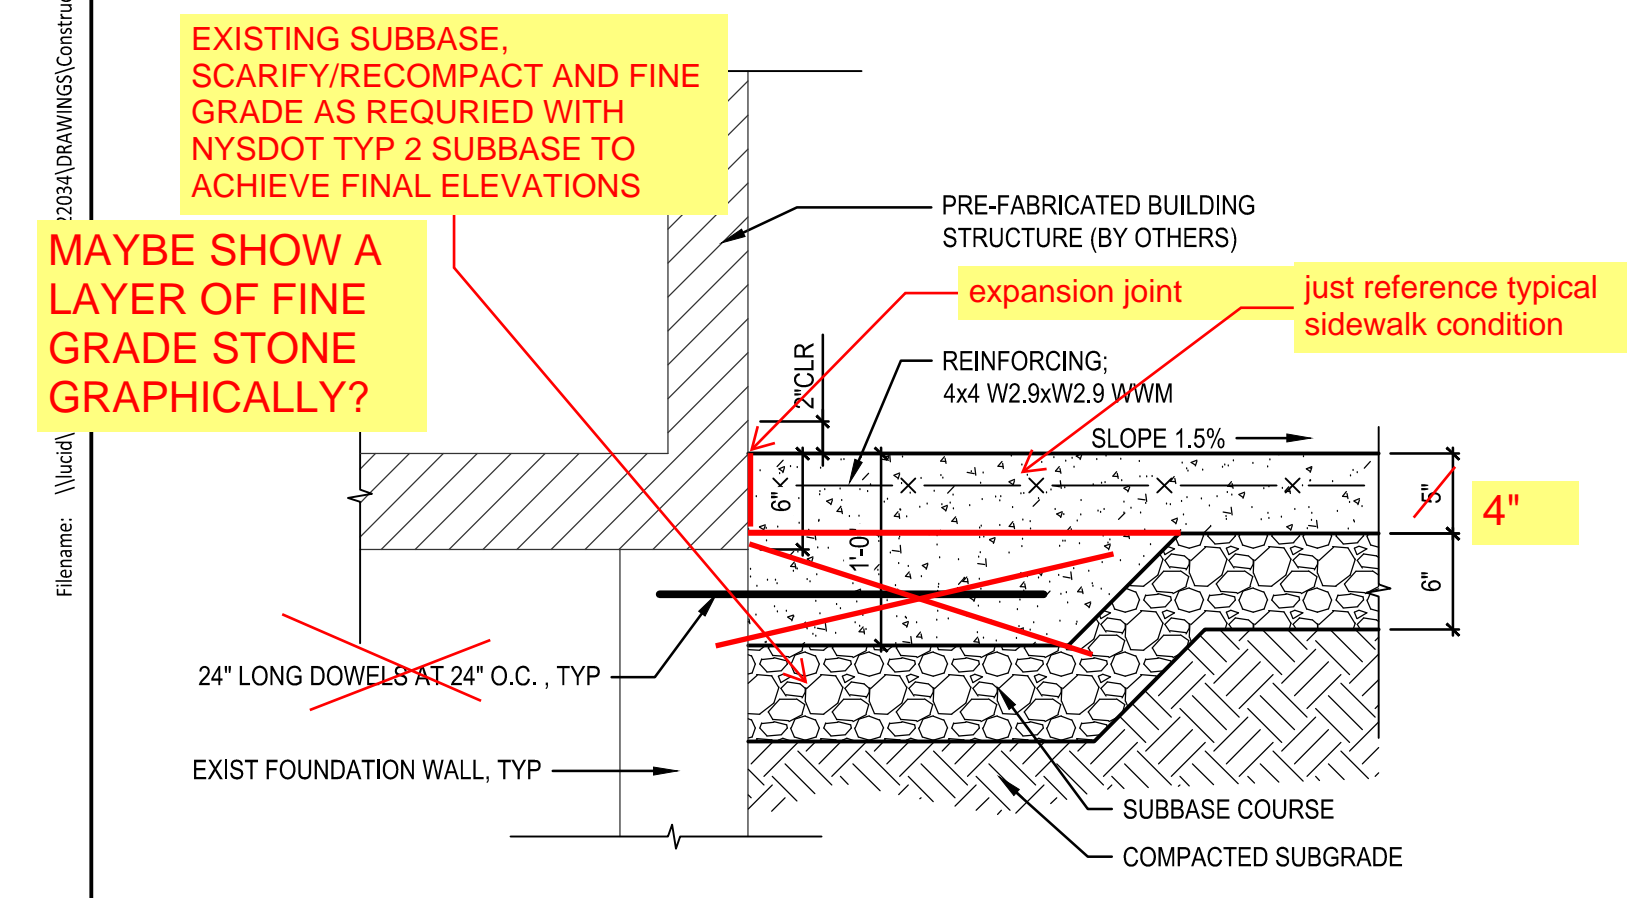
- NOTE:**
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5 ACCESSIBLE CURB RAMP - TYPE 1
SCALE: NONE

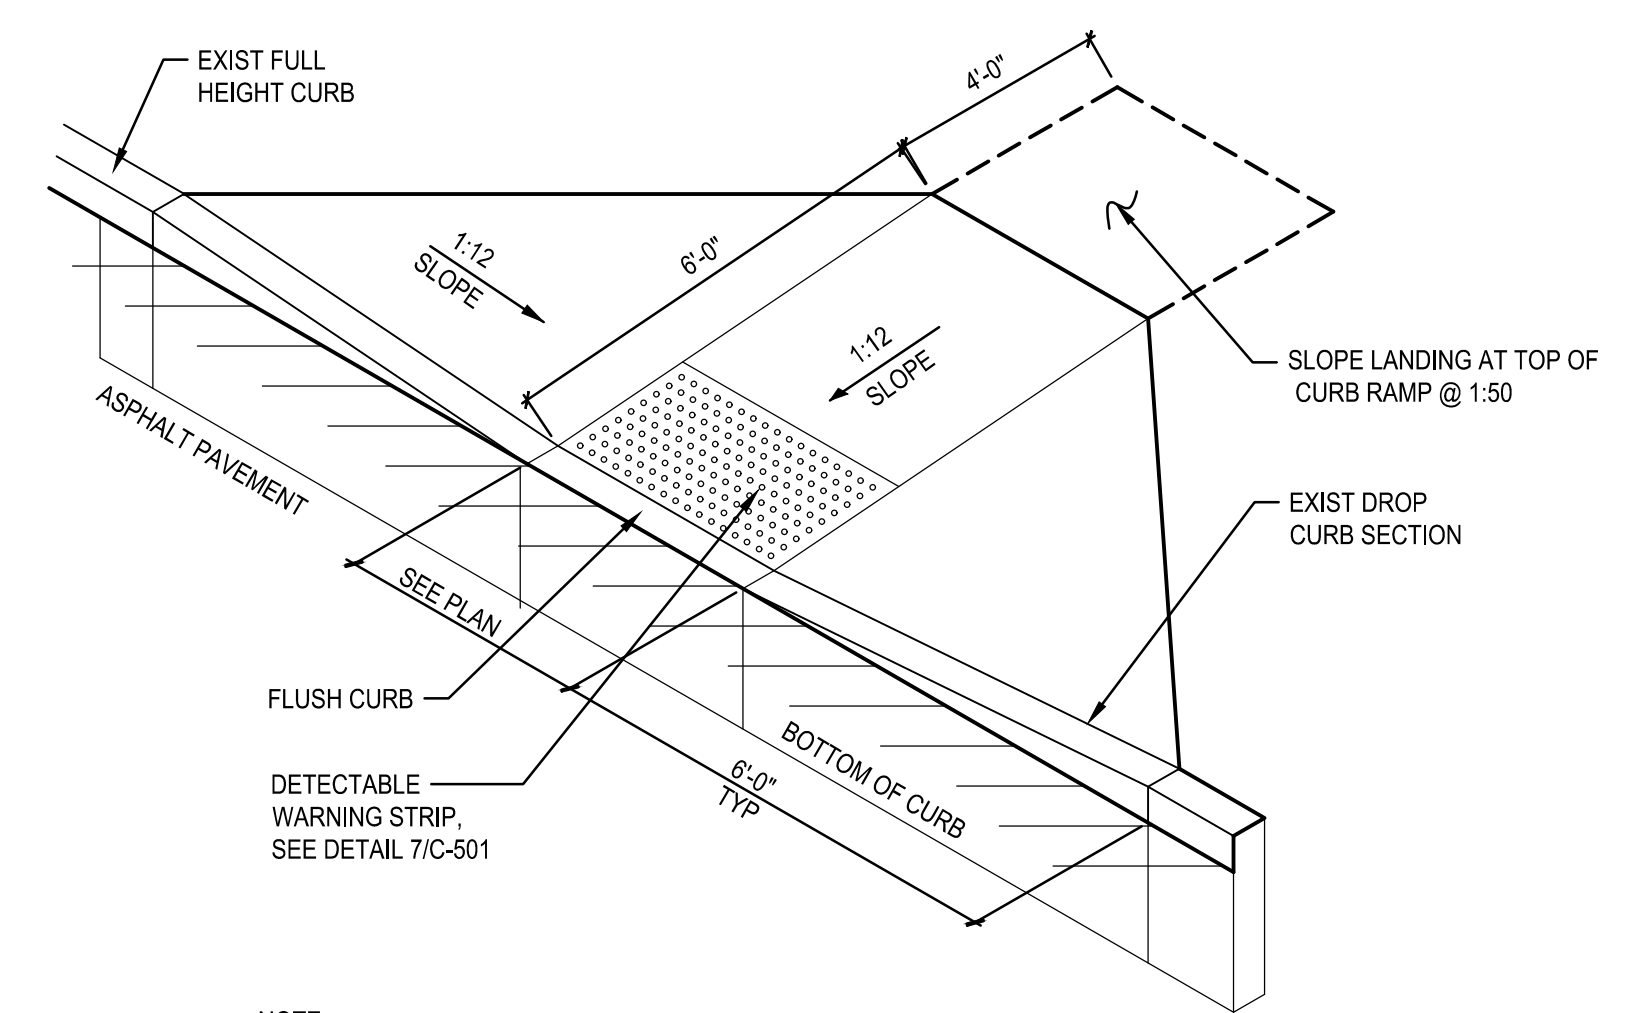

- NOTES:**
1. PROVIDE 4\"/>

9 LAWN RESTORATION
SCALE: NONE

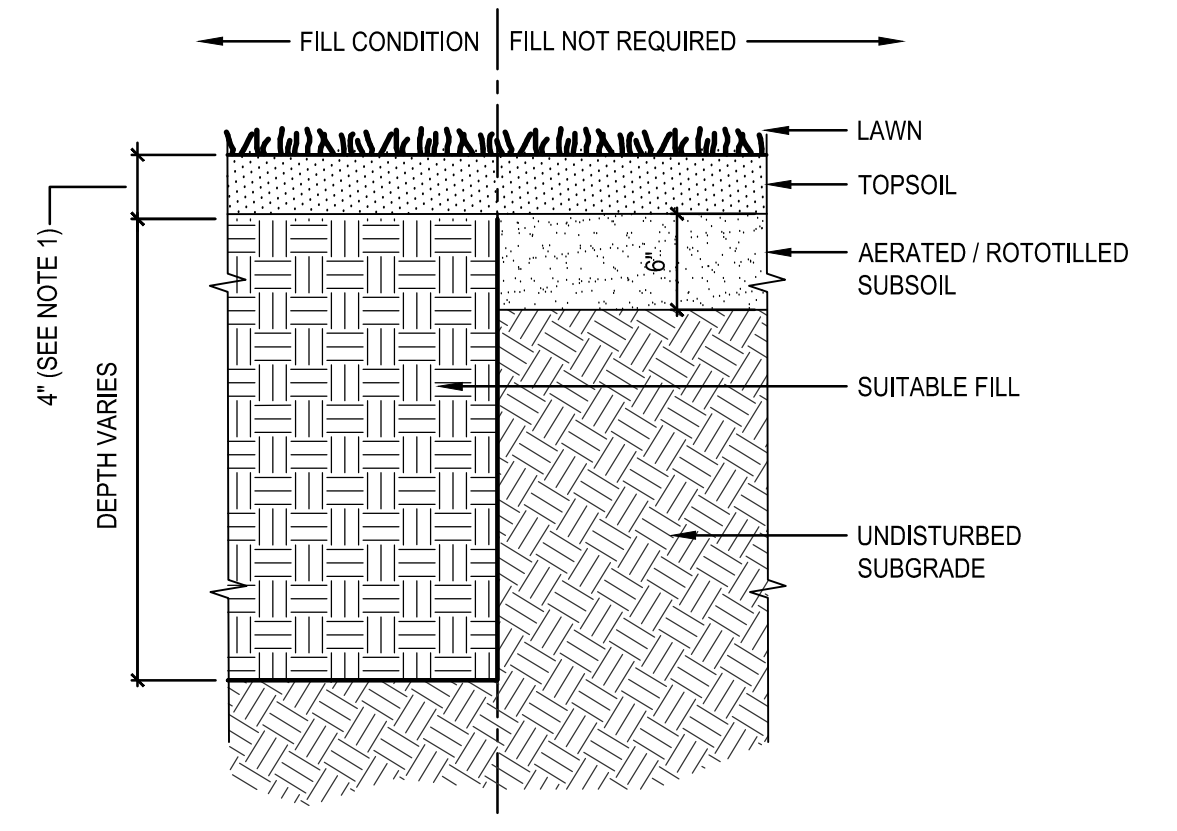

PROVIDE HAUNCHED AND DOWELED SIDEWALK TERMINATION AT ALL LOCATIONS WHERE SIDEWALK MEETS FACE OF BUILDING OR DOOR LOCATIONS AS INDICATED ON PLAN

8 CONCRETE CONNECTION AT BUILDINGS
SCALE: NONE

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