


CATTARAUGUS COUNTY PINES MACHIAS FIRE ALARM 9822 ROUTE 16 MACHIAS, NEW YORK

DESIGN DEVELOPEMNT 07/05/2019



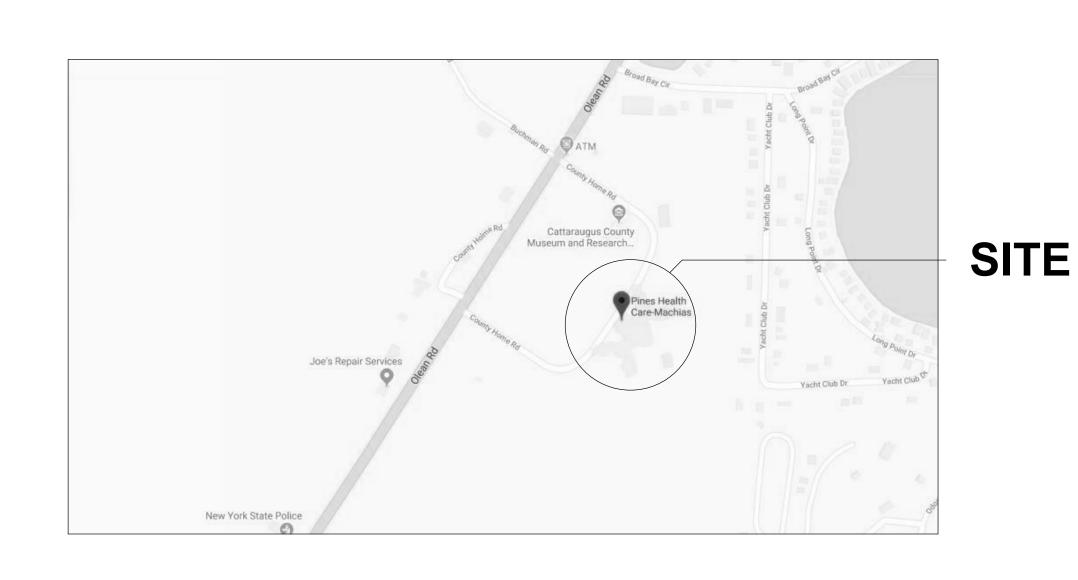

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DRAWING NUMBER SHEET TITLE		
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ED-101	FIRST FLOOR - REMOVALS - AREA "A"	
ED-102	FIRST FLOOR - REMOVALS - AREA "B"	
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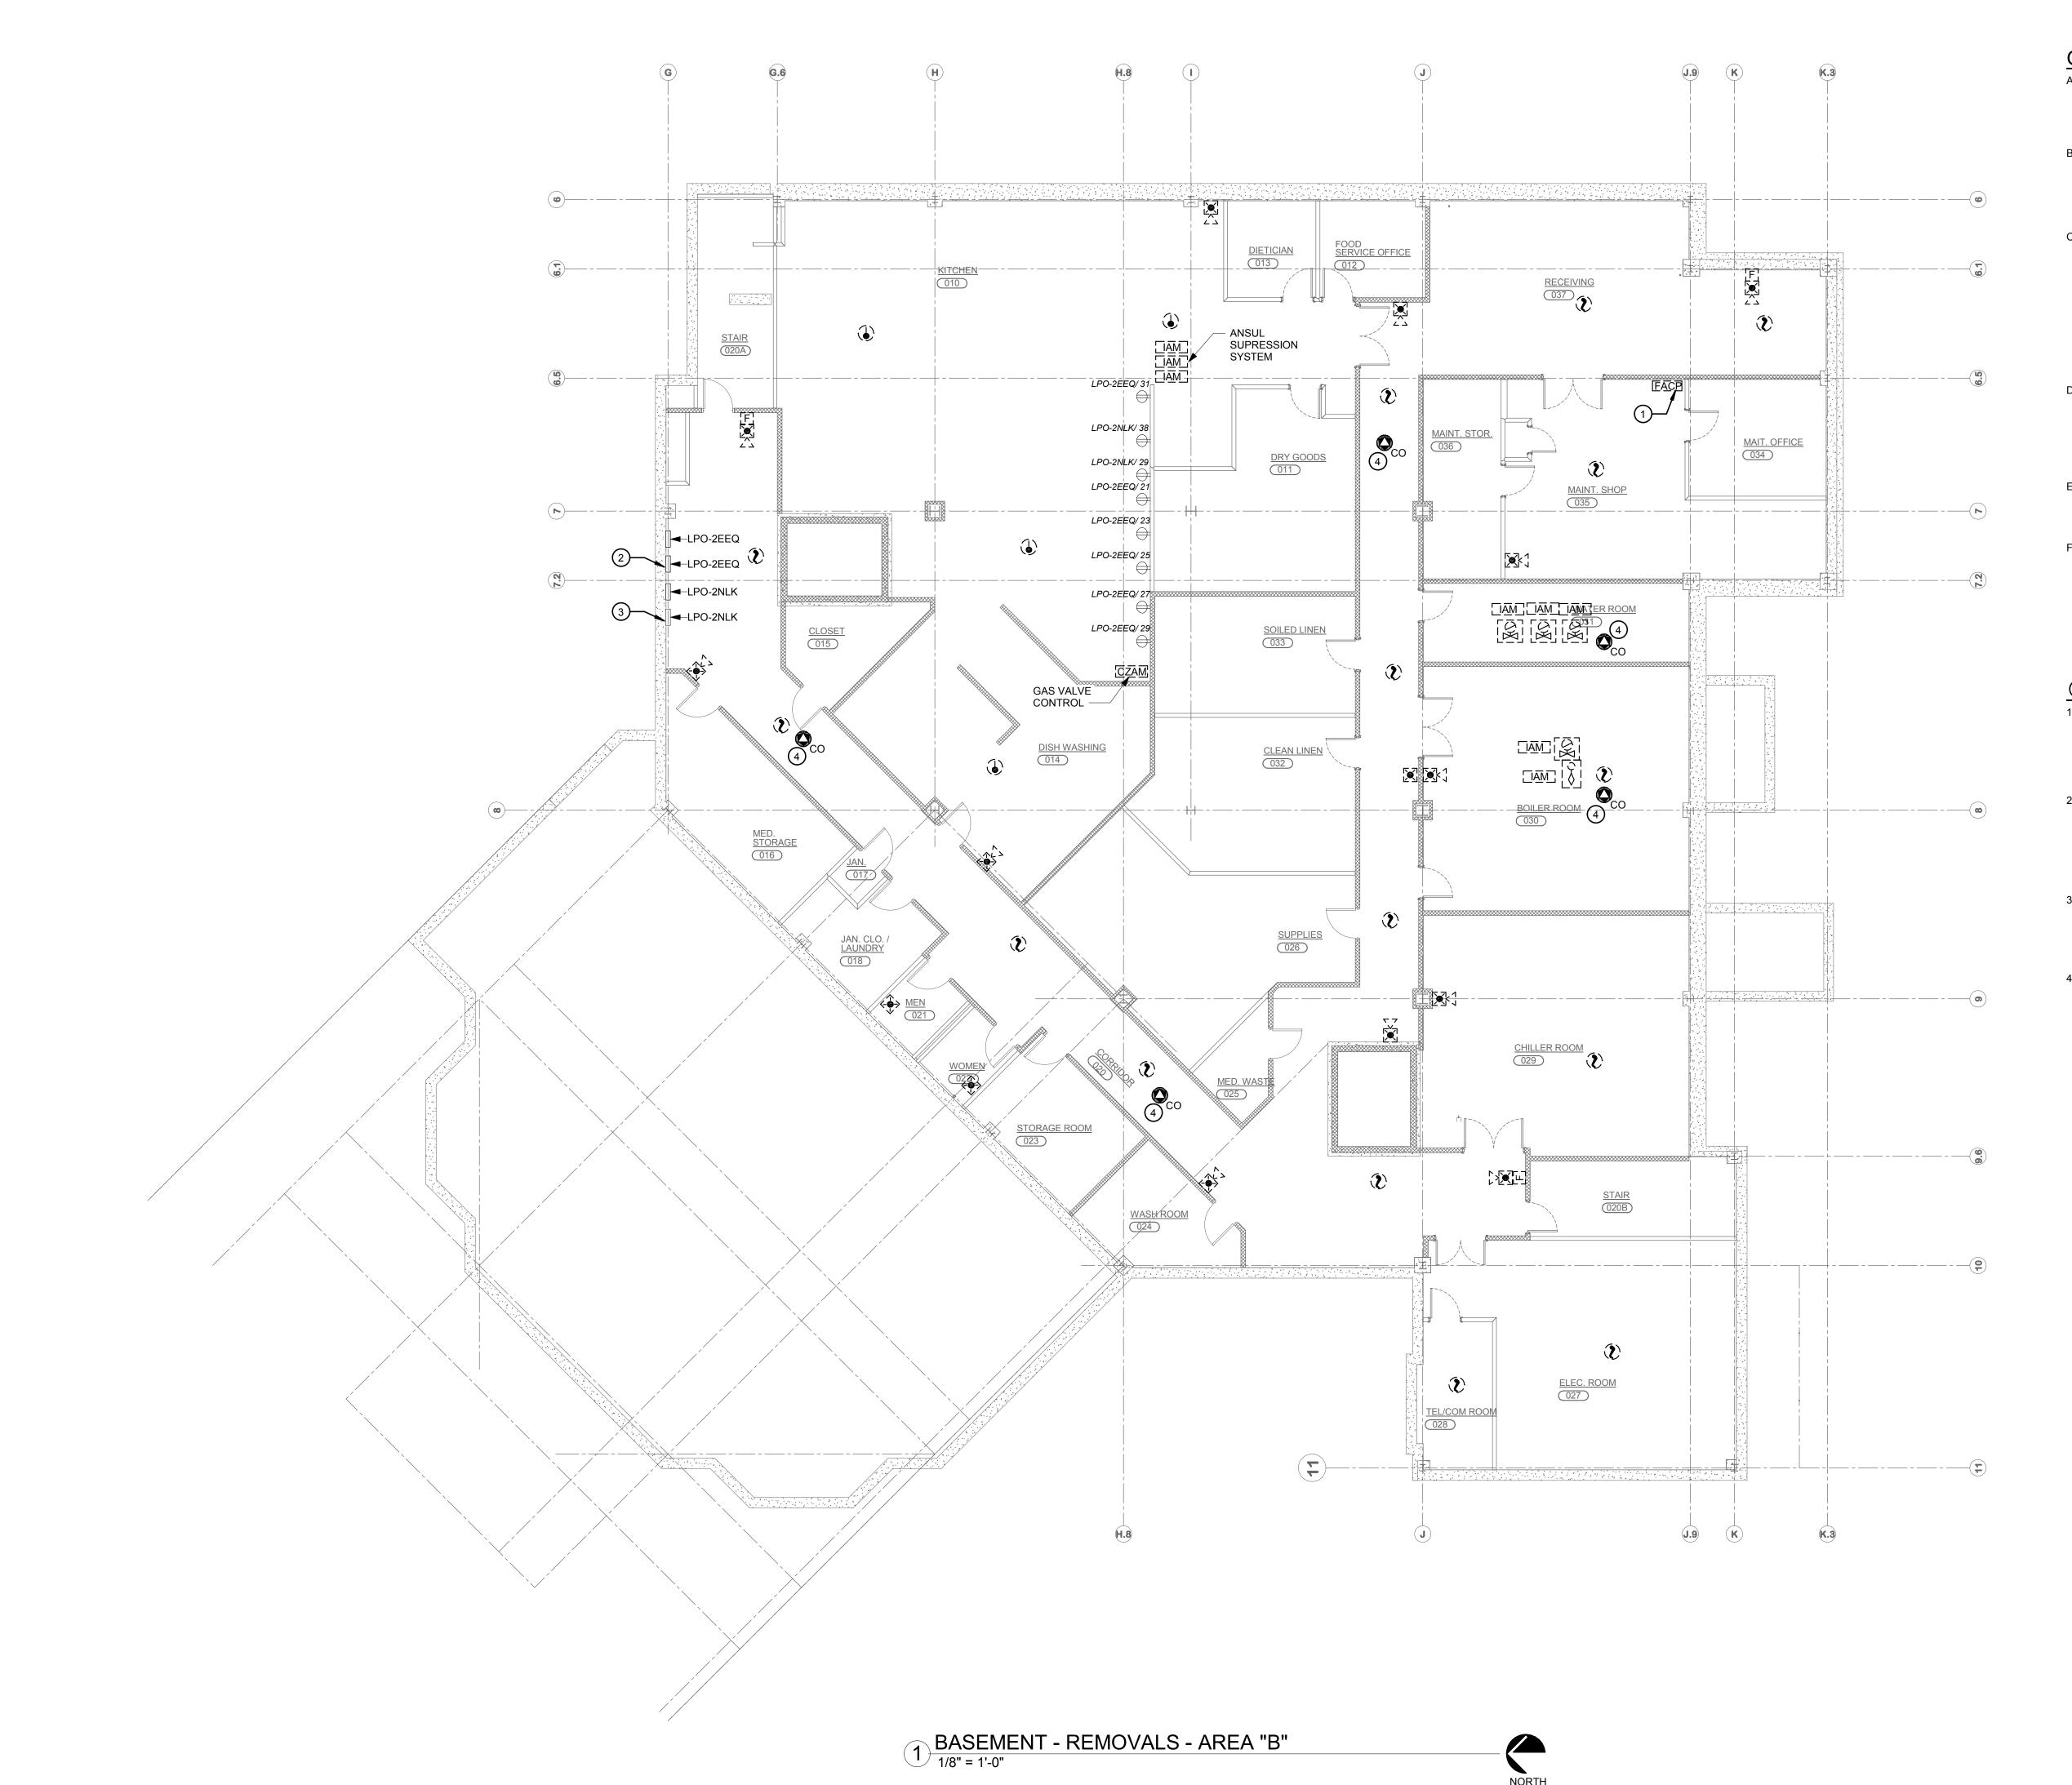
Wendel Project No. 123456

CATTARAUGUS COUNTY

CATTARAUGUS COUNTY PINES MACHIAS FIRE ALARM

DESIGN DEVELOPEMNT





- A. MAINTAIN INTEGRITY OF EXISTING CIRCUIT WIRING PRESENTLY INSTALLED AND SERVING EQUIPMENT OUTSIDE THE WORK AREA. VERIFY ROUTE OF EACH FEEDER AND BRANCH CIRCUIT SCHEDULED FOR REMOVAL.
- B. PROVIDE PROTECTION FOR ALL EXISTING
 CONSTRUCTION SYSTEMS/EQUIPMENT SCHEDULED TO
 REMAIN DURING CONSTRUCTION. CONTRACTOR SHALL
 BE RESPONSIBLE FOR REPLACEMENT OR
 RECONDITIONING OF EQUIPMENT/ITEMS DAMAGED
 DURING REMOVALS.
- C. FIRE ALARM AND SECURITY SYSTEMS SHALL REMAIN OPERATIONAL DURING CONSTRUCTION. PROVIDE TEMPORARY WIRING AS REQUIRED TO MAINTAIN FIRE ALARM SYSTEM DETECTION/NOTIFICATION THROUGHOUT CONSTRUCTION PHASE AND OPERATION OF SECURITY SYSTEM. NOTIFY OWNER OF AREAS TO BE SHUTDOWN WHILE WORK IS BEING PREFORMED. FIRE ALARM AND SECURITY SYSTEMS SHALL BE FULLY OPERATIONAL AT END OF EACH WORK DAY. CONTRACTOR SHALL NOTE LEAVE ANY AREAS WITHOUT FIRE ALARM SYSTEM BEING FULLY FUNCTIONAL AND SECURITY SYSTEM FULLY OPERATIONAL.
- D. UNLESS OTHERWISE NOTED, DISCONNECT AND REMOVE ALL ELECTRICAL WORK ASSOCIATED WITH DEVICE/FIXTURE SCHEDULED FOR REMOVAL. ASSOCIATED ELECTRICAL WORK SHALL INCLUDE BUT NOT LIMITED TO CONDUCTORS, CONDUIT, BOXES, CONNECTORS, HANGERS, CONTROL EQUIPMENT, ETC. BACK TO SOURCE PANEL.
- E. CONTRACTOR SHALL PROPERLY DISPOSE OF ALL ELECTRICAL DEVICES AND MISC. ITEMS AS REQUIRED. CONTRACTOR IS RESPONSIBLE FOR ANY COST ASSOCIATED WITH DISPOSAL.
- F. DEMOLITION SHOWN SHALL BE SELECTIVE. UNLESS OTHERWISE INDICATED ON THE PLAN. THE CONTRACTOR SHALL NOTIFY THE ENGINEER OF DISCREPANCIES FOUND IN THE FIELD PRIOR TO DEMOLITION OF ANY ITEMS NOT SHOWN. CONTRACTOR SHALL, AT HIS EXPENSE, REPLACE OR REPAIR ANY DEMOLISHED ITEMS(S) THAT WERE NOT CALLED FOR ON THE PLANS OR BROUGHT TO ENGINEERS ATTENTION.

REMOVAL NOTES:

- DISCONNECT AND REMOVE FIRE ALARM SYSTEM, PANEL, DEVICES AND ALL ITS ASSOCIATED ELECTRICAL WORK IN ITS ENTIRETY. CONNECTION TO WANDERGUARD DOORS (3 TOTAL) ACCESS CONTROL SYSTEM, BMS SYSTEM AND TELEPHONE LINES SHALL REMAIN FOR EXTENSION AND RECONNECTION TO NEW.
- 2. DISCONNECT AND REMOVE BRANCH CIRCUIT BREAKERS 21, 23, 25, 27, 29, AND 31, AND TURN OVER TO OWNER. PROVIDE 24VDC SHUT TRIP TYPE 20A/1P BREAKERS IN PLACE OF THREE (3) REMOVED AND EXTEND THREE OTHER CIRCUITS TO ADJACENT PANEL. RECONNECT EXISTING BRANCH CIRCUIT WIRING AND PROVIDE 2#12+# 12EG IN 3/4" CONDUIT AS REQURIED FOR EXTENDED CIRCUITS.
- 3. DISCONNECT AND REMOVE BRANCH CIRCUIT BREAKERS 29, AND 31, AND TURN OVER TO OWNER. PROVIDE 24VDC SHUT TRIP TYPE 20A/1P BREAKERS IN PLACE OF REMOVED AND RECONNECT EXISTING BRANCH CIRCUIT WIRING.
- 4. DISCONNECT AND REMOVE BATTERY OPERATED CO DETECTOR AND TURN OVER TO OWNER.



CATTARAUGUS COUNTY

9822 ROUTE 16 MACHIAS, NEW YORK

CATTARAUGUS COUNTY
PINES MACHIAS FIRE
ALARM
DESIGN DEVELOPEMNT



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NO. REVISIONS DATE

BASEMENT - REMOVALS - AREA "B"

GENERIC SCALE BAR

SCALE BAR SHOWN IS TWO INCHES ON THE ORIGINAL DRAWING.
IF NOT TWO INCHES ON THIS SHEET, ADJUST ACCORDINGLY

DATE 07/05/2019

SCALE 1/8" = 1'-0"

DWN. JJR

PROJ. No. 307663

ED-100

CHK. CDW



- A. MAINTAIN INTEGRITY OF EXISTING CIRCUIT WIRING PRESENTLY INSTALLED AND SERVING EQUIPMENT OUTSIDE THE WORK AREA. VERIFY ROUTE OF EACH FEEDER AND BRANCH CIRCUIT SCHEDULED FOR REMOVAL.
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REMOVAL NOTES:

- 1. DISCONNECT AND REMOVE FIRE ALARM SYSTEM WIRING AND POWER TO MAGNETIC DOOR HOLDERS IN THEIR ENTIRETY BACK TO SOURCE. DOOR HOLDERS SHALL REMAIN FOR CONNECITON TO NEW SYSTEM.
- 2. DISCONNECT AND REMOVE FIRE ALARM ADDRESSABLE INPUT MODULE, MONITORING SECURITY DOOR. EXISTING WIRING SHALL REMAIN FOR RECONNECTION TO NEW MODULE.



CATTARAUGUS COUNTY

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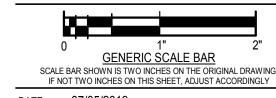
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DWG. TITLE

FIRST FLOOR - REMOVALS - AREA "A"




DATE 07/05/2019

SCALE 1/8" = 1'-0"

DWN. CDW

DWN. CDW CHK. JJR
PROJ. No. 307663

ED-101

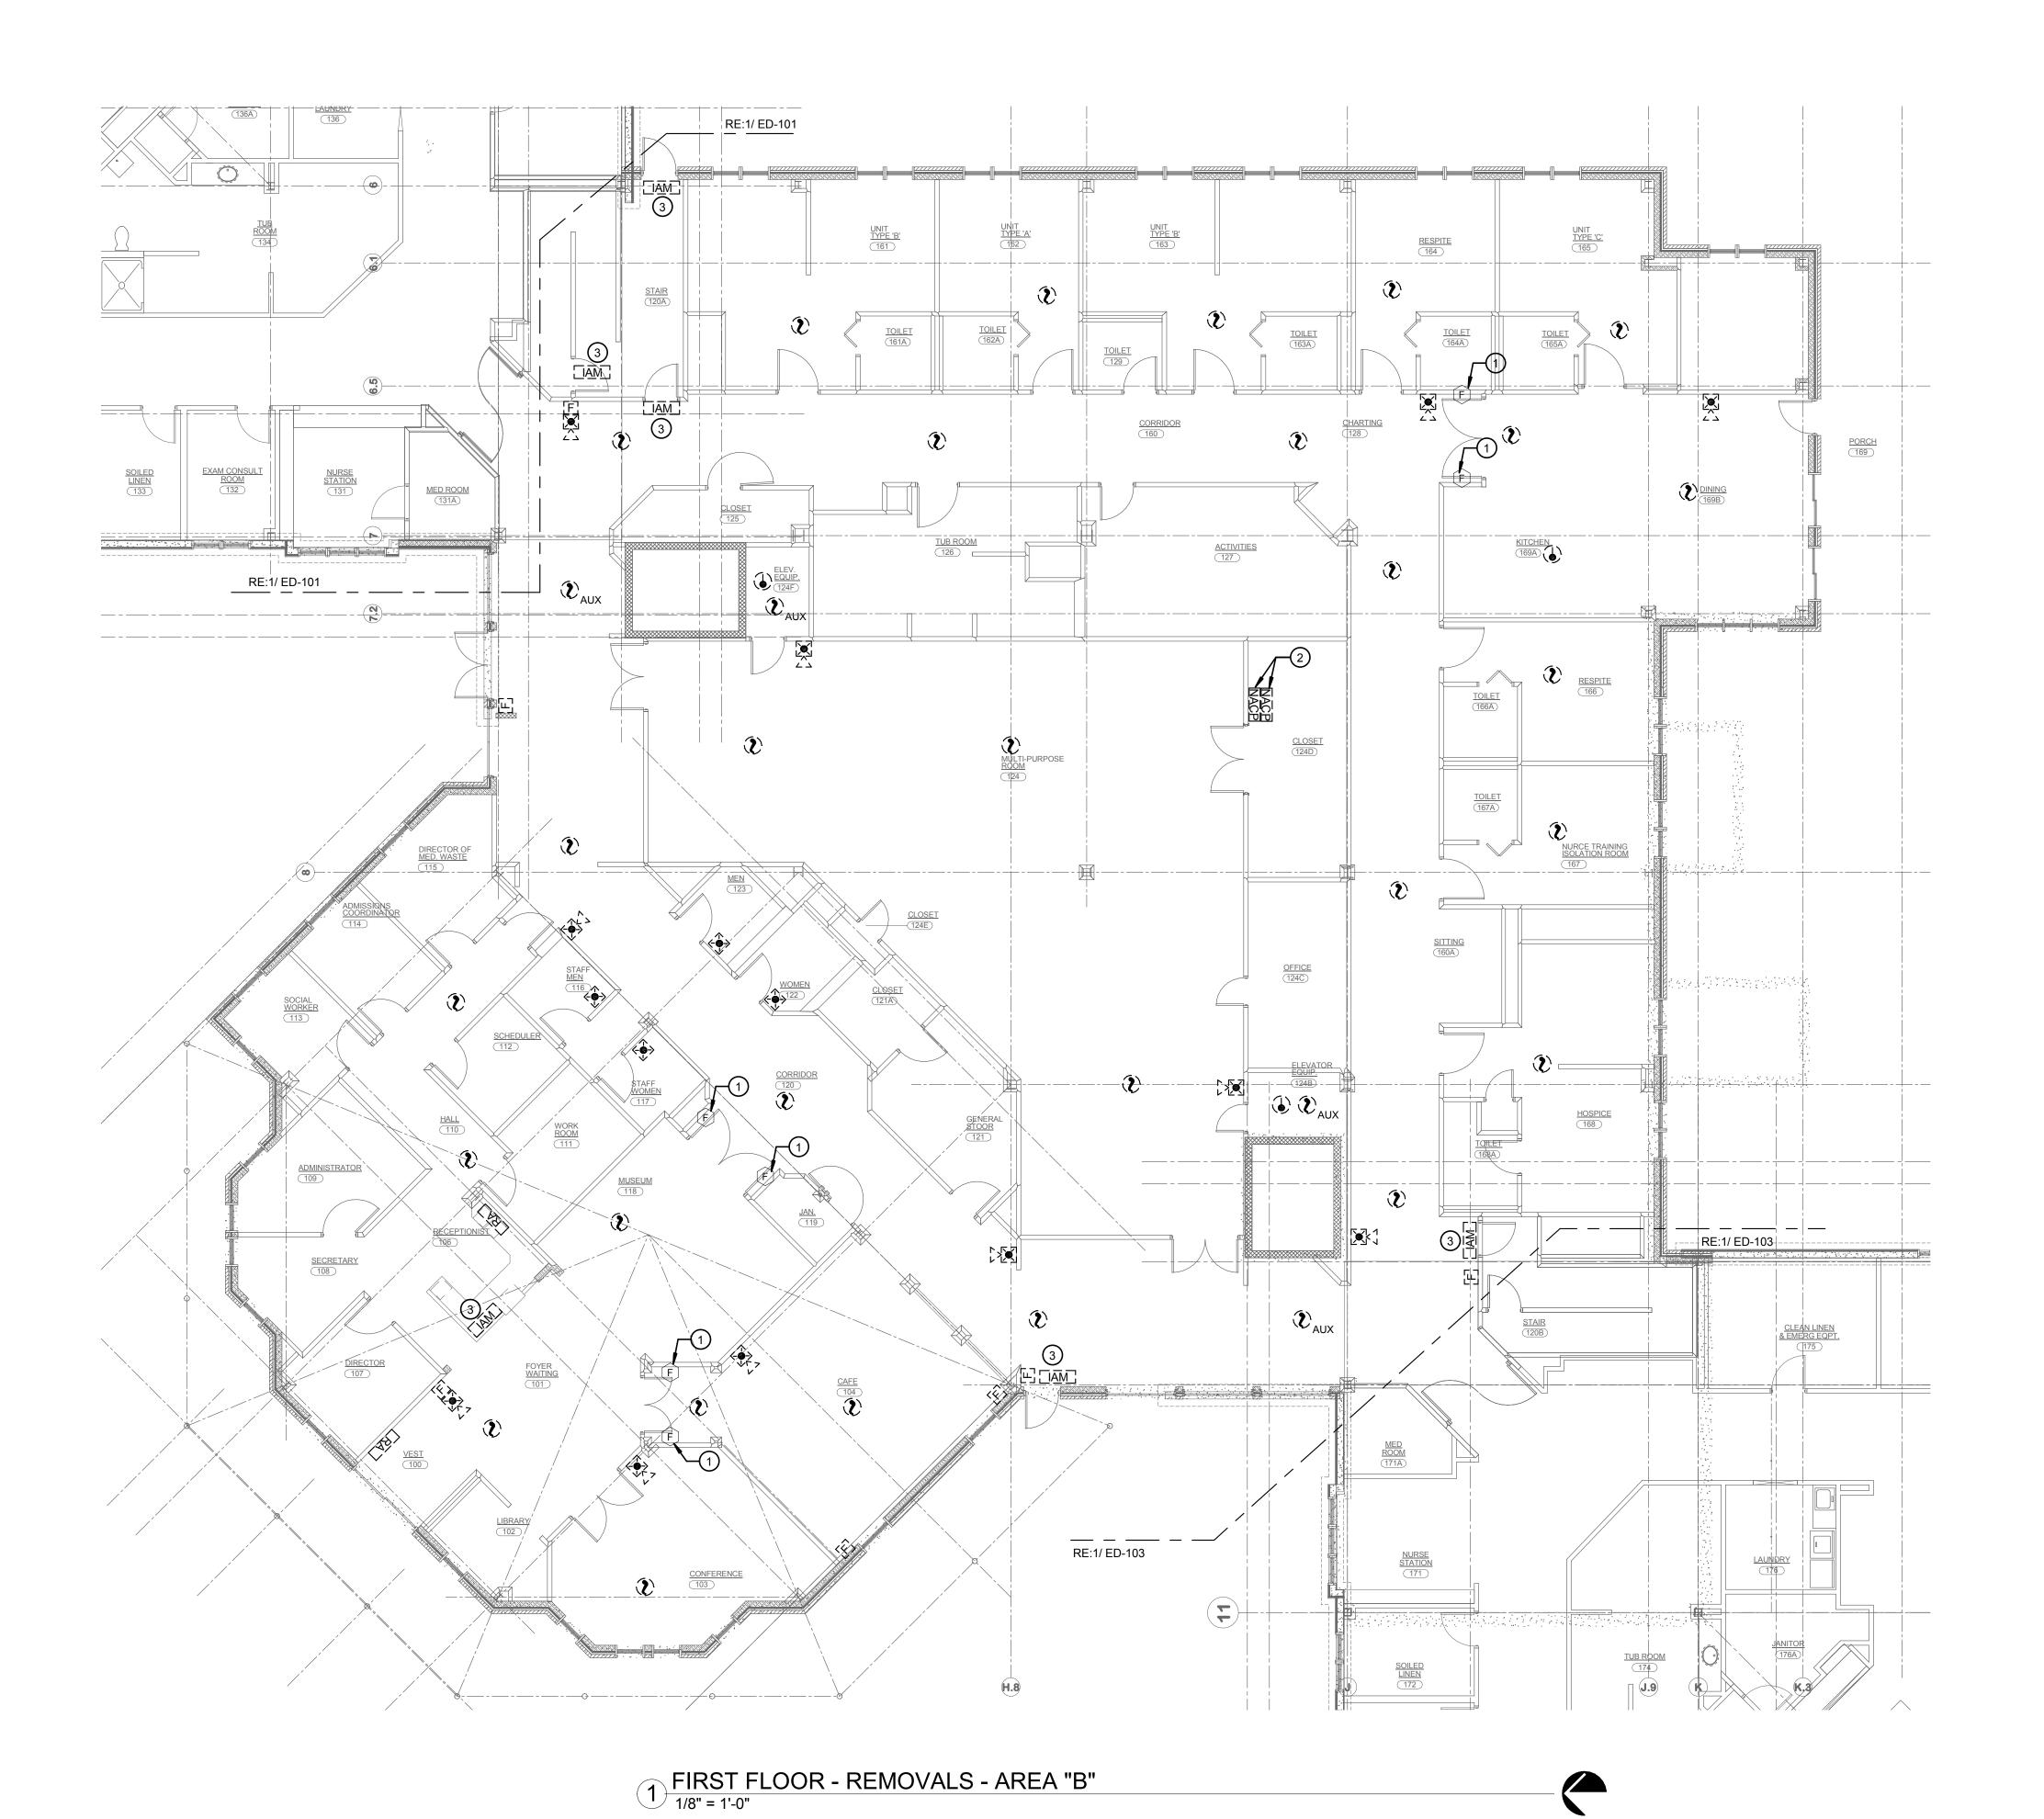

- A. MAINTAIN INTEGRITY OF EXISTING CIRCUIT WIRING PRESENTLY INSTALLED AND SERVING EQUIPMENT OUTSIDE THE WORK AREA. VERIFY ROUTE OF EACH FEEDER AND BRANCH CIRCUIT SCHEDULED FOR REMOVAL.
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- 2. DISCONNECT AND REMOVE NOTIFICATION APPLIANCE POWER PANEL AND ALL ITS ASSOCIATED ELECTRICAL WORK IN ITS ENTIRETY BACK TO SOURCE PANEL. EMERGENCY BRANCH CIRCUIT SERVING PANELS SHALL REMAIN FOR RECONNECTION AND USE BY NEW.
- 3. DISCONNECT AND REMOVE FIRE ALARM ADDRESSABLE INPUT MODULE, MONITORING SECURITY DOOR. EXISTING WIRING SHALL REMAIN FOR RECONNECTION TO NEW MODULE.



CATTARAUGUS COUNTY

9822 ROUTE 16 MACHIAS, NEW YORK


CATTARAUGUS COUNTY PINES MACHIAS FIRE **ALARM DESIGN DEVELOPEMNT**



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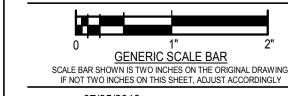
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DWG. TITLE


FIRST FLOOR - REMOVALS -AREA "B"

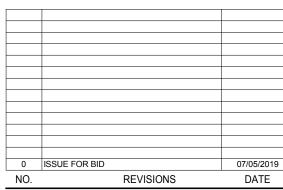

DATE 07/05/2019 SCALE 1/8" = 1'-0" DWN. CDW

PROJ. No. 307663

ED-102

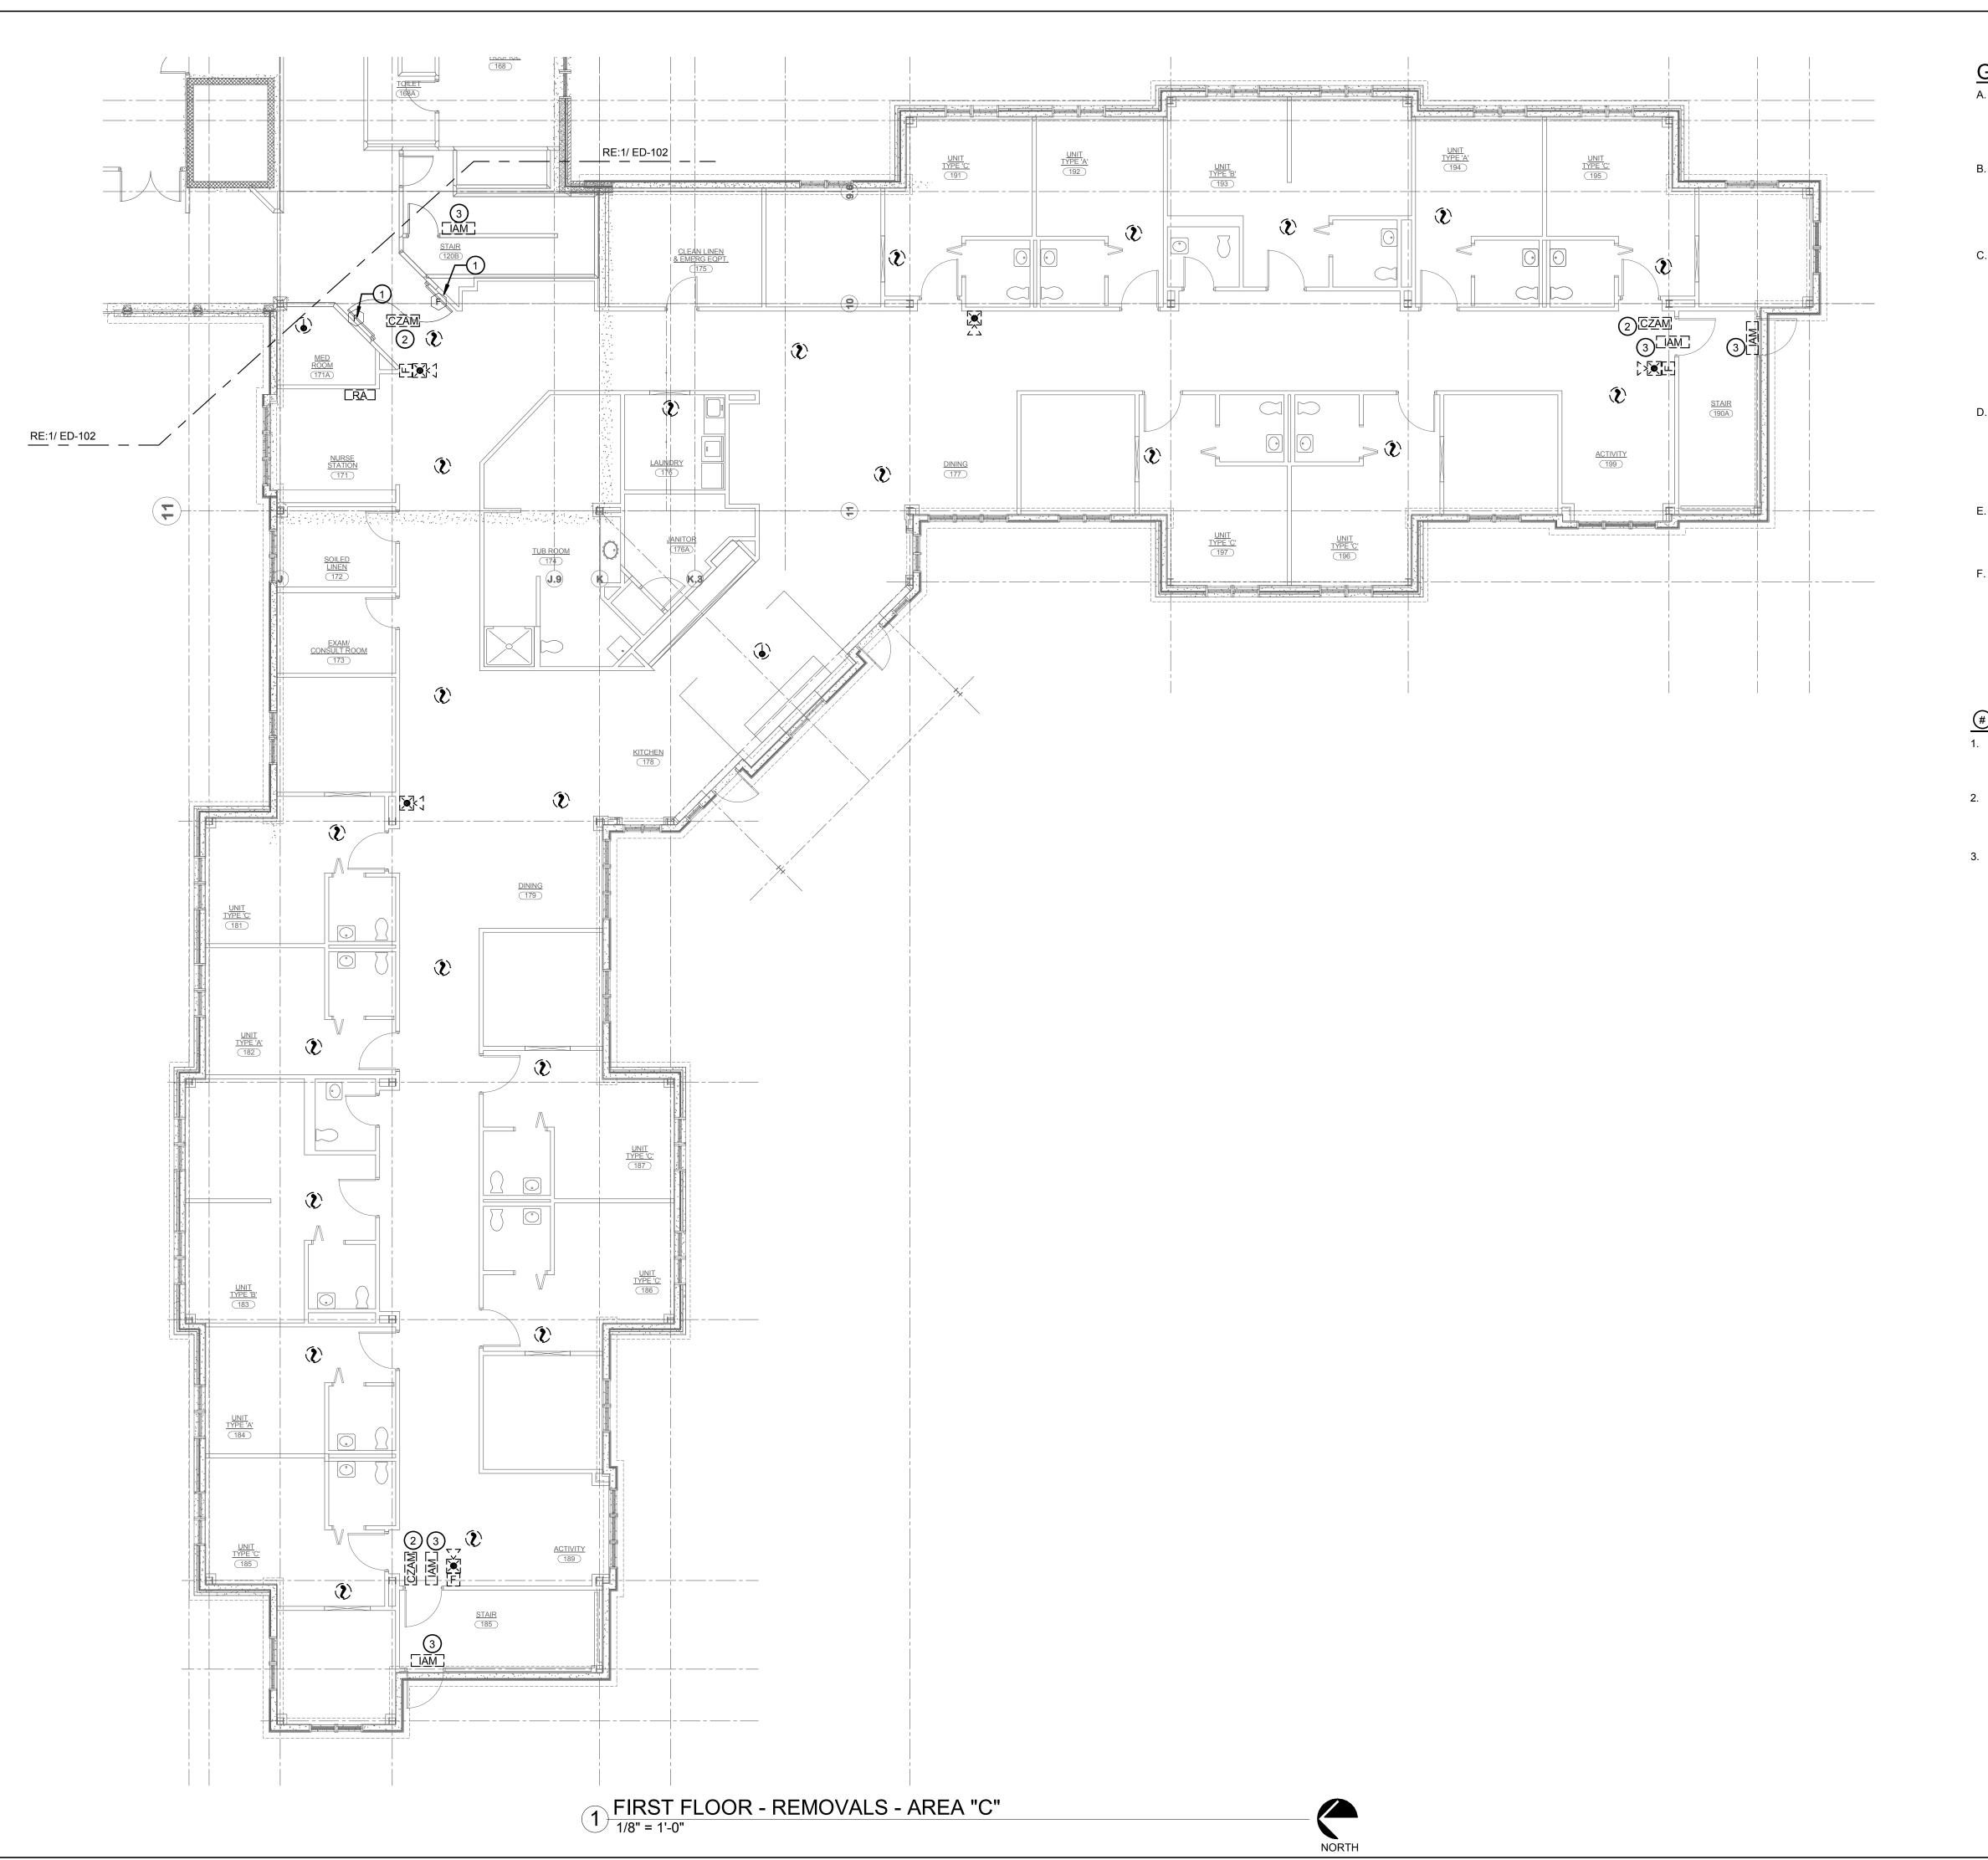

- A. MAINTAIN INTEGRITY OF EXISTING CIRCUIT WIRING PRESENTLY INSTALLED AND SERVING EQUIPMENT OUTSIDE THE WORK AREA. VERIFY ROUTE OF EACH FEEDER AND BRANCH CIRCUIT SCHEDULED FOR REMOVAL.
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REMOVAL NOTES:

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- 2. DISCONNECT FIRE ALARM SYSTEM CONNECTION AND CONTROL RELAY FROM WANDERGUARD SYSTEM DOOR CONTROLLER AND ALL ITS ASSOCIATED ELECTRICAL WORK IN ITS ENTIRETY BACK TO SOURCE PANEL.
- 3. DISCONNECT AND REMOVE FIRE ALARM ADDRESSABLE INPUT MODULE, MONITORING SECURITY DOOR. EXISTING WIRING SHALL REMAIN FOR RECONNECTION TO NEW MODULE.



CATTARAUGUS COUNTY

9822 ROUTE 16 MACHIAS, NEW YORK

CATTARAUGUS COUNTY PINES MACHIAS FIRE **ALARM DESIGN DEVELOPEMNT**



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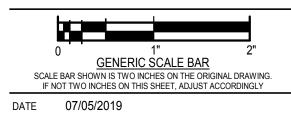
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NO.		REVISIONS	DATE

FIRST FLOOR - REMOVALS -AREA "C"



SCALE 1/8" = 1'-0" DWN. CDW PROJ. No. 307663

ED-103



- A. MAINTAIN INTEGRITY OF EXISTING CIRCUIT WIRING PRESENTLY INSTALLED AND SERVING EQUIPMENT OUTSIDE THE WORK AREA. VERIFY ROUTE OF EACH FEEDER AND BRANCH CIRCUIT SCHEDULED FOR REMOVAL.
- B. PROVIDE PROTECTION FOR ALL EXISTING
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NO. REVISIONS DATE

DWG. TITLE

SECOND FLOOR - REMOVALS -

AREA "A"

0 1" 2"

GENERIC SCALE BAR

SCALE BAR SHOWN IS TWO INCHES ON THE ORIGINAL DRAWING.
IF NOT TWO INCHES ON THIS SHEET, ADJUST ACCORDINGLY

CHK. JJR


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DWN. CDW

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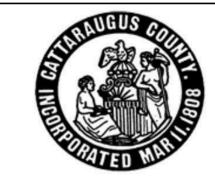
ED-104



- A. MAINTAIN INTEGRITY OF EXISTING CIRCUIT WIRING PRESENTLY INSTALLED AND SERVING EQUIPMENT OUTSIDE THE WORK AREA. VERIFY ROUTE OF EACH FEEDER AND BRANCH CIRCUIT SCHEDULED FOR REMOVAL.
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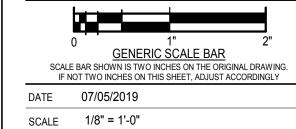
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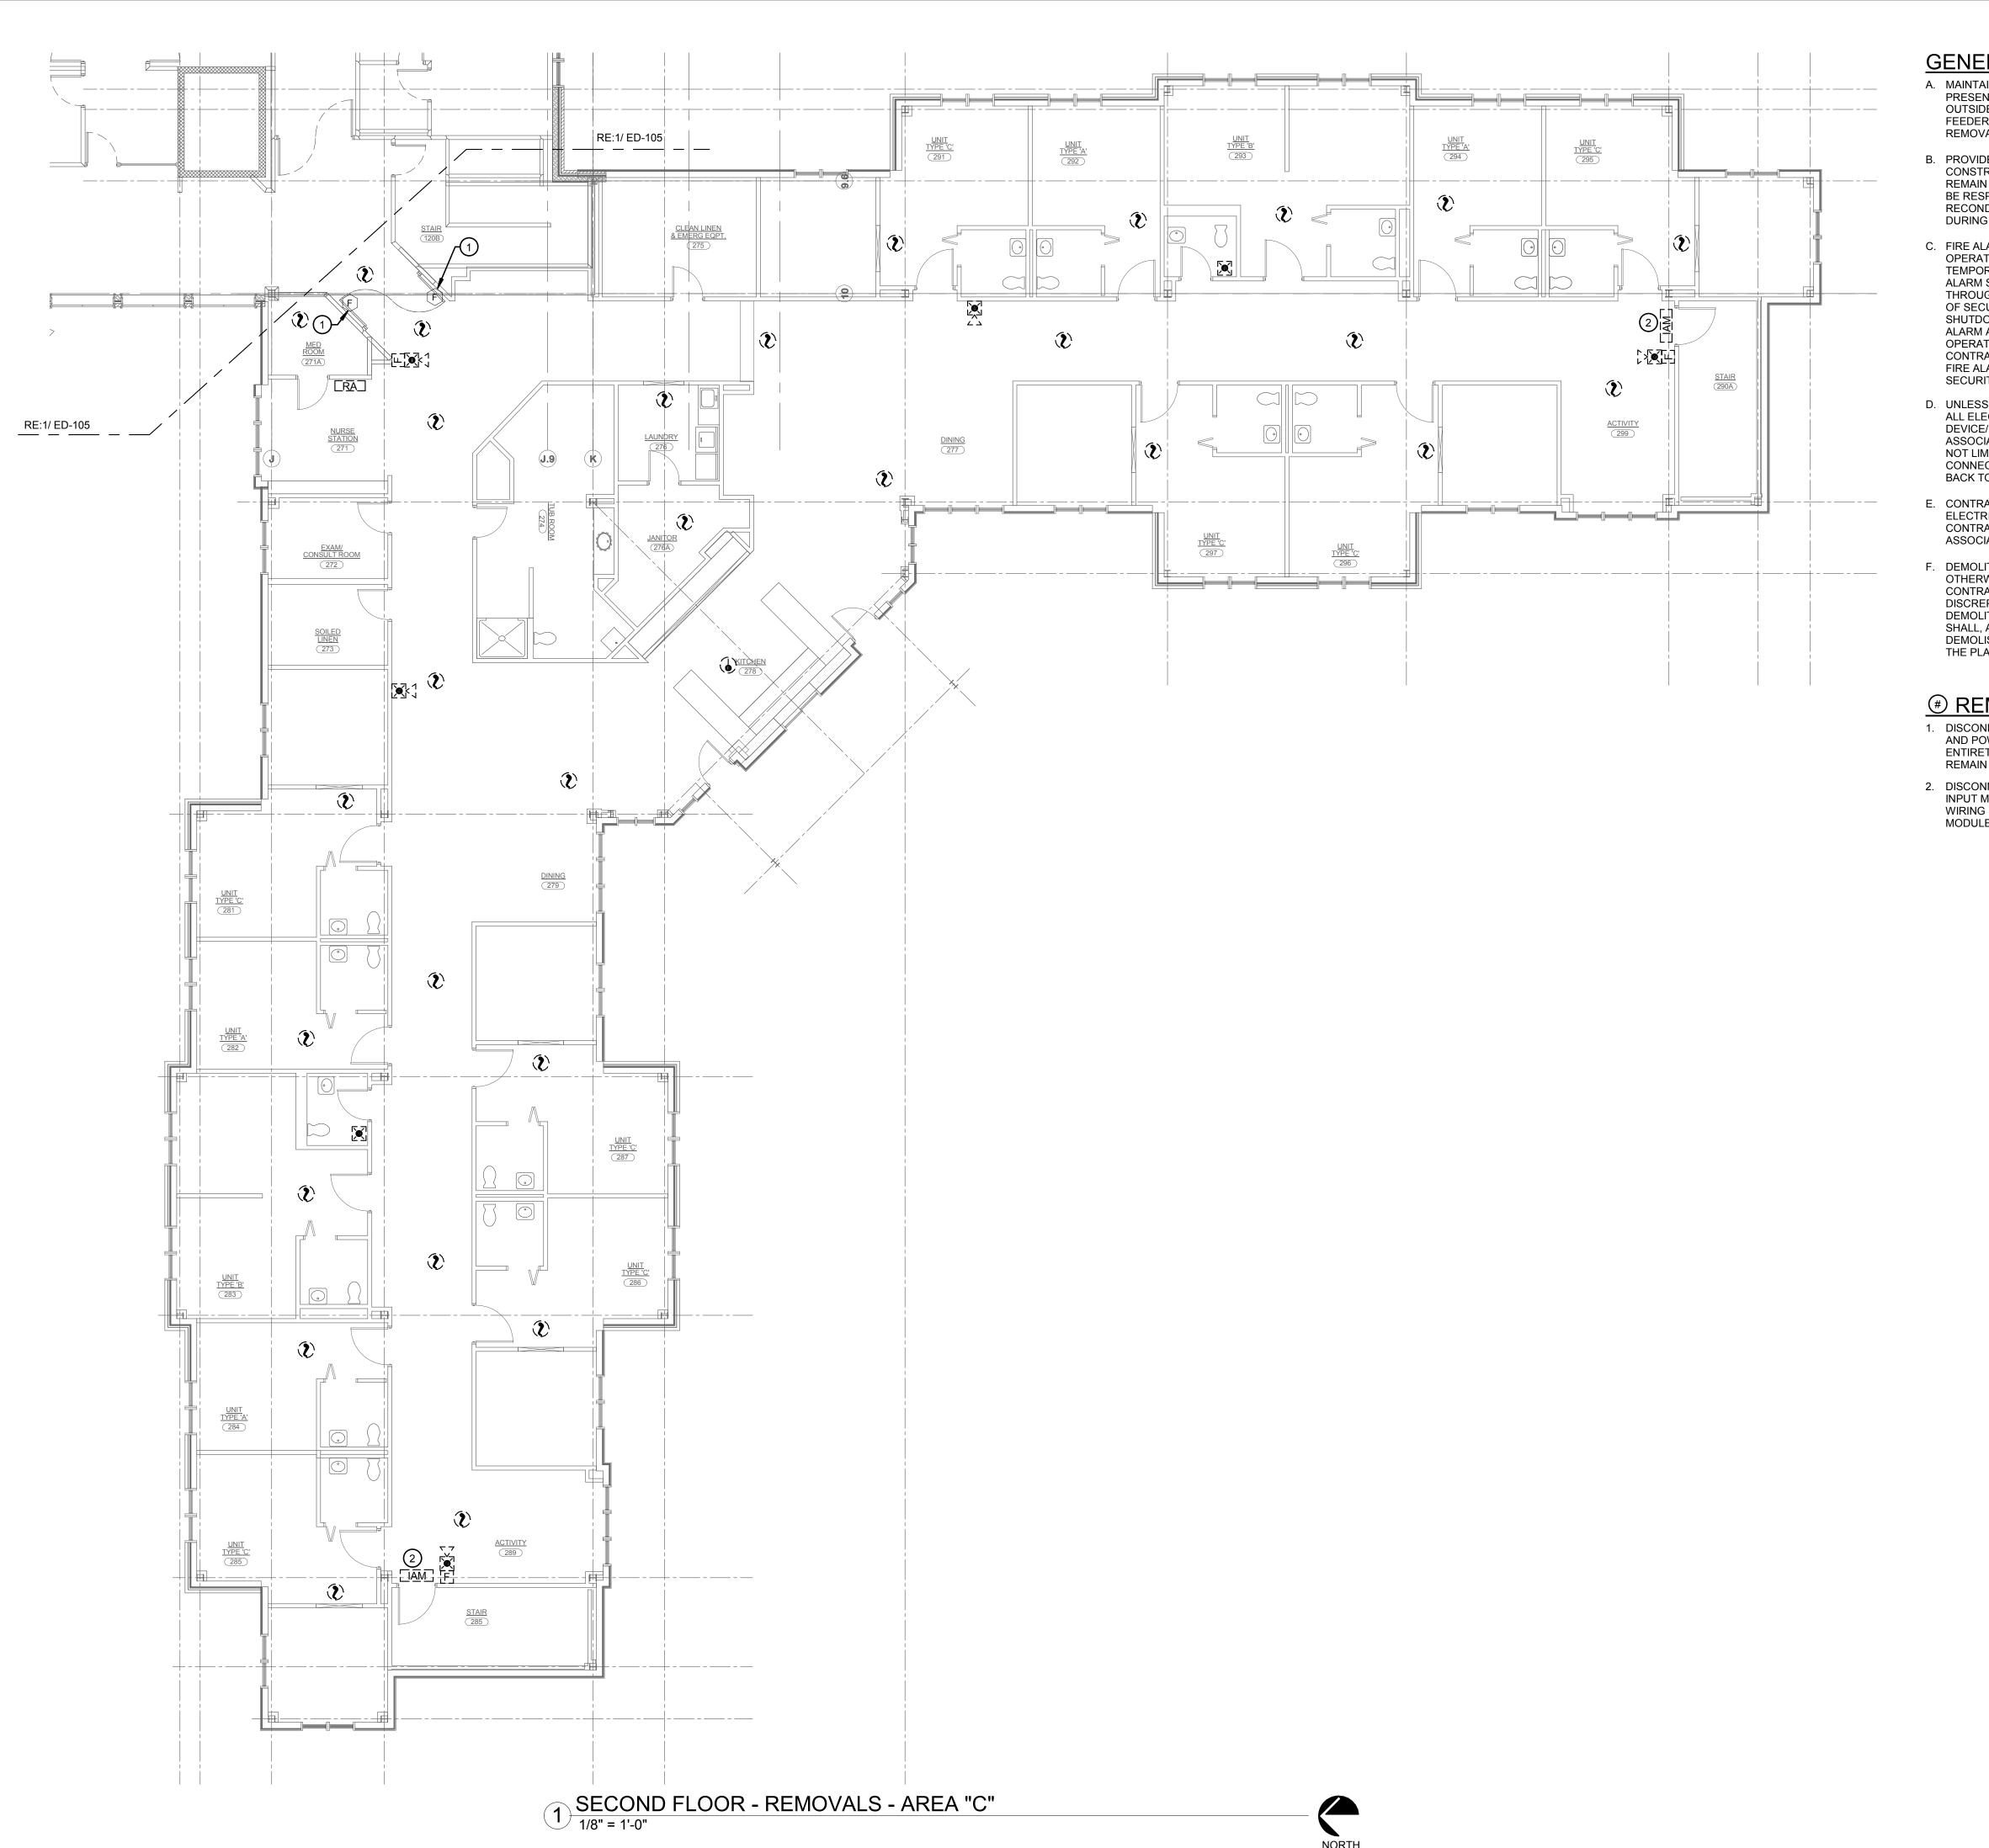
DWG TITLE

SECOND FLOOR - REMOVALS - AREA "B"

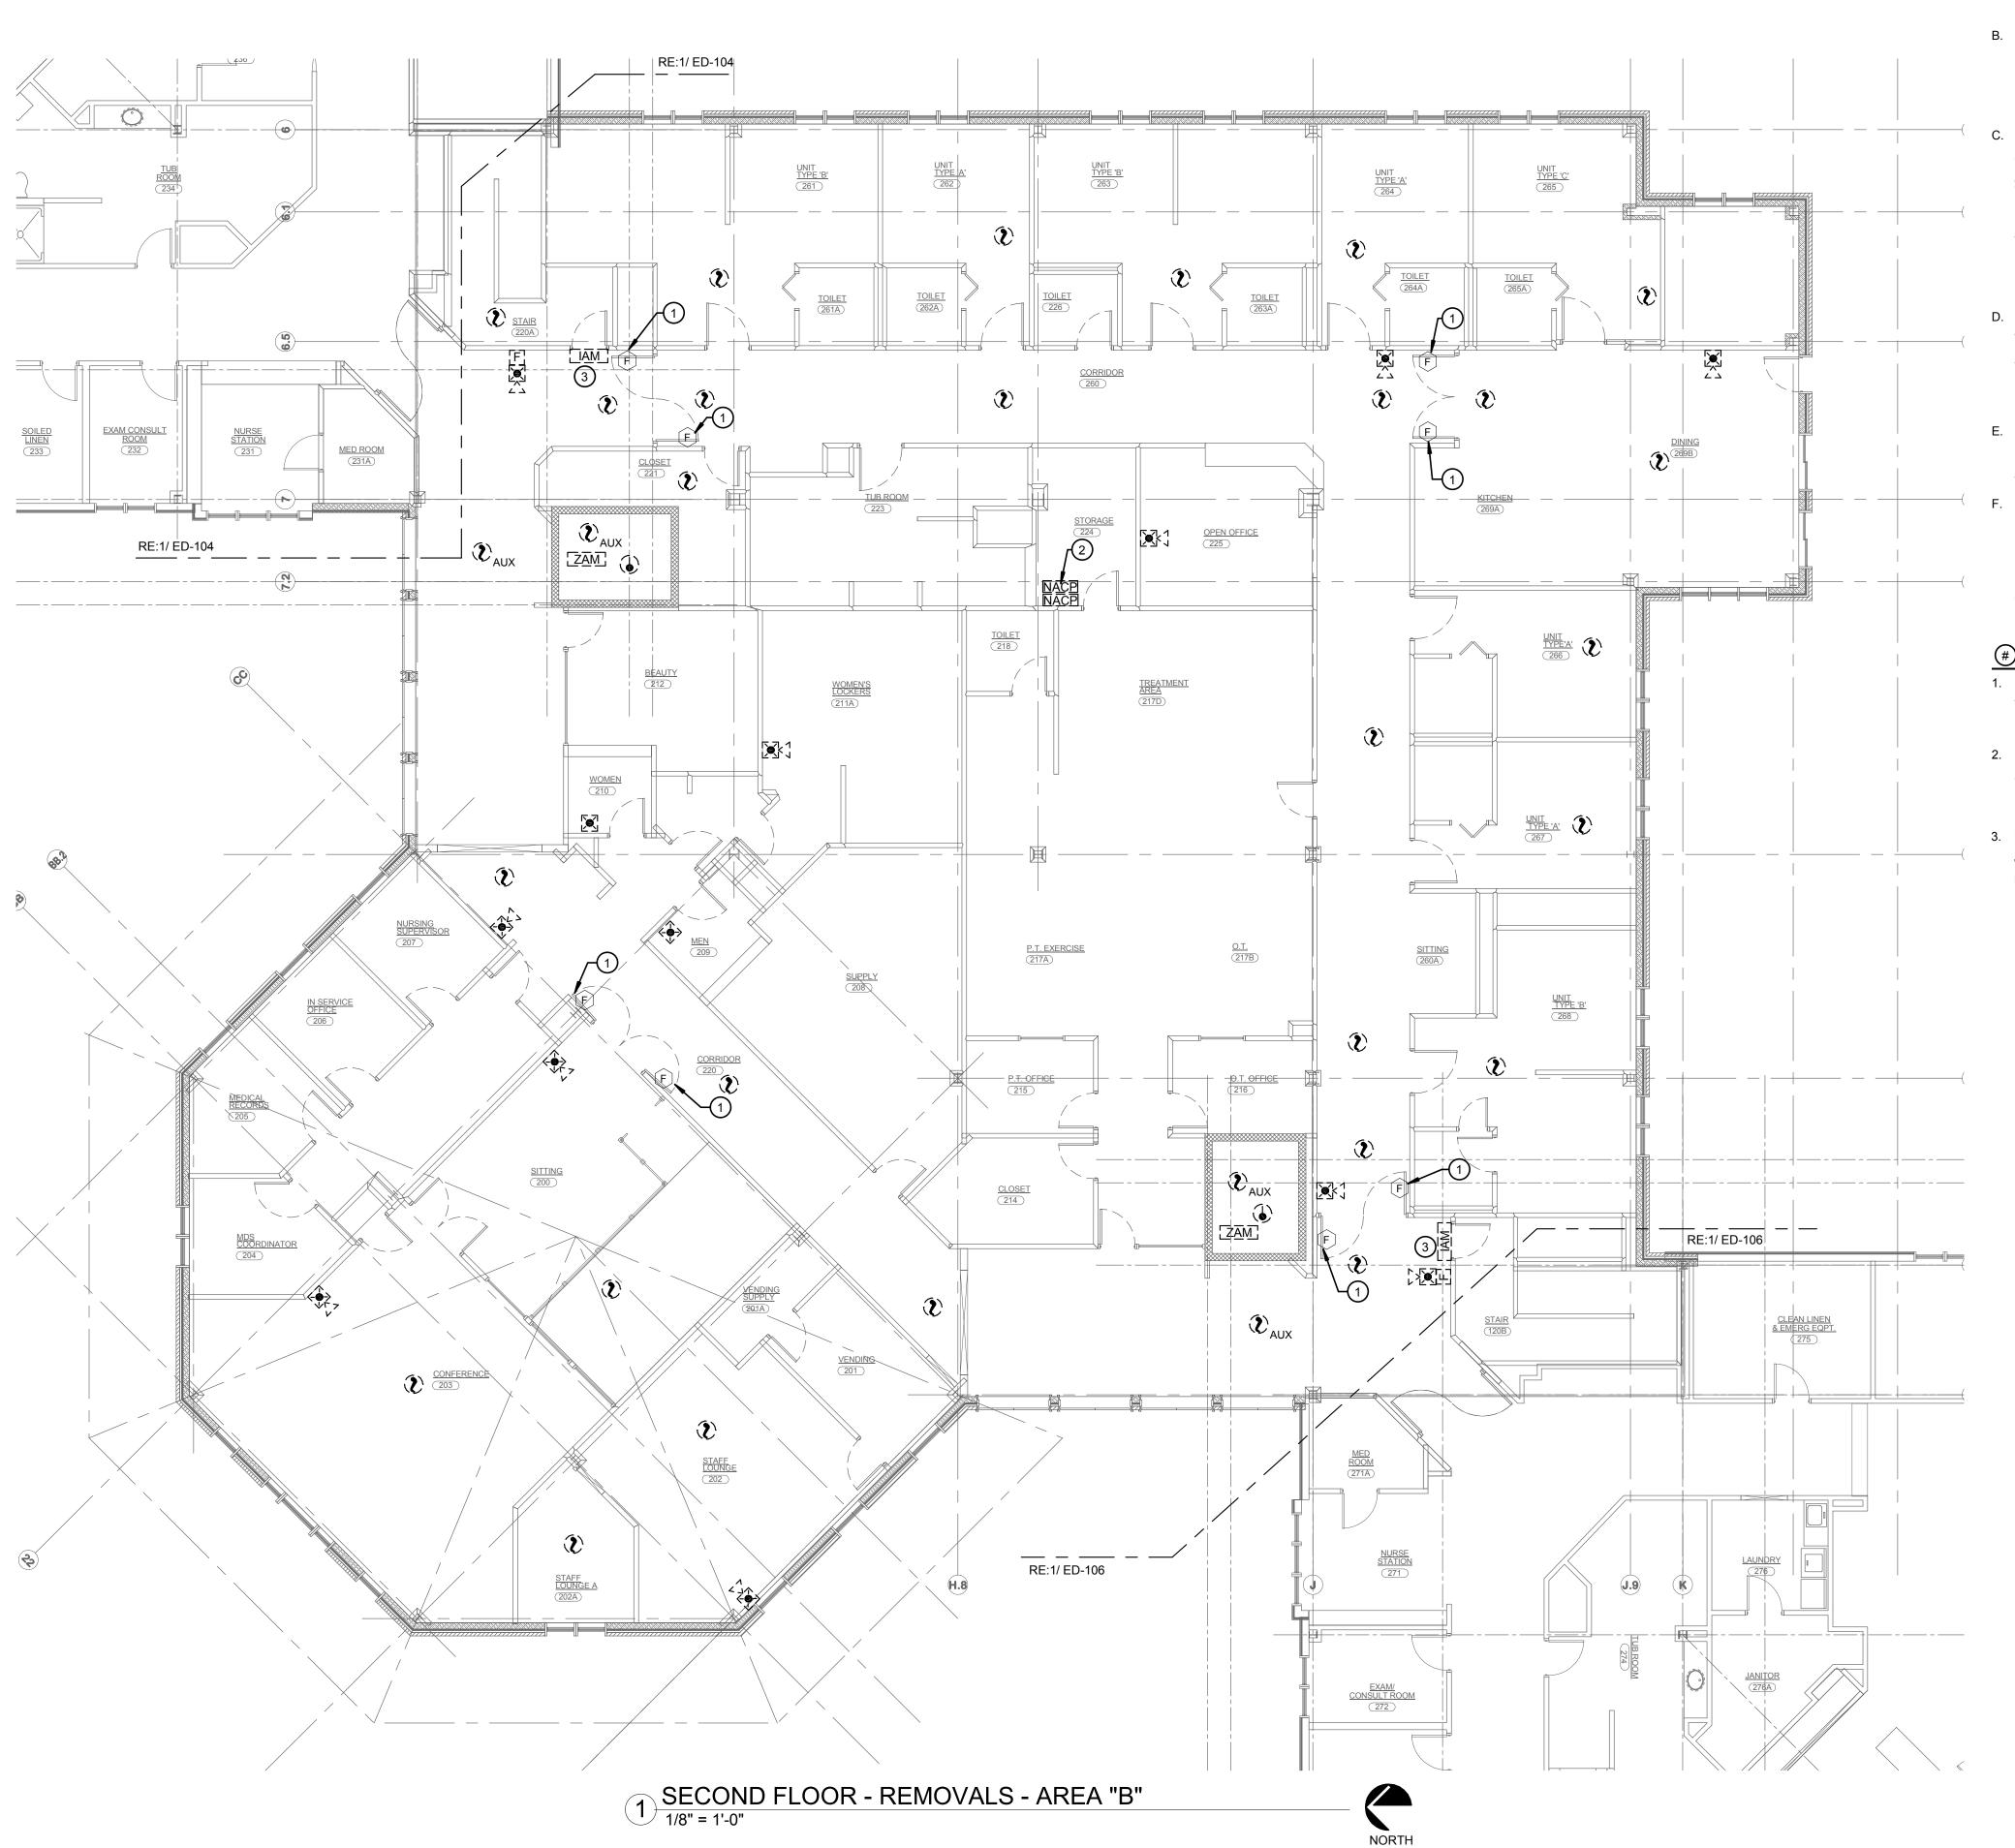

DWN. CDW
PROJ. No. 307663

ED-105





- A. MAINTAIN INTEGRITY OF EXISTING CIRCUIT WIRING PRESENTLY INSTALLED AND SERVING EQUIPMENT OUTSIDE THE WORK AREA. VERIFY ROUTE OF EACH FEEDER AND BRANCH CIRCUIT SCHEDULED FOR REMOVAL.
- B. PROVIDE PROTECTION FOR ALL EXISTING
 CONSTRUCTION SYSTEMS/EQUIPMENT SCHEDULED TO
 REMAIN DURING CONSTRUCTION. CONTRACTOR SHALL
 BE RESPONSIBLE FOR REPLACEMENT OR
 RECONDITIONING OF EQUIPMENT/ITEMS DAMAGED
 DURING REMOVALS.
- C. FIRE ALARM AND SECURITY SYSTEMS SHALL REMAIN OPERATIONAL DURING CONSTRUCTION. PROVIDE TEMPORARY WIRING AS REQUIRED TO MAINTAIN FIRE ALARM SYSTEM DETECTION/NOTIFICATION THROUGHOUT CONSTRUCTION PHASE AND OPERATION OF SECURITY SYSTEM. NOTIFY OWNER OF AREAS TO BE SHUTDOWN WHILE WORK IS BEING PREFORMED. FIRE ALARM AND SECURITY SYSTEMS SHALL BE FULLY OPERATIONAL AT END OF EACH WORK DAY. CONTRACTOR SHALL NOTE LEAVE ANY AREAS WITHOUT FIRE ALARM SYSTEM BEING FULLY FUNCTIONAL AND SECURITY SYSTEM FULLY OPERATIONAL.
- D. UNLESS OTHERWISE NOTED, DISCONNECT AND REMOVE ALL ELECTRICAL WORK ASSOCIATED WITH DEVICE/FIXTURE SCHEDULED FOR REMOVAL. ASSOCIATED ELECTRICAL WORK SHALL INCLUDE BUT NOT LIMITED TO CONDUCTORS, CONDUIT, BOXES, CONNECTORS, HANGERS, CONTROL EQUIPMENT, ETC. BACK TO SOURCE PANEL.
- E. CONTRACTOR SHALL PROPERLY DISPOSE OF ALL ELECTRICAL DEVICES AND MISC. ITEMS AS REQUIRED. CONTRACTOR IS RESPONSIBLE FOR ANY COST ASSOCIATED WITH DISPOSAL.
- F. DEMOLITION SHOWN SHALL BE SELECTIVE. UNLESS OTHERWISE INDICATED ON THE PLAN. THE CONTRACTOR SHALL NOTIFY THE ENGINEER OF DISCREPANCIES FOUND IN THE FIELD PRIOR TO DEMOLITION OF ANY ITEMS NOT SHOWN. CONTRACTOR SHALL, AT HIS EXPENSE, REPLACE OR REPAIR ANY DEMOLISHED ITEMS(S) THAT WERE NOT CALLED FOR ON THE PLANS OR BROUGHT TO ENGINEERS ATTENTION.

REMOVAL NOTES:

- DISCONNECT AND REMOVE FIRE ALARM SYSTEM WIRING AND POWER TO MAGNETIC DOOR HOLDERS IN THEIR ENTIRETY BACK TO SOURCE. DOOR HOLDERS SHALL REMAIN FOR CONNECITON TO NEW SYSTEM.
- 2. DISCONNECT AND REMOVE FIRE ALARM ADDRESSABLE INPUT MODULE, MONITORING SECURITY DOOR. EXISTING WIRING SHALL REMAIN FOR RECONNECTION TO NEW MODULE.



CATTARAUGUS COUNTY

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CATTARAUGUS COUNTY
PINES MACHIAS FIRE
ALARM
DESIGN DEVELOPEMNT



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DWG TITLE

SECOND FLOOR - REMOVALS - AREA "C"

0 1" 2"

GENERIC SCALE BAR

SCALE BAR SHOWN IS TWO INCHES ON THE ORIGINAL DRAWING
IF NOT TWO INCHES ON THIS SHEET, ADJUST ACCORDINGLY


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SCALE 1/8" = 1'-0"

DWN. CDW

PROJ. No. 307663

ED-106

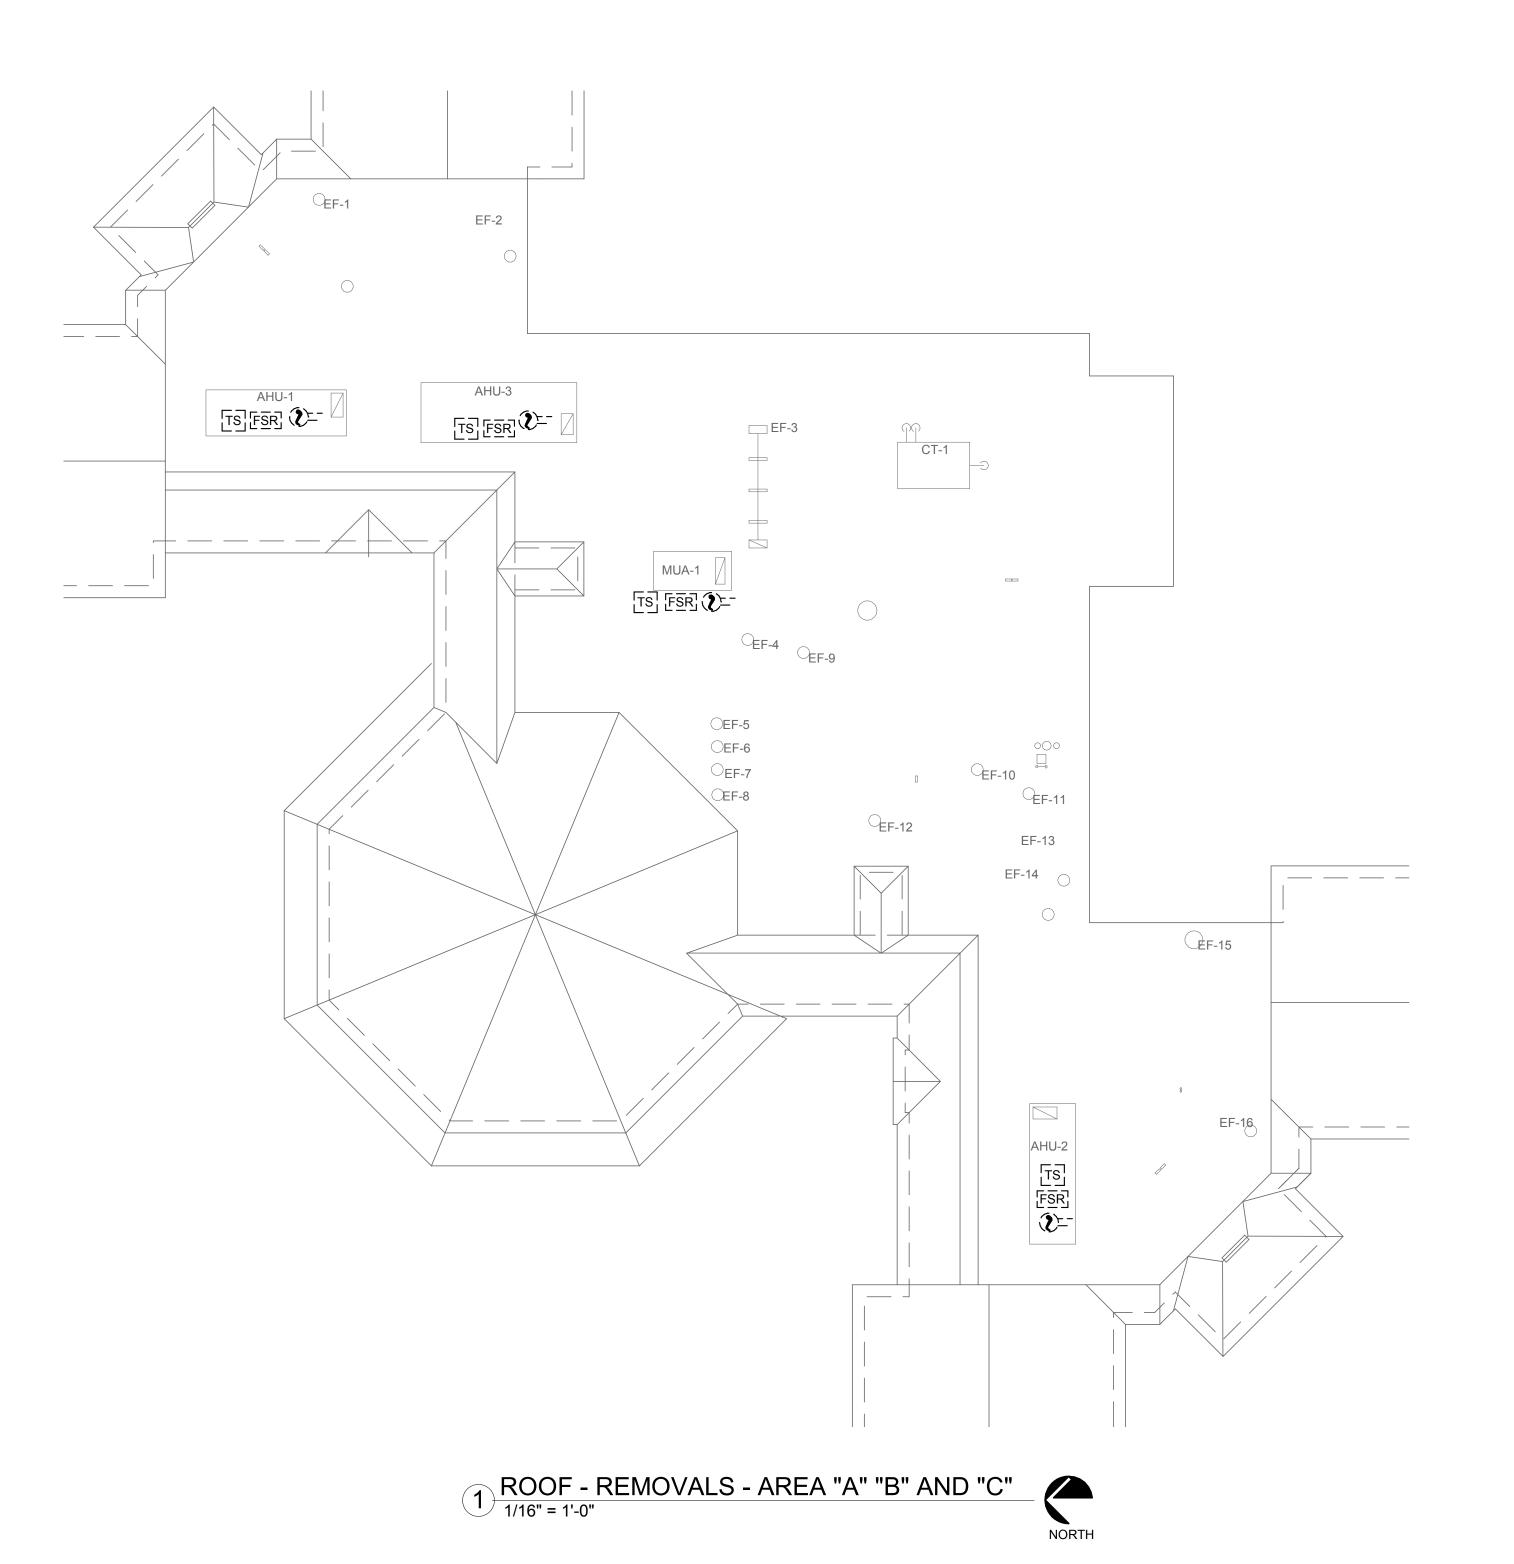

- A. MAINTAIN INTEGRITY OF EXISTING CIRCUIT WIRING PRESENTLY INSTALLED AND SERVING EQUIPMENT OUTSIDE THE WORK AREA. VERIFY ROUTE OF EACH FEEDER AND BRANCH CIRCUIT SCHEDULED FOR REMOVAL.
- B. PROVIDE PROTECTION FOR ALL EXISTING
 CONSTRUCTION SYSTEMS/EQUIPMENT SCHEDULED TO
 REMAIN DURING CONSTRUCTION. CONTRACTOR SHALL
 BE RESPONSIBLE FOR REPLACEMENT OR
 RECONDITIONING OF EQUIPMENT/ITEMS DAMAGED
 DURING REMOVALS.
- C. FIRE ALARM AND SECURITY SYSTEMS SHALL REMAIN OPERATIONAL DURING CONSTRUCTION. PROVIDE TEMPORARY WIRING AS REQUIRED TO MAINTAIN FIRE ALARM SYSTEM DETECTION/NOTIFICATION THROUGHOUT CONSTRUCTION PHASE AND OPERATION OF SECURITY SYSTEM. NOTIFY OWNER OF AREAS TO BE SHUTDOWN WHILE WORK IS BEING PREFORMED. FIRE ALARM AND SECURITY SYSTEMS SHALL BE FULLY OPERATIONAL AT END OF EACH WORK DAY. CONTRACTOR SHALL NOTE LEAVE ANY AREAS WITHOUT FIRE ALARM SYSTEM BEING FULLY FUNCTIONAL AND SECURITY SYSTEM FULLY OPERATIONAL.
- D. UNLESS OTHERWISE NOTED, DISCONNECT AND REMOVE ALL ELECTRICAL WORK ASSOCIATED WITH DEVICE/FIXTURE SCHEDULED FOR REMOVAL. ASSOCIATED ELECTRICAL WORK SHALL INCLUDE BUT NOT LIMITED TO CONDUCTORS, CONDUIT, BOXES, CONNECTORS, HANGERS, CONTROL EQUIPMENT, ETC. BACK TO SOURCE PANEL.
- E. CONTRACTOR SHALL PROPERLY DISPOSE OF ALL ELECTRICAL DEVICES AND MISC. ITEMS AS REQUIRED. CONTRACTOR IS RESPONSIBLE FOR ANY COST ASSOCIATED WITH DISPOSAL.
- F. DEMOLITION SHOWN SHALL BE SELECTIVE. UNLESS OTHERWISE INDICATED ON THE PLAN. THE CONTRACTOR SHALL NOTIFY THE ENGINEER OF DISCREPANCIES FOUND IN THE FIELD PRIOR TO DEMOLITION OF ANY ITEMS NOT SHOWN. CONTRACTOR SHALL, AT HIS EXPENSE, REPLACE OR REPAIR ANY DEMOLISHED ITEMS(S) THAT WERE NOT CALLED FOR ON THE PLANS OR BROUGHT TO ENGINEERS ATTENTION.



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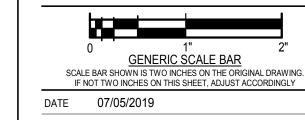
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ROOF - REMOVALS



SCALE As indicated

DWN. CDW

PROJ. No. 307663

DWG. No.

ED-107

SYMBOLS & ABBREVIATIONS SCHEDULE

LP2,12	DUPLEX RECEPTACLE OUTLET, 18" A.F.F., 20AMP COMMERCIAL GRADE GROUNDING TYPE WITH MATCHING COVERPLATE. TAG INDICATES PANELBOARD & BRANCH CIRCUIT THAT IT IS CONNECTED TO.
LP2,12	GFCI RECEPTACLE OUTLET, 18" A.F.F., 20AMP COMMERCIAL GRADE GROUNDING TYPE WITH MATCHING COVERPLATE. TAG INDICATES PANELBOARD & BRANCH CIRCUIT THAT IT IS CONNECTED TO.
LP2,12	DUPLEX RECEPTACLE OUTLET, 18" AFF., 20AMP COMMERCIAL GRADE GROUNDING TYPE WITH MATCHING COVERPLATE. TAG INDICATES PANELBOARD & DEDICATED BRANCH CIRCUIT THAT IT IS CONNECTED TO. RECEPTACLE SHALL BE SUPPLIED BY A GFCI CIRCUIT BREAKER. PROVIDE LABEL ON COVER "PROTECTED BY GFCI"
LP2,12	INDICATES (2) 20 AMP, COMMERCIAL GRADE RECEPTACLES IN 2-GANG BOX UNDER A COMMON MATCHING COVERPLATE. RECEPTACLES SHALL BE GROUNDING TYPE. TAG INDICATES PANELBOARD & BRANCH CIRCUIT THAT IT IS CONNECTED TO.
LP2,12	(2) GFCI RECEPTACLE OUTLETS, 18" A.F.F., 20AMP COMMERCIAL GRADE GROUNDING TYPE IN 2-GANG BACKBOX WITH MATCHING COMMON COVERPLATE. TAG INDICATES PANELBOARD & BRANCH CIRCUIT THAT IT IS CONNECTED TO.
LP2,10,12	RANGE OR DRYER OUTLET VERIFY RECEPTACLE NEMA CONFIGURATION, RATING & INSTALLATION HEIGHT WITH SELECTED EQUIPMENT SUPPLIER. TAG INDICATES PANELBOARD & BRANCH CIRCUIT THAT IT IS CONNECTED TO. COVER PLATES SHALL BE STAINLESS STEEL.
LP2,12	SPECIAL PURPOSE RECEPTACLE AS CALLED FOR ON DRAWINGS OR AS REQUIRED BY EQUIPMENT MANUFACTURER. VERIFY NEMA CONFIGURATION. TAG INDICATES PANELBOARD & BRANCH CIRCUIT THAT IT IS CONNECTED TO.
LP2,12	FLOOR MOUNTED RECEPTACLE AS CALLED FOR ON DRAWINGS OR AS REQUIRED BY EQUIPMENT MANUFACTURER. UNLESS OTHERWISE NOTED, PROVIDE RECESSED IN CONCRETE WITH A METAL COVER. TAG INDICATES PANELBOARD & BRANCH CIRCUIT THAT IT IS CONNECTED TO.
VALL J	PROVIDE COMPLETE ELECTRICAL POWER CONNECTION TO MODULAR FURNITURE. WHIP TO BE PROVIDED WITH FURNITURE. CONNECTION SHALL INCLUDE MINIMUM WALL OR FLOOR JUNCTION BOX, WIRING TO CIRCUIT INDICATED, FINAL CONNECTION TO APPROPRIATE FURNITURE GROUP.
\$м	MANUAL MOTOR STARTER WITH INDICATOR LIGHT.

<u>POWER</u>	
J	WALL MOUNTED JUNCTION BOX, SIZE AS INDICATED OR PROVIDE MINIMUM SIZE REQUIRED BY LATEST EDITION OF NATIONAL ELECTRICAL CODE (NFPA 70-NEC).
J	CEILING MOUNTED JUNCTION BOX, SIZE AS INDICATED OR PROVIDE MINIMUM SIZE REQUIRED BY LATEST EDITION OF NATIONAL ELECTRICAL CODE (NFPA 70-NEC).
•	PROVIDE COMPLETE ELECTRICAL CONNECTION TO EQUIPMENT INDICATED (INCLUDING DISCONNECT, CONDUCTORS, RACEWAY, & OTHER REQUIRED HARDWARE. XX-X INDICATES EQUIPMENT TAG. REFER TO MECHANICAL EQUIPMENT SCHEDULE FOR ADDITIONAL INFORMATION.
Æ ∕	PROVIDE COMPLETE ELECTRICAL CONNECTION TO MOTOR INDICATED (INCLUDING DISCONNECT, STARTER, CONDUCTORS, RACEWAY, & OTHER REQUIRED HARDWARE. XX-X INDICATES EQUIPMENT TAG. REFER TO MECHANICAL EQUIPMENT SCHEDULE FOR ADDITIONAL INFORMATION.
•	EMERGENCY POWER OFF BUTTON (EPO). PROVIDE WHERE INDICATED ON DRAWINGS. PROVIDE ALL REQUIRED INTERFACES AS CALLED FOR ON DRAWINGS OR REQUIRED BY EQUIPMENT MANUFACTURER.
TYPICAL WALL	ELECTRICAL PANELBOARD, SURFACE MOUNTED. UNLESS OTHERWISE NOTED, INSTALL AT 72" A.F.F. TO THE TOP OF THE BOX.
TYPICAL WALL	ELECTRICAL PANELBOARD, FLUSH MOUNTED. UNLESS OTHERWISE NOTED, INSTALL AT 72" A.F.F. TO THE TOP OF THE BOX.
	TYPICAL DISCONNECT (SAFETY SWITCH). REFER TO DRAWINGS FOR SIZE & ADDITIONAL FUSING REQUIREMENTS.
	TYPICAL DRY-TYPE TRANSFORMER (SIZE MIGHT VARY). UNLESS OTHERWISE NOTED, PROVIDE FLOOR MOUNTED WITH CONCRETE EQUIPMENT PAD.
	ELECTRICAL PIECE OF EQUIPMENT. REFER TO DRAWINGS FOR ADDITIONAL INFORMATION.

SHALL BE PROGRAMMED FOR ELEVATOR RECALL. FIRE ALARM SYSTEM HEAT DETECTOR. UNLESS OTHERWISE NOTED, PROVIDE COMBINATION FIXED (135°F) & RATE-OF-RISE (15° PER MINUTE) TYPE DEVICE. PROVIDE ALL WIRING AS REQUIRED BY SELECTED MANUFACTURER. FIRE ALARM SYSTEM HEAT DETECTOR. PROVIDE WITH FIXED TEMPERATURE SENSING ELEMENT (190°F OR AS OTHERWISE NOTED). PROVIDE ALL REQUIRED WIRING AS BY SELECTED MANUFACTURER. CARBON MONOXIDE DETECTOR. PROVIDE ALL REQUIRED WIRING BY SELECTED MANUFACTURER. FLAME DETECTOR, CEILING MOUNTED. PROVIDE ALL REQUIRED WIRING BY SELECTED MANUFACTURER. TAG INDICATES UV OR IR TECHNOLOGY FIRE ALARM SYSTEM DUCT DETECTOR. PROVIDE COMPLETE INSTALLATION INCLUDING SAMPLING TUBES EXTENDING THE FULL WIDTH OF DUCT. PROVIDE ALL WIRING AS REQUIRED BY SELECTED MANUFACTURER. FIRE ALARM SYSTEM REMOTE TEST STATION. PROVIDE WHERE INDICATED ON DRAWING & INTERFACE WITH DETECTION DEVICE INDICATED. PROVIDE ALL WIRING AS REQUIRED BY SELECTED MANUFACTURER. FIRE ALARM SYSTEM MANUAL PULL STATION. PROVIDE COMPLETE INSTALLATION WITH PROTECTIVE COVER WHERE REQUIRED. PROVIDE ALL WIRING AS REQUIRED BY SELECTED MANUFACTURER.
AS OTHERWISE NOTED). PROVIDE ALL REQUIRED WIRING AS BY SELECTED MANUFACTURER. CARBON MONOXIDE DETECTOR. PROVIDE ALL REQUIRED WIRING BY SELECTED MANUFACTURER. FLAME DETECTOR, CEILING MOUNTED. PROVIDE ALL REQUIRED WIRING BY SELECTED MANUFACTURER. TAG INDICATES UV OR IR TECHNOLOGY FIRE ALARM SYSTEM DUCT DETECTOR. PROVIDE COMPLETE INSTALLATION INCLUDING SAMPLING TUBES EXTENDING THE FULL WIDTH OF DUCT. PROVIDE ALL WIRING AS REQUIRED BY SELECTED MANUFACTURER. FIRE ALARM SYSTEM REMOTE TEST STATION. PROVIDE WHERE INDICATED ON DRAWING & INTERFACE WITH DETECTION DEVICE INDICATED. PROVIDE ALL WIRING AS REQUIRED BY SELECTED MANUFACTURER.
FLAME DETECTOR, CEILING MOUNTED. PROVIDE ALL REQUIRED WIRING BY SELECTED MANUFACTURER. TAG INDICATES UV OR IR TECHNOLOGY FIRE ALARM SYSTEM DUCT DETECTOR. PROVIDE COMPLETE INSTALLATION INCLUDING SAMPLING TUBES EXTENDING THE FULL WIDTH OF DUCT. PROVIDE ALL WIRING AS REQUIRED BY SELECTED MANUFACTURER. FIRE ALARM SYSTEM REMOTE TEST STATION. PROVIDE WHERE INDICATED ON DRAWING & INTERFACE WITH DETECTION DEVICE INDICATED. PROVIDE ALL WIRING AS REQUIRED BY SELECTED MANUFACTURER. FIRE ALARM SYSTEM MANUAL PULL STATION. PROVIDE COMPLETE INSTALLATION WITH PROTECTIVE COVER
FIRE ALARM SYSTEM DUCT DETECTOR. PROVIDE COMPLETE INSTALLATION INCLUDING SAMPLING TUBES EXTENDING THE FULL WIDTH OF DUCT. PROVIDE ALL WIRING AS REQUIRED BY SELECTED MANUFACTURER. FIRE ALARM SYSTEM REMOTE TEST STATION. PROVIDE WHERE INDICATED ON DRAWING & INTERFACE WITH DETECTION DEVICE INDICATED. PROVIDE ALL WIRING AS REQUIRED BY SELECTED MANUFACTURER. FIRE ALARM SYSTEM MANUAL PULL STATION. PROVIDE COMPLETE INSTALLATION WITH PROTECTIVE COVER
EXTENDING THE FULL WIDTH OF DUCT. PROVIDE ALL WIRING AS REQUIRED BY SELECTED MANUFACTURER. FIRE ALARM SYSTEM REMOTE TEST STATION. PROVIDE WHERE INDICATED ON DRAWING & INTERFACE WITH DETECTION DEVICE INDICATED. PROVIDE ALL WIRING AS REQUIRED BY SELECTED MANUFACTURER. FIRE ALARM SYSTEM MANUAL PULL STATION. PROVIDE COMPLETE INSTALLATION WITH PROTECTIVE COVER
DETECTION DEVICE INDICATED. PROVIDE ALL WIRING AS REQUIRED BY SELECTED MANUFACTURER. FIRE ALARM SYSTEM MANUAL PULL STATION. PROVIDE COMPLETE INSTALLATION WITH PROTECTIVE COVER
FIRE ALARM SYSTEM BEAM DETECTOR TRANSMITTER. PROVIDE COMPLETE INSTALLATION INCLUDING REMOTE TEST STATION. PROVIDE ALL WIRING AS REQUIRED BY SELECTED MANUFACTURER.
FIRE ALARM SYSTEM BEAM DETECTOR RECEIVER. PROVIDE ALL WIRING AS REQUIRED BY SELECTED MANUFACTURER.
FIRE ALARM SYSTEM WATER FLOW SWITCH. PROVIDE COMPLETE INTERFACE BETWEEN FLOW SWITCH & FIRE ALARM CONTROL PANEL. PROVIDE ALL WIRING AS REQUIRED BY SELECTED MANUFACTURER.
FIRE ALARM SYSTEM TAMPER SWITCH. PROVIDE COMPLETE INTERFACE BETWEEN TAMPER SWITCH & FIRE ALARM CONTROL PANEL. PROVIDE ALL WIRING AS REQUIRED BY SELECTED MANUFACTURER.
FIRE ALARM SYSTEM AUDIO/VISUAL NOTIFICATION APPLIANCE (WALL MOUNTED BETWEEN 80" TO 96", INSTALL NOT CLOSER THEN 6" TO THE FINISHED CEILING). PROVIDE ALL WIRING AS REQUIRED BY SELECTED MANUFACTURER. UNLESS OTHERWISE NOTED, <u>PROVIDE 15cd VISUAL DEVICE.</u>
FIRE ALARM SYSTEM VISUAL NOTIFICATION APPLIANCE (WALL MOUNTED BETWEEN 80" TO 96", INSTALL NOT CLOSER THE 6" TO THE FINISHED CEILING). PROVIDE ALL WIRING AS REQUIRED BY SELECTED MANUFACTURER. UNLESS OTHERWISE NOTED, <u>PROVIDE 15cd VISUAL DEVICE</u> .
FIRE ALARM SYSTEM AUDIO NOTIFICATION APPLIANCE (WALL MOUNTED BETWEEN 80" TO 96", INSTALL NOT CLOSER THEN 6" TO THE FINISHED CEILING). PROVIDE ALL WIRING AS REQUIRED BY SELECTED MANUFACTURER.
FIRE ALARM SYSTEM AUDIO/VISUAL NOTIFICATION APPLIANCE (CEILING MOUNTED). PROVIDE ALL WIRING AS REQUIRED BY SELECTED MANUFACTURER. UNLESS OTHERWISE NOTED, <u>PROVIDE 75cd VISUAL DEVICE</u> .
FIRE ALARM SYSTEM VISUAL NOTIFICATION APPLIANCE (CEILING MOUNTED). PROVIDE ALL WIRING AS REQUIRED BY SELECTED MANUFACTURER. UNLESS OTHERWISE NOTED, <u>PROVIDE 75cd VISUAL DEVICE</u> .
FIRE ALARM SYSTEM AUDIO NOTIFICATION APPLIANCE (CEILING MOUNTED). PROVIDE ALL WIRING AS REQUIRED BY SELECTED MANUFACTURER.
FIRE ALARM SYSTEM WATER FLOW ALARM INTERFACE. PROVIDE COMPLETE ELECTRICAL INTERFACE TO ALARM (PROVIDED BY SPRINKLER CONTRACTOR, WIRED BY ELECTRICAL CONTRACTOR). PROVIDE & INSTALL ALL WIRING AS REQUIRED BY SELECTED MANUFACTURER.
FIRE ALARM SYSTEM ZONE ADDRESSABLE MODULE. PROVIDE WHERE REQUIRED PER SPECS/DETAILS. PROVIDE ALL WIRING AS REQUIRED BY SELECTED MANUFACTURER.
FIRE ALARM SYSTEM CONTROLLABLE ZONE ADDRESSABLE MODULE. PROVIDE WHERE REQUIRED PER SPECS/DETAILS. PROVIDE ALL WIRING AS REQUIRED BY SELECTED MANUFACTURER.
FIRE ALARM SYSTEM INDIVIDUAL ADDRESSABLE MODULE. PROVIDE WHERE REQUIRED PER SPECS/DETAILS. PROVIDE ALL WIRING AS REQUIRED BY SELECTED MANUFACTURER.
FIRE ALARM SYSTEM FAN SHUT-DOWN RELAY. PROVIDE WHERE REQUIRED PER SPECS/DETAILS. CONTACT RATING SHALL MATCH FAN MOTOR FEEDER RATING. PROVIDE ALL WIRING AS REQUIRED BY SELECTED MANUFACTURER.
FIRE ALARM SYSTEM ISOLATION MODULE. PROVIDE WHERE REQUIRED PER SPECS/DETAILS. INSTALL EVERY 25TH INITIATING DEVICE ON SLC LOOP. PROVIDE ALL WIRING AS REQUIRED BY SELECTED MANUFACTURER.
FIRE ALARM SYSTEM ELECTROMAGNETIC DOOR HOLDER. VERIFY REQUIRED VOLTAGE PRIOR TO ORDERING.
PROVIDE COMPLETE INTERFACE TO FACP AS REQUIRED. PROVIDE ALL WIRING AS REQUIRED BY SELECTED MANUFACTURER. TYPICAL FIRE ALARM CONTROL PANEL. SURFACE OR FLUSH MOUNTED. PROVIDE WHERE INDICATED ON FLOOR
FA FCM F6C FT FR FR FR FK FA FS FA FRM F2 F

FIRE ALARM SYSTEM REMOTE ANNUNCIATOR PANEL. PROVIDE WHERE INDICATED ON FLOOR PLANS. INSTALL

APPROXIMATELY 72" A.F.F. TO TOP OF BOX. PROVIDE INTERFACE TO FACP & PROVIDE ALL WIRING AS REQUIRED

ALL WIRING AS REQUIRED BY SELECTED MANUFACTURER.

BY SELECTED MANUFACTURER.

R.A.

ABBREVIATIONS:

- INDICATES WEATHERPROOF DEVICE OR EQUIPMENT
- INDICATES DEVICE SHALL HAVE WIRE GUARD PROTECTION
- AFF ABOVE FINISHED FLOOR AFG ABOVE FINISHED GRADE
- (ETR) EXISTING EQUIPMENT SHALL REMAIN IN PLACE
- OC OVER COUNTER (INSTALL 12" ABOVE COUNTER HEIGHT) UC UNDER COUNTER (INSTALL 18" ABOVE FINISHED FLOOR)
- VNAC VISUAL NOTIFICATION APPLIANCE CIRCUIT ANAC AUDIO NOTIFICATION APPLIANCE CIRCUIT
- SLC SIGNALING LINE CIRCUIT
- ATS AUTOMATIC TRANSFER SWITCH
- HORSEPOWER KILOWATT
- kVA KILOVOLT-AMPERES
- VFD VARIABLE FREQUENCY DRIVE
- EM EMERGENCY NIGHTLIGHT (TYPICAL FOR LIGHTING, 'ON' ALL THE TIME)
- LTG LIGHTING CPWRCONTINUOUS LOAD (POWER)
- PWR POWER
- EH ELECTRIC HEAT KIT KITCHEN EQUIPMENT
- LMTR LARGEST MOTOR
- EQP SHOP EQUIPMENT
- NEC NATIONAL ELECTRICAL CODE
- MLO MAIN LUGS ONLY
- MCB MAIN CIRCUIT BREAKER AWG AMERICAN WIRE GAGE

BRANCH CIRCUIT WIRING NOTES:

- A. UNLESS OTHERWISE NOTED, MINIMUM HOMERUN (HOMERUN SHALL BE CONSIDERED TOTAL LENGTH FROM SOURCE TO LAST DEVICE ON THE CIRCUIT) CONDUCTORS FOR 20A/1P BRANCH CIRCUITS INCLUDING LIGHTING SHALL BE AS FOLLOWS:
 - 1-100FT #12 AWG • 101-150FT - #10 AWG
 - 151-250FT #8 AWG
 - 251-400FT #6 AWG.

401 & LONGER - #4 AWG.

REDUCE CONDUCTORS SIZE TO A MAXIMUM CONDUCTOR SIZE THAT THE LOAD TERMINALS CAN ACCOMMODATE, REDUCED SIZE NOT LONGER THAN ONE FOOT. INCREASE RACEWAY SIZE AS NEEDED PER NEC, FOR THE LARGER SIZES OF CONDUCTORS.

REMOVAL (TYPICAL FOR ALL DEVICES):



TYPICAL POWER & SYSTEMS DEVICE SCHEDULED FOR REMOVAL. DISCONNECT & REMOVE ALL ASSOCIATED ELECTRICAL WORK AS INDICATED ON CONTRACT DOCUMENTS. REINSTALL AS REQUIRED

TYPICAL LUMINAIRE SCHEDULED FOR REMOVAL. REFER TO LUMINAIRE SCHEDULE FOR ADDITIONAL INFORMATION.


REMOVAL NOTES:

NOT ALL DEVICES SCHEDULED FOR REMOVAL ARE SHOWN ON THIS SCHEDULE. ALL DEVICES TO BE REMOVED ARE MARKED WITH THE SAME LINETYPE & LINE WEIGHT AS SYMBOLS ABOVE. REFER TO DEMOLITION PLANS FOR ADDITIONAL INFORMATION.

EXISTING TO REMAIN (TYPICAL FOR ALL DEVICES):



TYPICAL POWER & SYSTEMS DEVICE EXISTING TO REMAIN IN PLACE.

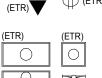

EXISTING LUMINAIRE SCHEDULED TO REMAIN IN PLACE. REFER TO LUMINAIRE SCHEDULE FOR ADDITIONAL INFORMATION.

NOT ALL EXISTING DEVICES SCHEDULED TO REMAIN ARE SHOWN ON THIS SCHEDULE. ALL DEVICES SCHEDULED TO REMAIN ARE MARKED WITH THE SAME LINETYPE & LINE WEIGHT AS SYMBOLS ABOVE. REFER TO FLOOR PLAN DRAWINGS FOR ADDITIONAL INFORMATION.

GENERAL NOTES: (FOR ALL DRAWINGS)

- A. THE DRAWINGS ARE DIAGRAMMATIC & INDICATE GENERALLY THE LOCATIONS OF THE MATERIAL & EQUIPMENT. THESE DRAWINGS SHALL BE FOLLOWED AS CLOSELY AS POSSIBLE.
- B. MINOR DETAILS NOT USUALLY SHOWN OR SPECIFIED, BUT NECESSARY FOR PROPER INSTALLATION & OPERATION, SHALL BE INCLUDED IN THE CONTRACTOR'S BID, THE SAME AS IF HEREIN SPECIFIED OR SHOWN.
- C. ALL MATERIAL & INSTALLATION SHALL BE IN ACCORDANCE WITH LATEST EDITION OF THE NATIONAL ELECTRIC CODE. LATEST EDITION OF LOCAL CODES. & ORDINANCES.
- D. ALL CONDUITS ON EXPOSED WORK SHALL BE RUN AT RIGHT ANGLES TO, & PARALLEL WITH, THE SURROUNDING WALL & SHALL CONFORM TO THE FORM OF THE CEILING. DIAGONAL RUNS WILL NOT BE ALLOWED. BENDS IN PARALLEL CONDUIT RUNS SHALL BE CONCENTRIC. ALL CONDUIT SHALL RUN PERFECTLY STRAIGHT & TRUE.
- E. ALL CONDUIT RUNS ARE TO BE CONCEALED IN WALLS, CEILINGS. EXPOSED CONDUIT SHALL ONLY BE INSTALLED WHERE MEANS OF CONCEALING DOES NOT EXIST. CONTRACTOR IS TO NOTIFY ENGINEER & GET OWNERS APPROVAL PRIOR TO RUNNING EXPOSED CONDUITS.
- F. INTERIOR RECEPTACLE & LIGHT FIXTURE BRANCH CIRCUITS SHALL BE IN EMT CONDUIT. A MAXIMUM OF (3) CIRCUITS CAN BE GROUPED TOGETHER IN A HOMERUN CONDUIT. EACH CIRCUIT SHALL HAVE SEPARATE NEUTRAL, GROUPING OF NEUTRALS SHALL NOT BE ACCEPTABLE. EACH CIRCUIT SHALL ALSO HAVE A GROUND WIRE SIZED PER NEC. USING CONDUIT, OR MC CABLE AS GROUND PATH SHALL NOT BE ACCEPTABLE. CABLE MUST BE SUPPORTED PER NEC, GROUPING OF GROUND WIRES [(1) GROUND PER (3) CIRCUITS] IS ACCEPTABLE. MAXIMUM 6' LENGTH OF MC CABLE ALLOWED FOR A WHIP CONNECTION TO LUMINAIRE ONLY. EXTERIOR (OUTDOOR) RECEPTACLE & LIGHT FIXTURE BRANCH CIRCUITS SHALL BE IN RMC CONDUIT OR AS PERMITTED IN THE SPECIFICATIONS.
- G. THE CONTRACTOR IS RESPONSIBLE FOR ALL REQUIRED COSTS FOR SEALING ALL PENETRATIONS THROUGH FIRE & SMOKE WALLS USING UL APPROVED SEALANT & METHODS.
- H. UNLESS OTHERWISE NOTED, PROVIDE ALL NEW RACEWAYS. USE SURFACE RACEWAY ONLY WHERE INDICATED ON THE PLANS. IF CONTRACTOR INTENDS TO UTILIZE SURFACE RACEWAY IN AREAS OTHER THOSE INDICATED ON PLANS, PRIOR APPROVAL IS REQUIRED FROM ENGINEER & OWNER.
- I. CONTRACTOR MAY REUSE EXISTING CONCEALED CONDUIT UNLESS OTHERWISE NOTED ON THE PLANS.
- J. ALL RECEWAYS CROSSING BUILDING EXPANSION JOINTS SHALL BE EQUIPPED WITH EXPANSION FITTINGS.

GENERAL SYMBOLS NOTE:

PARTICULAR

THIS SYMBOLS & ABBREVIATIONS SCHEDULE IS FOR THE ELECTRICAL CONTRACTOR

PROJECT. ANY ADDITIONS OR OMMISSIONS FROM THIS SCHEDULE DOES NOT IMPLY

REFERENCE ONLY. NOT ALL SYMBOLS OR ABBREVIATIONS MAY APPLY TO THIS

INCLUSION AND / OR EXCLUSION OF ANY PARTICULAR ITEM FROM THE PROJECT.

K. CONTRACTOR SHALL PROVIDE INFORMATION LABELS ON JUNCTION BOXES LABELS. SHALL BE PHENALIC TYPE WITH BLACK BACKGROUND & WHITE ENGRAVED LETTERING. LABEL SHALL INDICATED CIRCUIT/FEEDER SOURCE & EQUIPMENT ID NAME.

CATTARAUGUS COUNTY

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MACHIAS, NEW YORK

CATTARAUGUS COUNTY

PINES MACHIAS FIRE

ALARM

DESIGN DEVELOPEMNT

Centerpointe Corporate Park

375 Essjay Road, Suite 200

Williamsville, NY 14221 www.wendelcompanies.com

p:716.688.0766 f:716.625.6825

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NO.		REVISIONS	DATE

DWG. TITLE SYMBOLS AND


ABBERIVATIONS

SCALE BAR SHOWN IS TWO INCHES ON THE ORIGINAL DRAWING. IF NOT TWO INCHES ON THIS SHEET, ADJUST ACCORDINGLY SCALE 12" = 1'-0"

CHK. JJR

DWN. CDW

PROJ. No. 307663

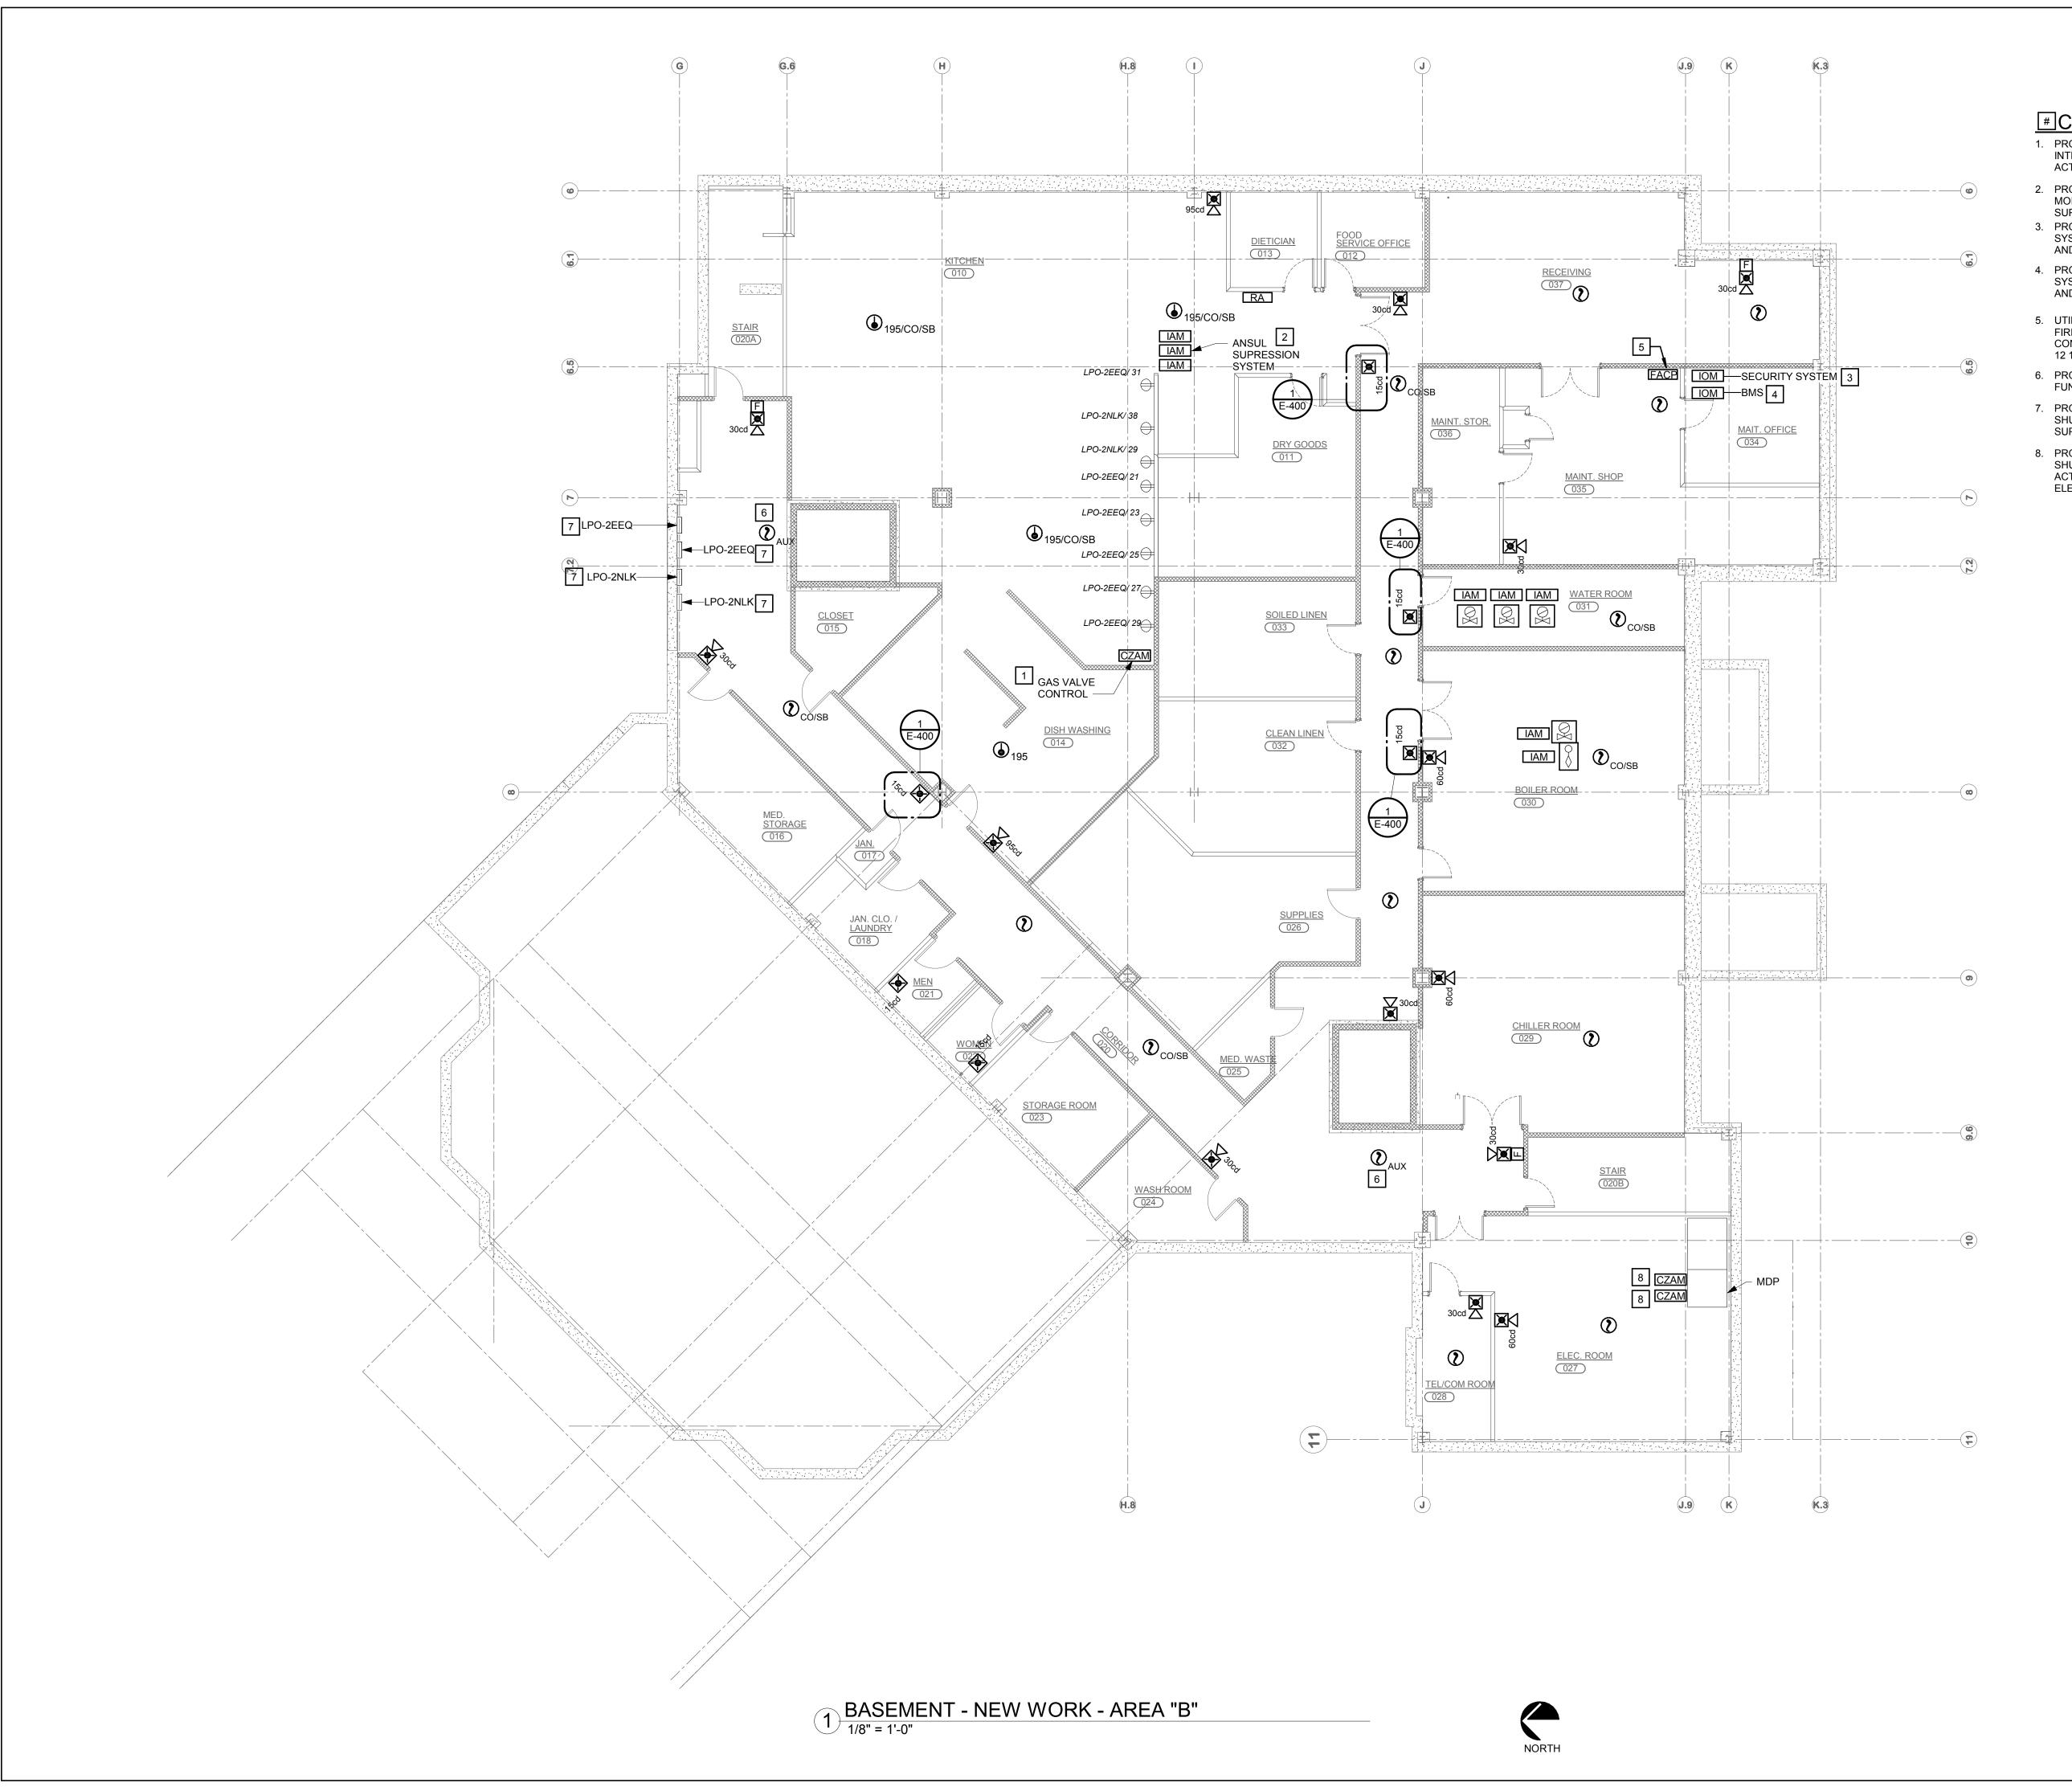

#CONSTRUCTION NOTES:

- PROVIDE FIRE ALARM CONTROLLED RELAY TO
 INTERRUPT EXISTING 120 VOLT GAS POWER UPON
 ACTIVATION OF FIRE ALARM SYSTEM.
- PROVIDE (3) ADDRESSABLE INPUT MODULES TO
 MONITOR ANSUL HOOD SYSTEM. ALARM, TROUBLE AND
- 3. PROVIDE ADDRESSABLE OUTPUT MODULE TO SECURITY SYSTEM INPUT. UTILIZE EXISTING CONNECTION POINT AND EXTEND AS REQUIRED.
- 4. PROVIDE ADDRESSABLE OUTPUT MODULE TO BMS SYSTEM INPUT. UTILIZE EXISTING CONNECTION POINT AND EXTEND AS REQUIRED.
- UTILIZE EXISTING EMERGENCY BRANCH FROM EXISTING FIRE ALARM SYSTEM TO POWER NEW. EXTEND BRANCH CONNECT BRANCH CIRCUIT AS REQUIRED. PROVIDE 2# 12 1 #12EG IN ¾" CONDUIT.
- 6. PROGRAM DETECTORS FOR ELEVATOR RECALL FUNCTIONS.
- 7. PROVIDE 24 VDC SIGNAL FROM FIRE ALARM SYSTEM TO SHUNT TRIP BREAKERS UPON INITIATION OF SUPRESSION SYSTEM ALARM.
- 8. PROVIDE 24 VDC SIGNAL FROM FIRE ALARM SYSTEM TO SHUNT TRIP ELEVATOR BREAKERS. BREAKERS SHALL BE ACTIVATED UPON INITIATION OF HEAT DETECTOR IN ELEVATOR MACHINE ROOM.



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BASEMENT - NEW WORK -AREA "B"

0 1" 2"

GENERIC SCALE BAR

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DATE 07/05/2019


SCALE 1/8" = 1'-0"

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PROJ. No. 307663

30/003

E-100



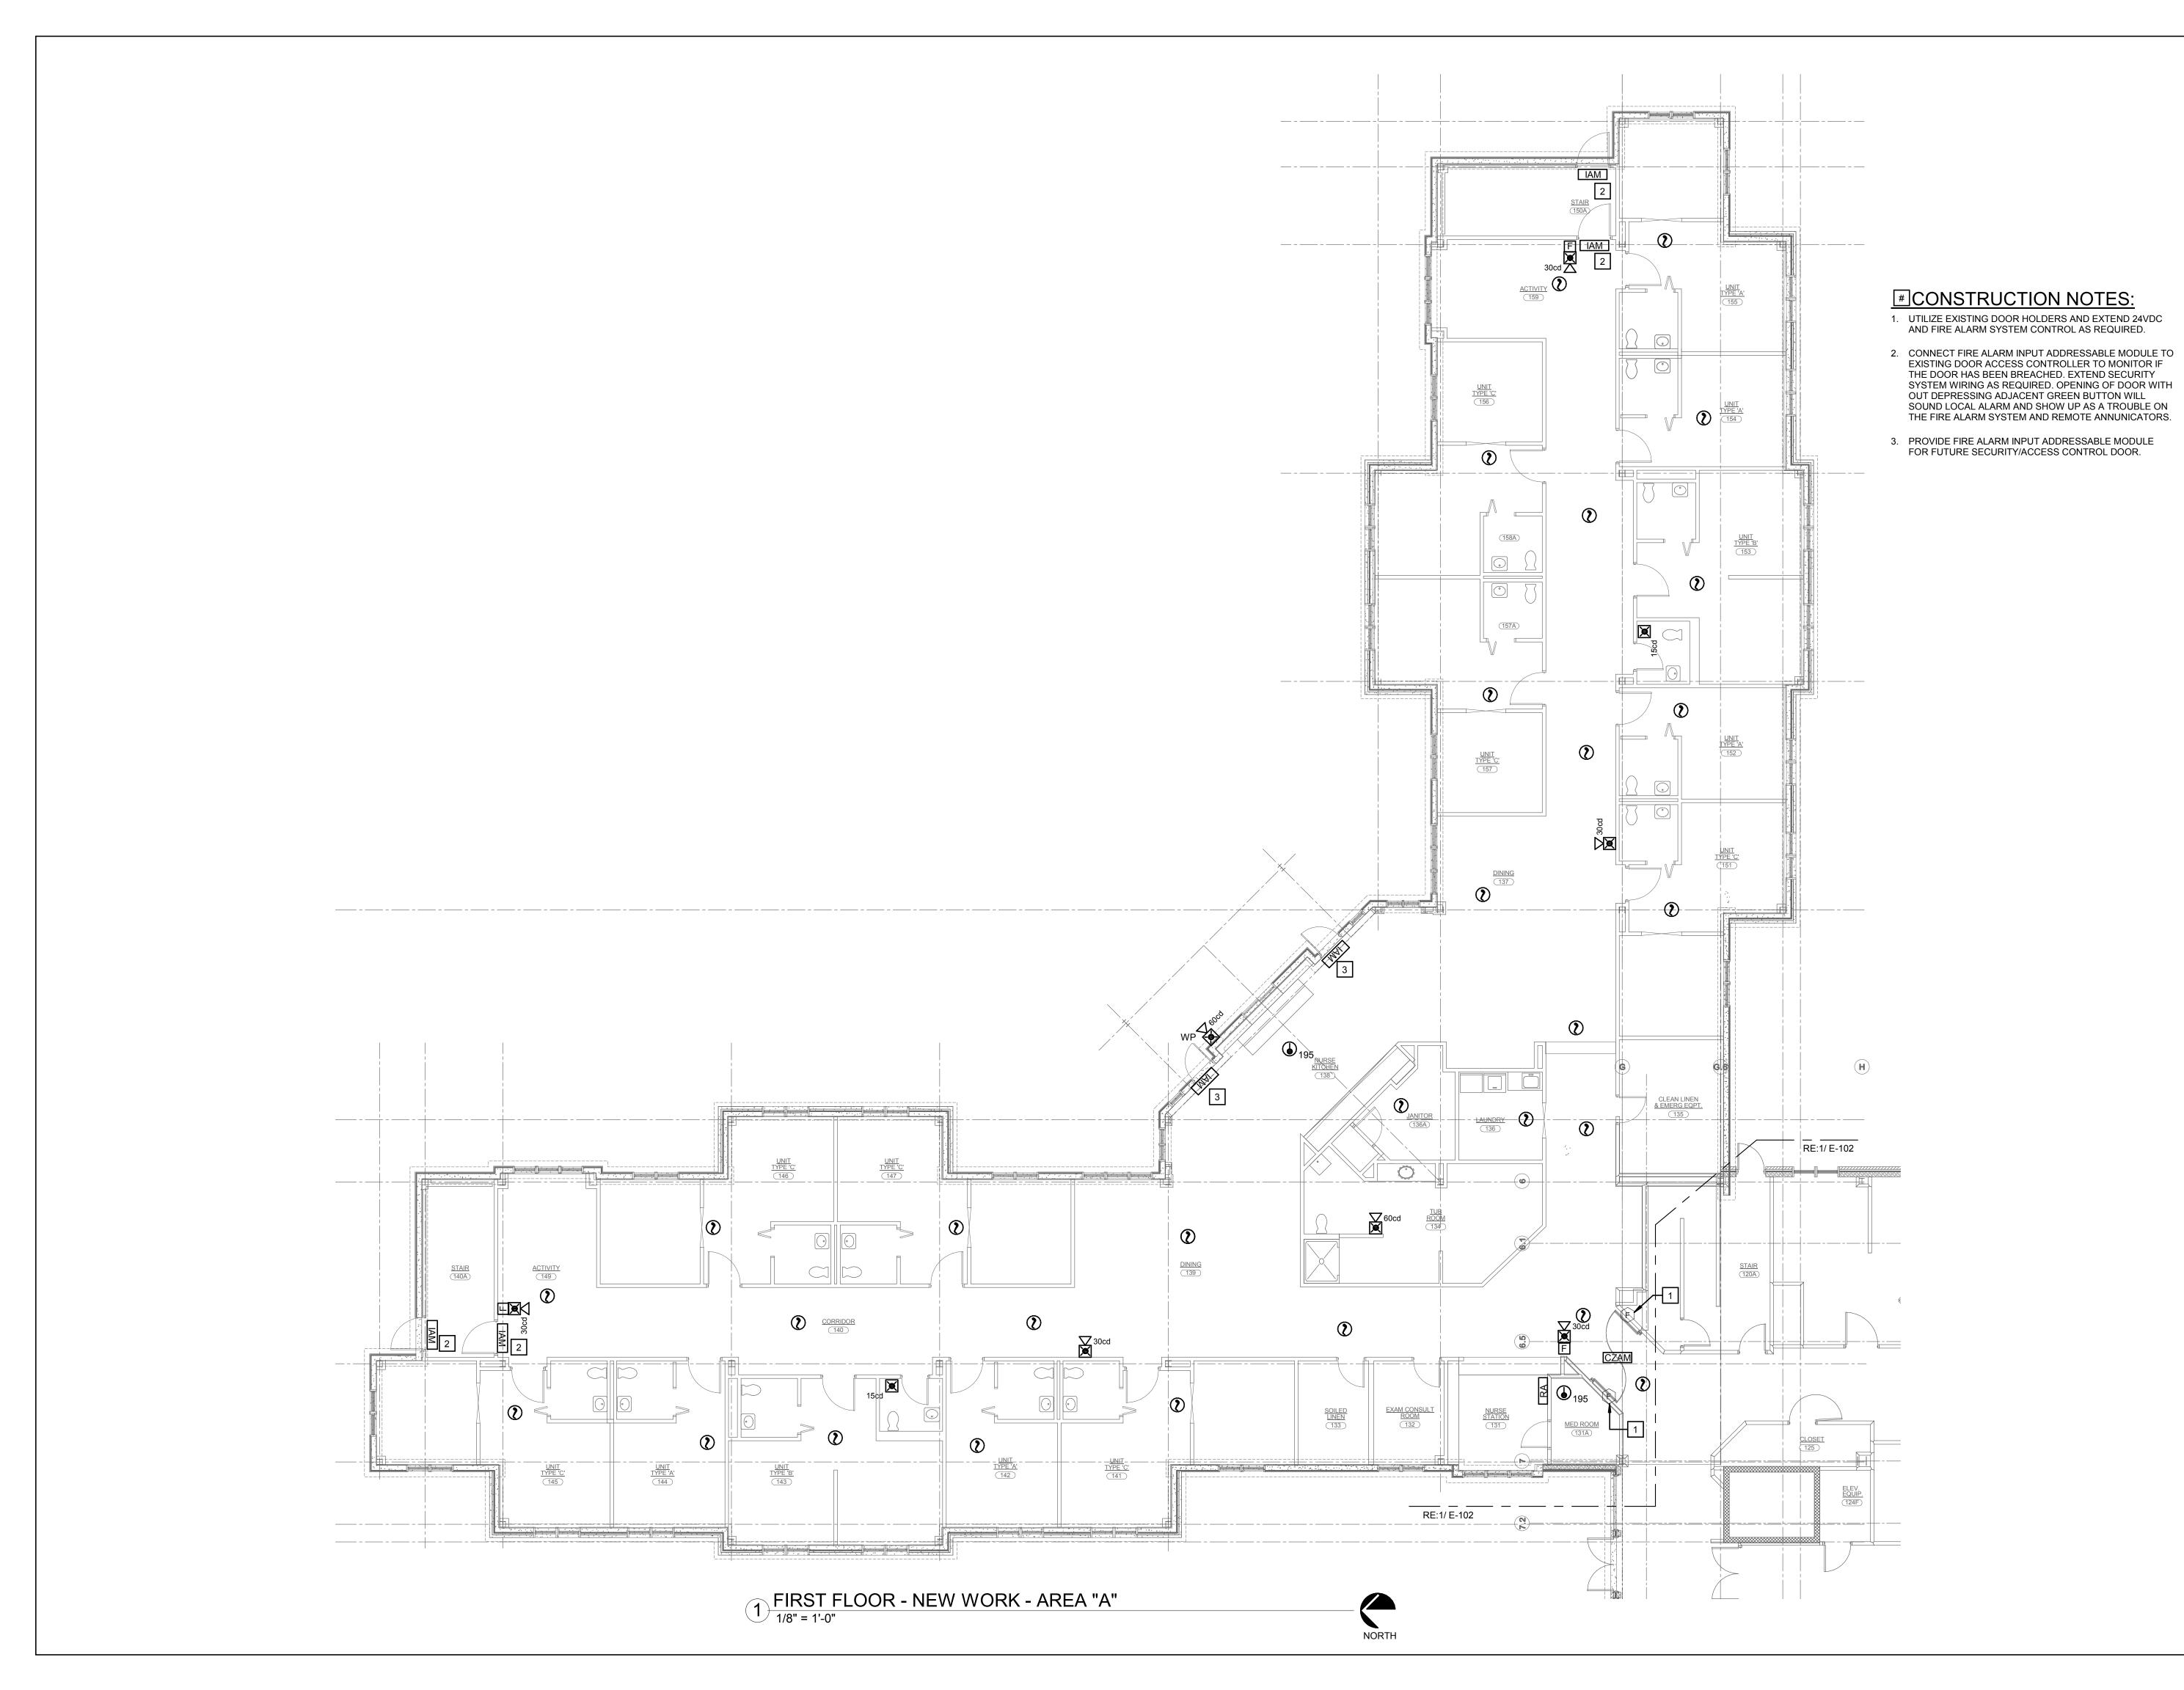

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DWG. TITLE

FIRST FLOOR - NEW WORK -AREA "A"

0 1" 2"

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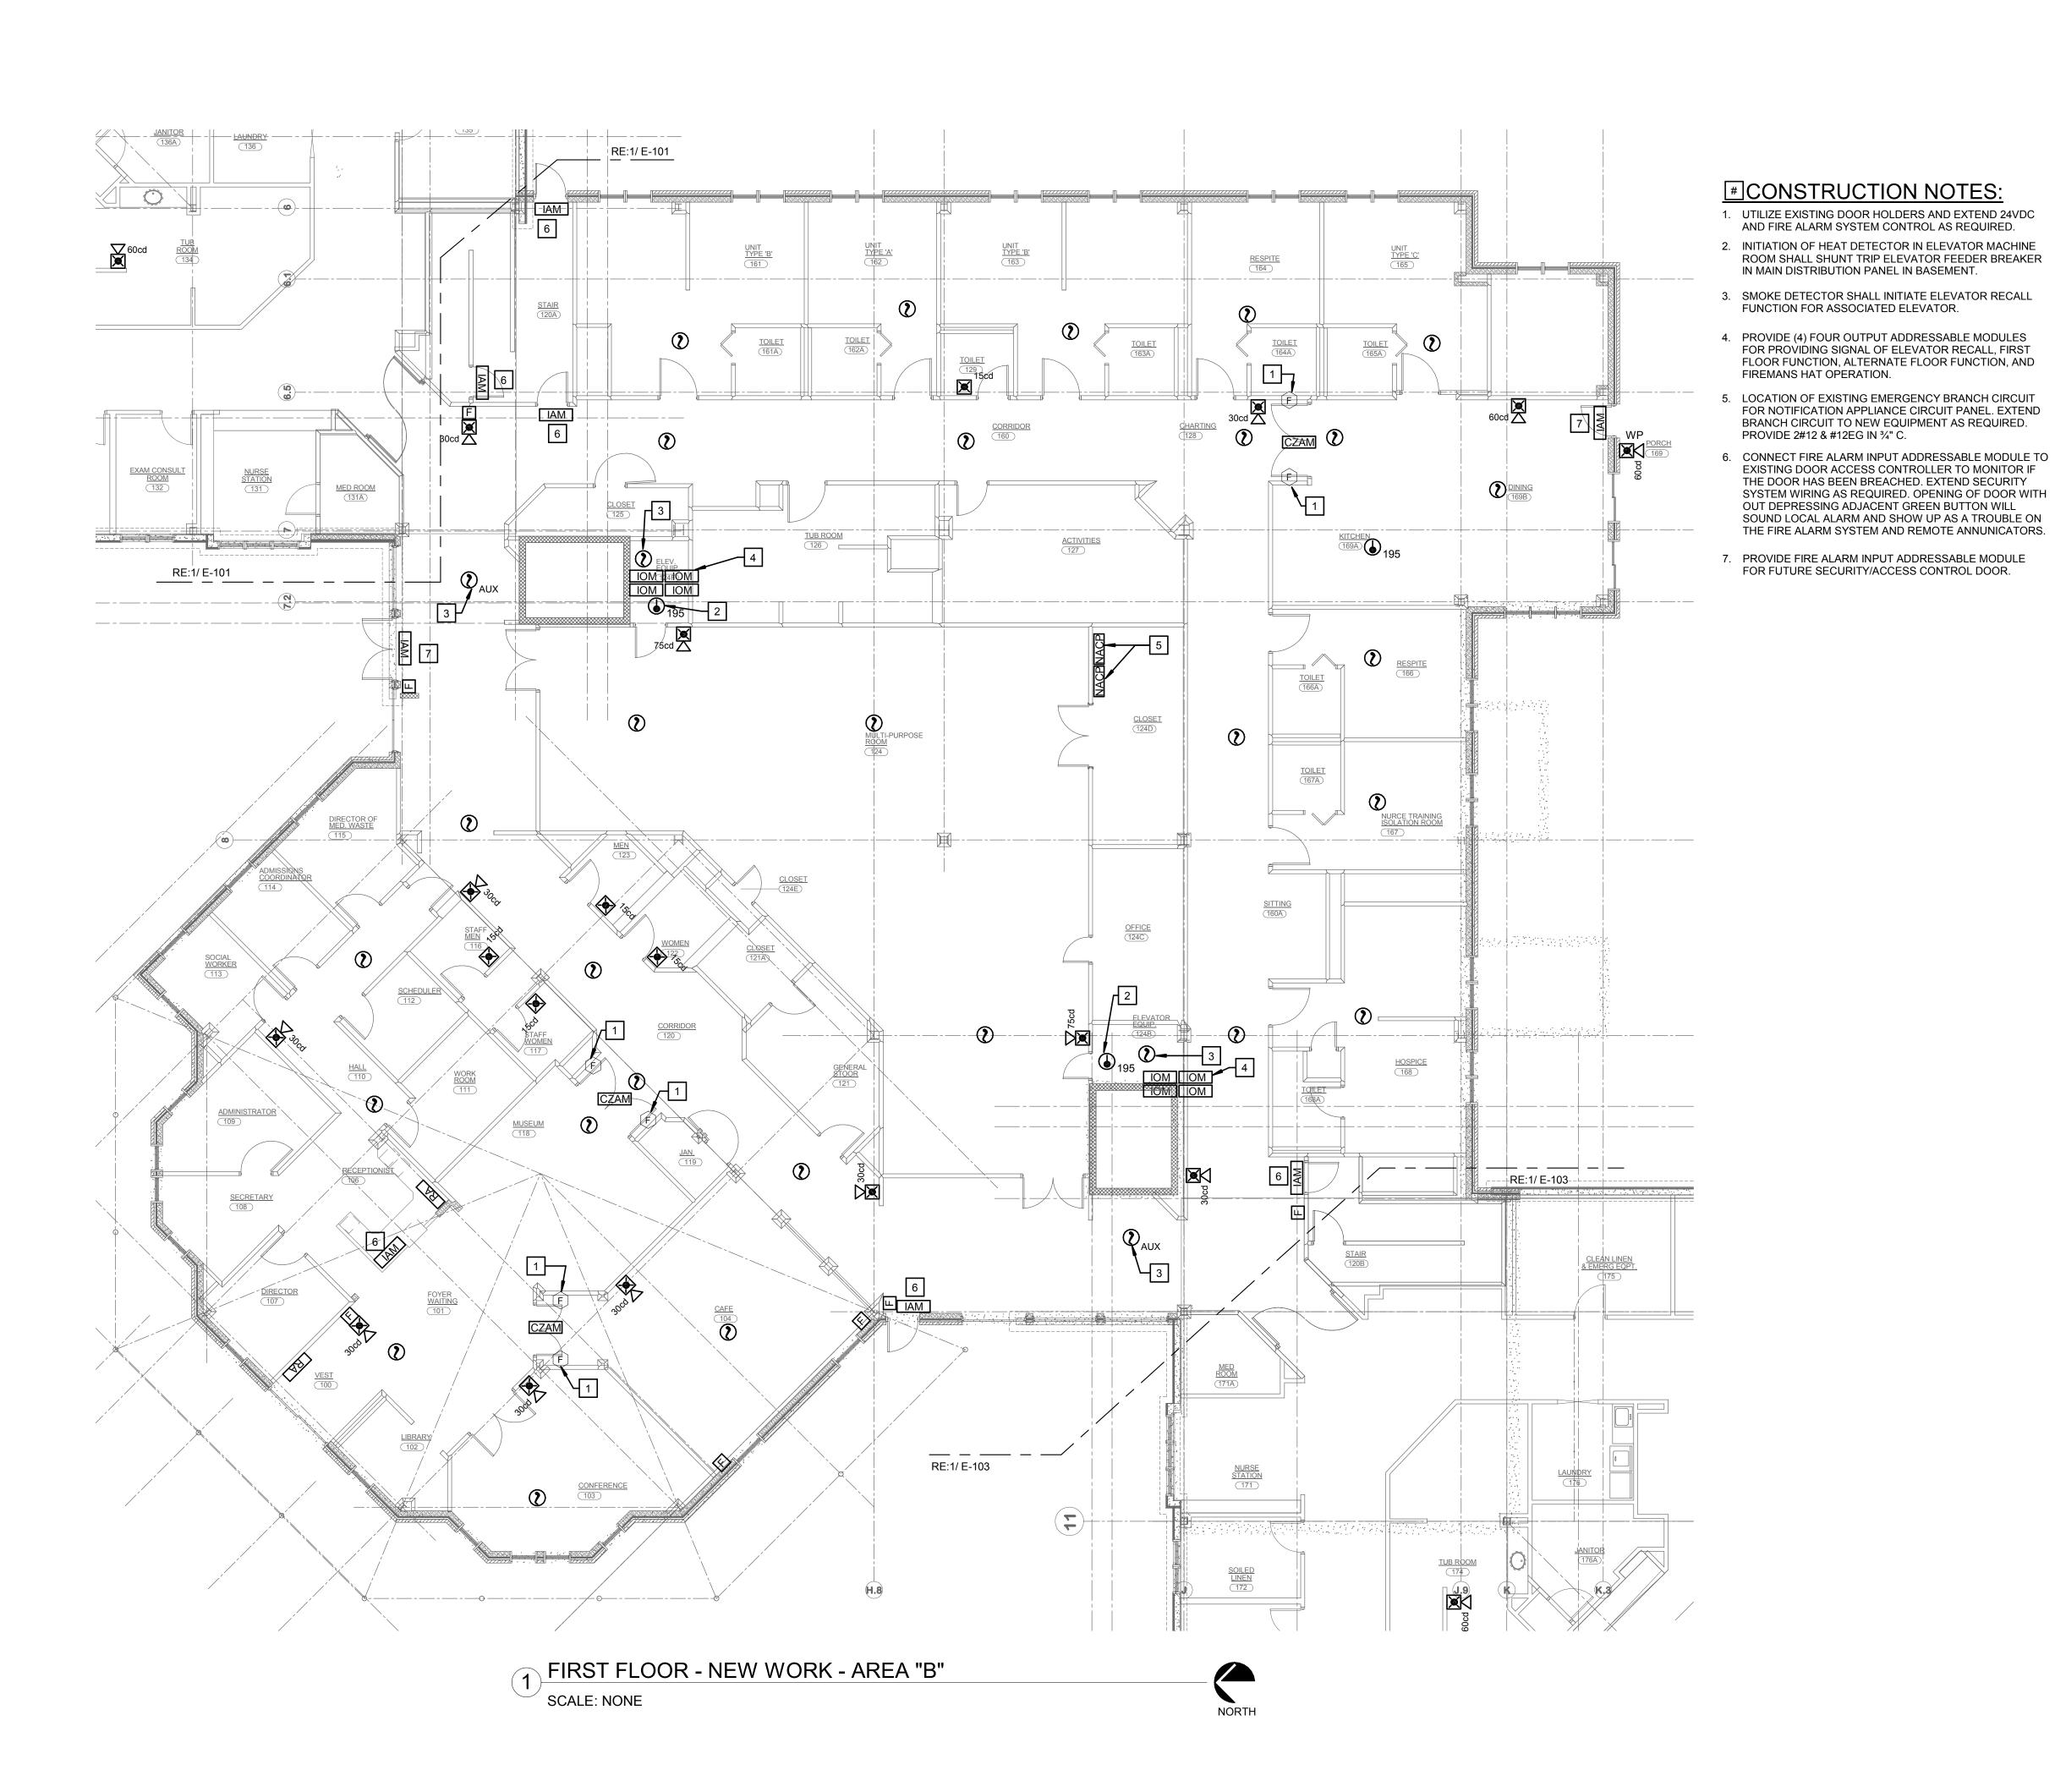
SCALE 1/8" = 1'-0"

SCALE 1/8" = 1'
DWN. CDW

PROJ. No. 307663

PROJ. No. 307663

E-101





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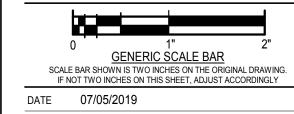
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DWG TITLE

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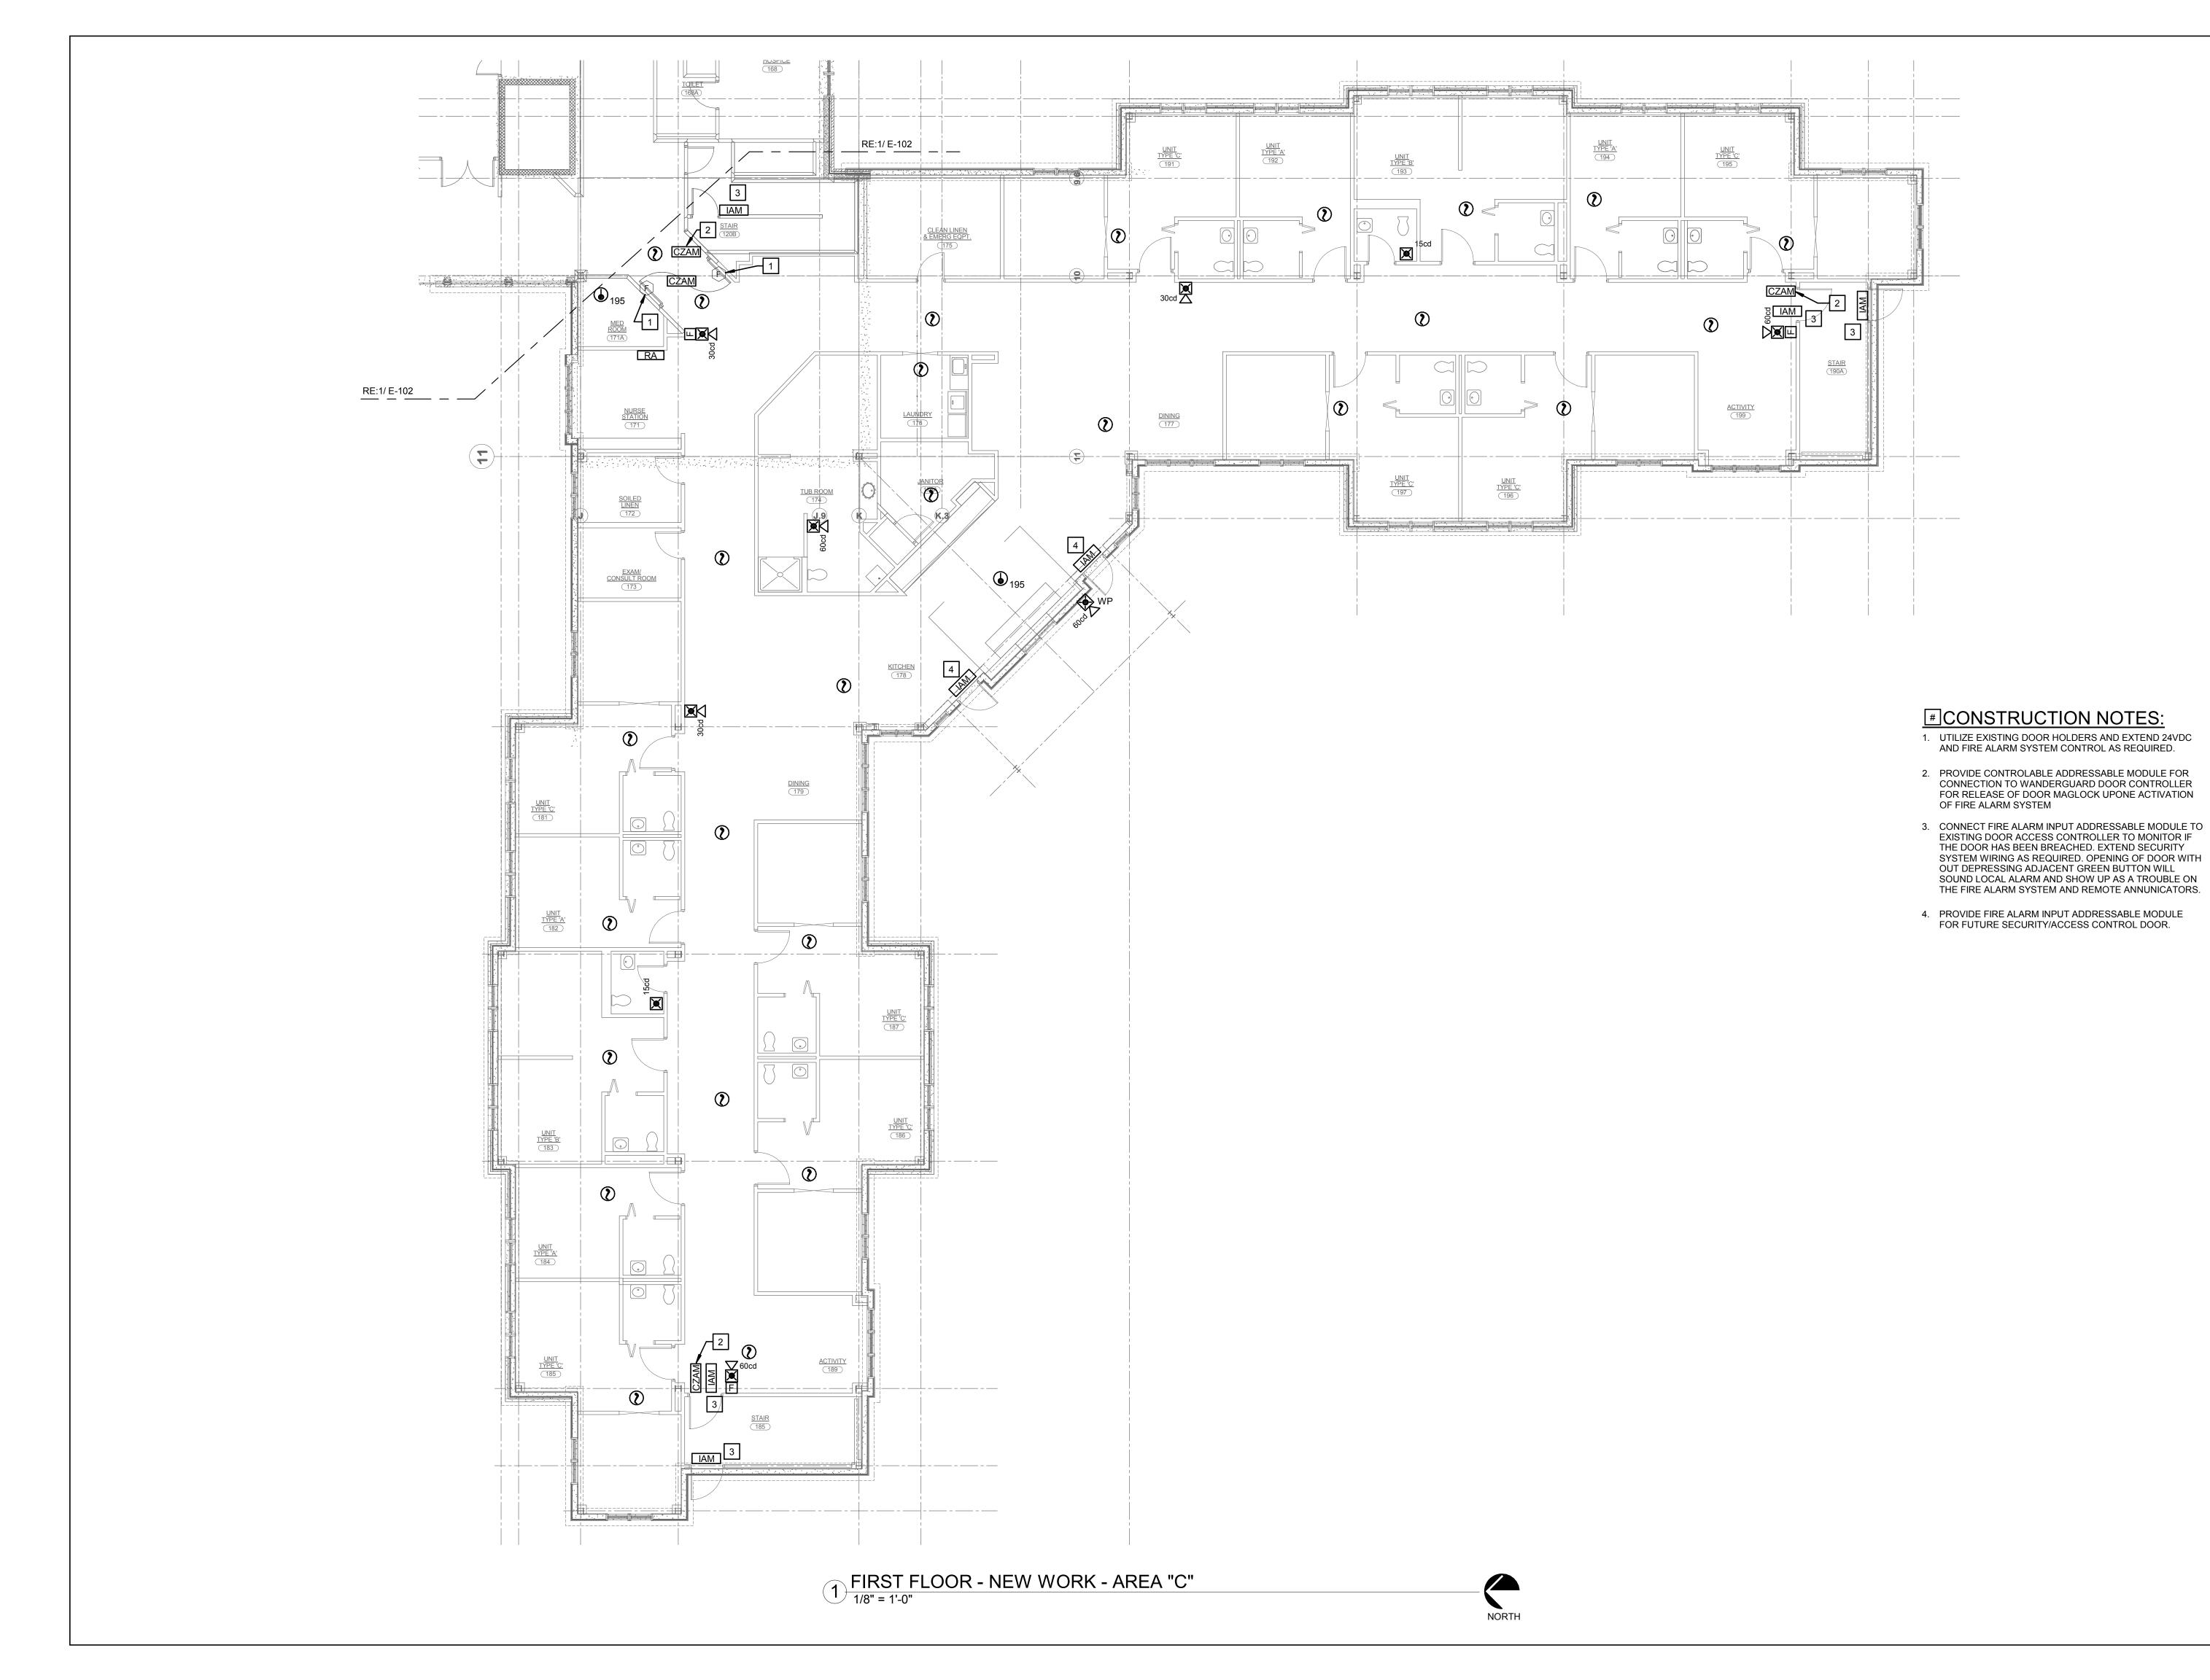


SCALE 1/8" = 1'-0"

DWN. CDW

PROJ. No. 307663

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FIRST FLOOR - NEW WORK -AREA "C"

O 1" 2"

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SCALE 1/8" = 1'-0"

SCALE 1/8" = 1'-0"

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PROJ. No. 307663

DWG. No.

E-103





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SECOND FLOOR - NEW WORK -AREA "A"

0 1" 2"

GENERIC SCALE BAR

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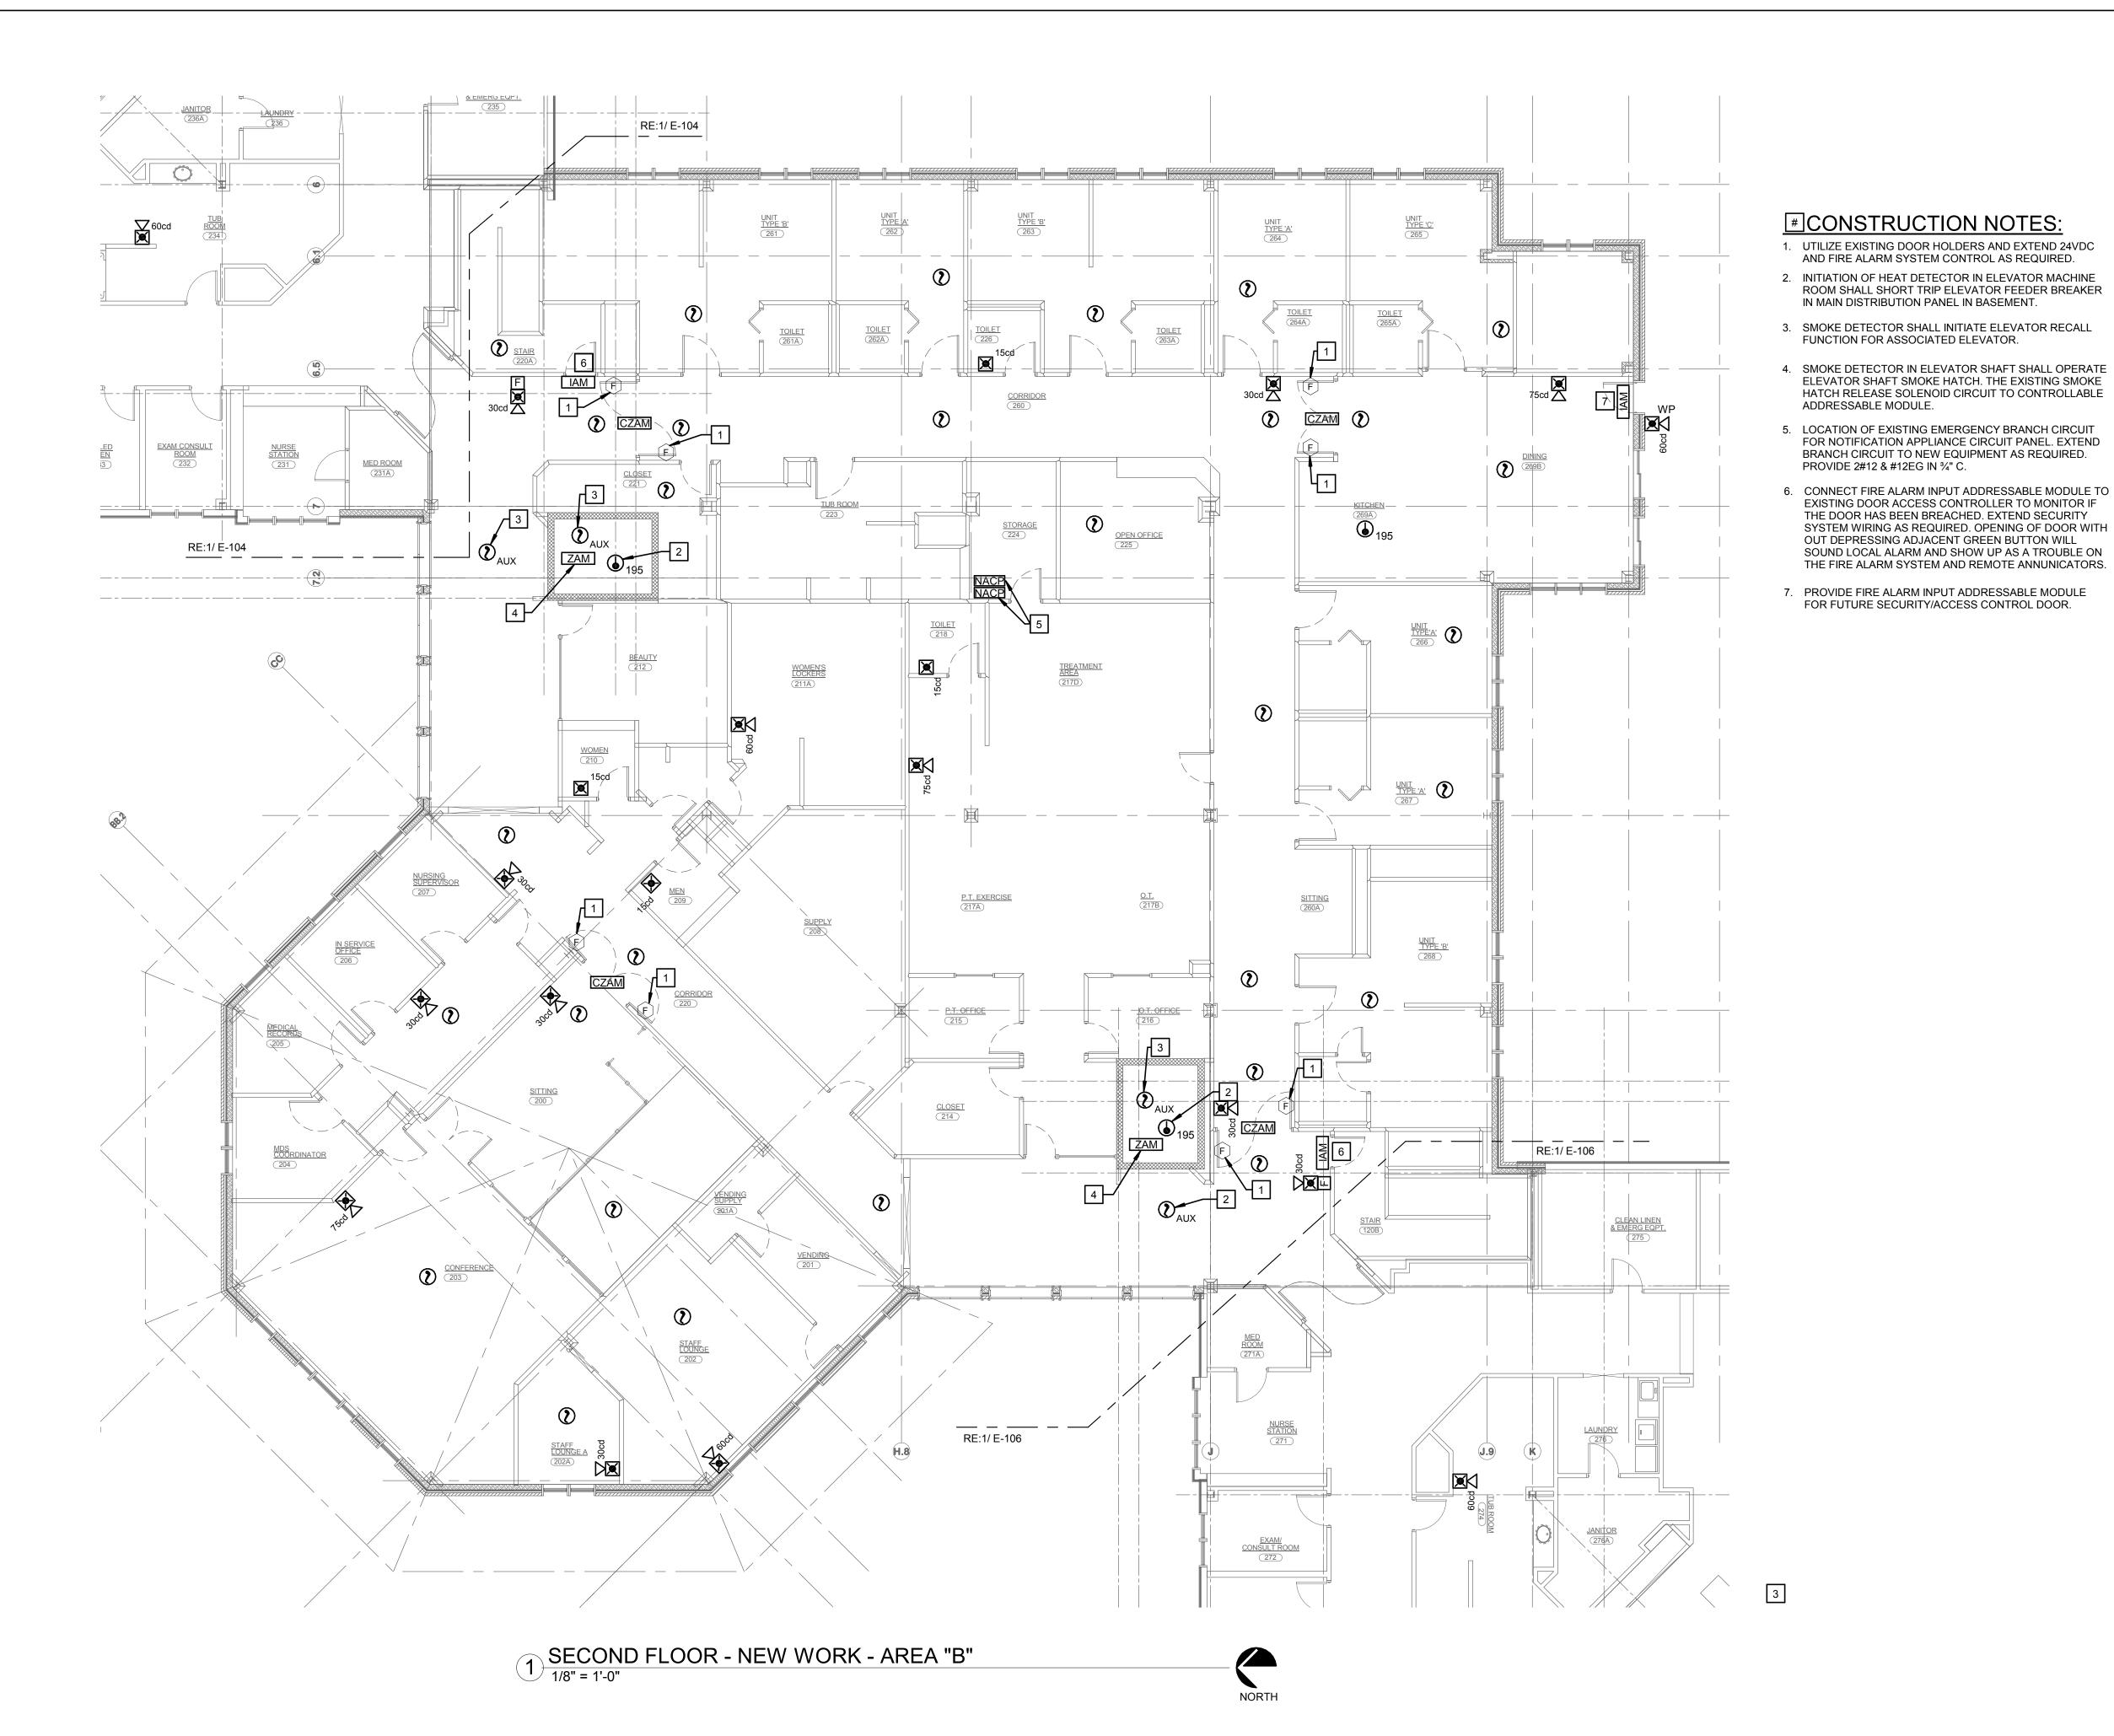
DATE 07/05/2019

SCALE 1/8" = 1'-0"

DWN. CDW

DWN. CDW
PROJ. No. 307663

E-104





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CATTARAUGUS COUNTY PINES MACHIAS FIRE ALARM DESIGN DEVELOPEMNT



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THE FIRE ALARM SYSTEM AND REMOTE ANNUNICATORS. Wendel WD Architecture, Engineering, Surveying and Landscape Architecture, P.C.

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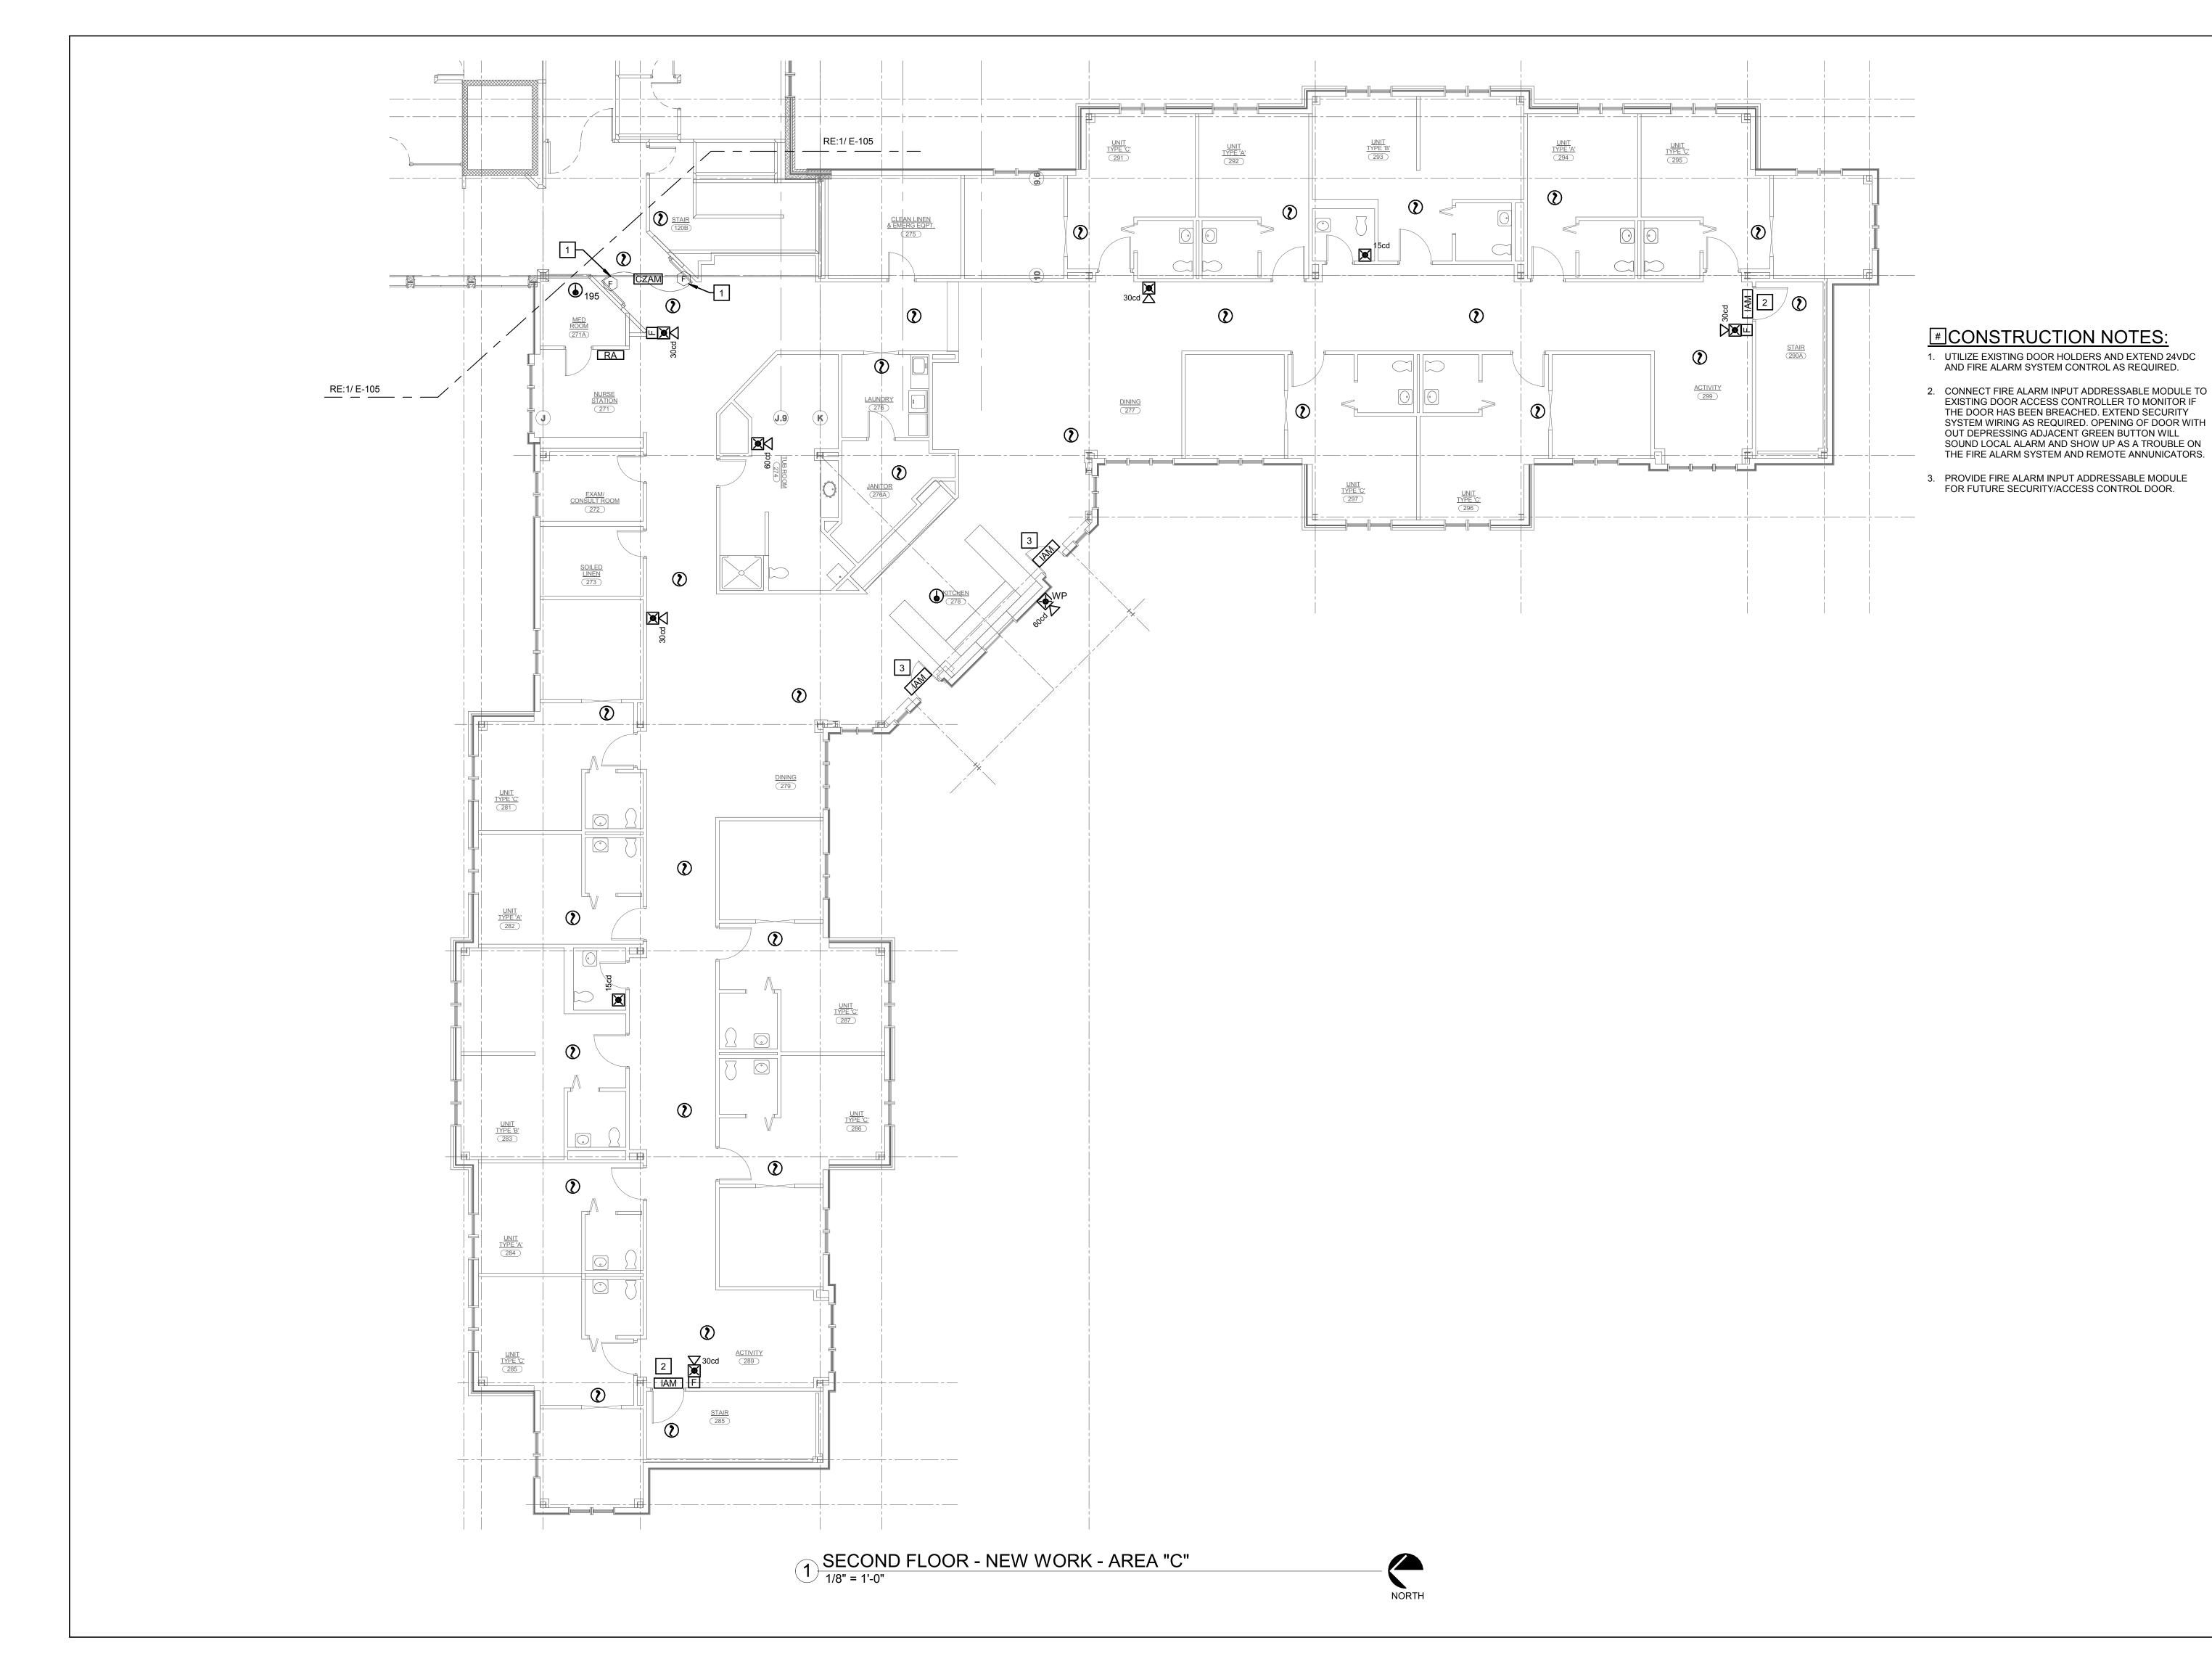
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SECOND FLOOR - NEW WORK -AREA "B"

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SCALE 1/8" = 1'-0" DWN. CDW PROJ. No. 307663

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DWG TITLE

SECOND FLOOR - NEW WORK - AREA "C"

0 1" 2"

GENERIC SCALE BAR

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DATE 07/05/2019

DATE 07/05/2019

SCALE 1/8" = 1'-0"

DWN. CDW

PROJ. No. 307663 DWG. No.

E-106

#CONSTRUCTION NOTES:

CONTRACTOR TO LOACTE REMOTE TEST STATION IN FACE OF SECOND FLOOR CEILING TILE BELOW DUCT MOUNTED SMOKE DETECTOR.




9822 ROUTE 16 MACHIAS, NEW YORK

CATTARAUGUS COUNTY PINES MACHIAS FIRE ALARM DESIGN DEVELOPEMNT




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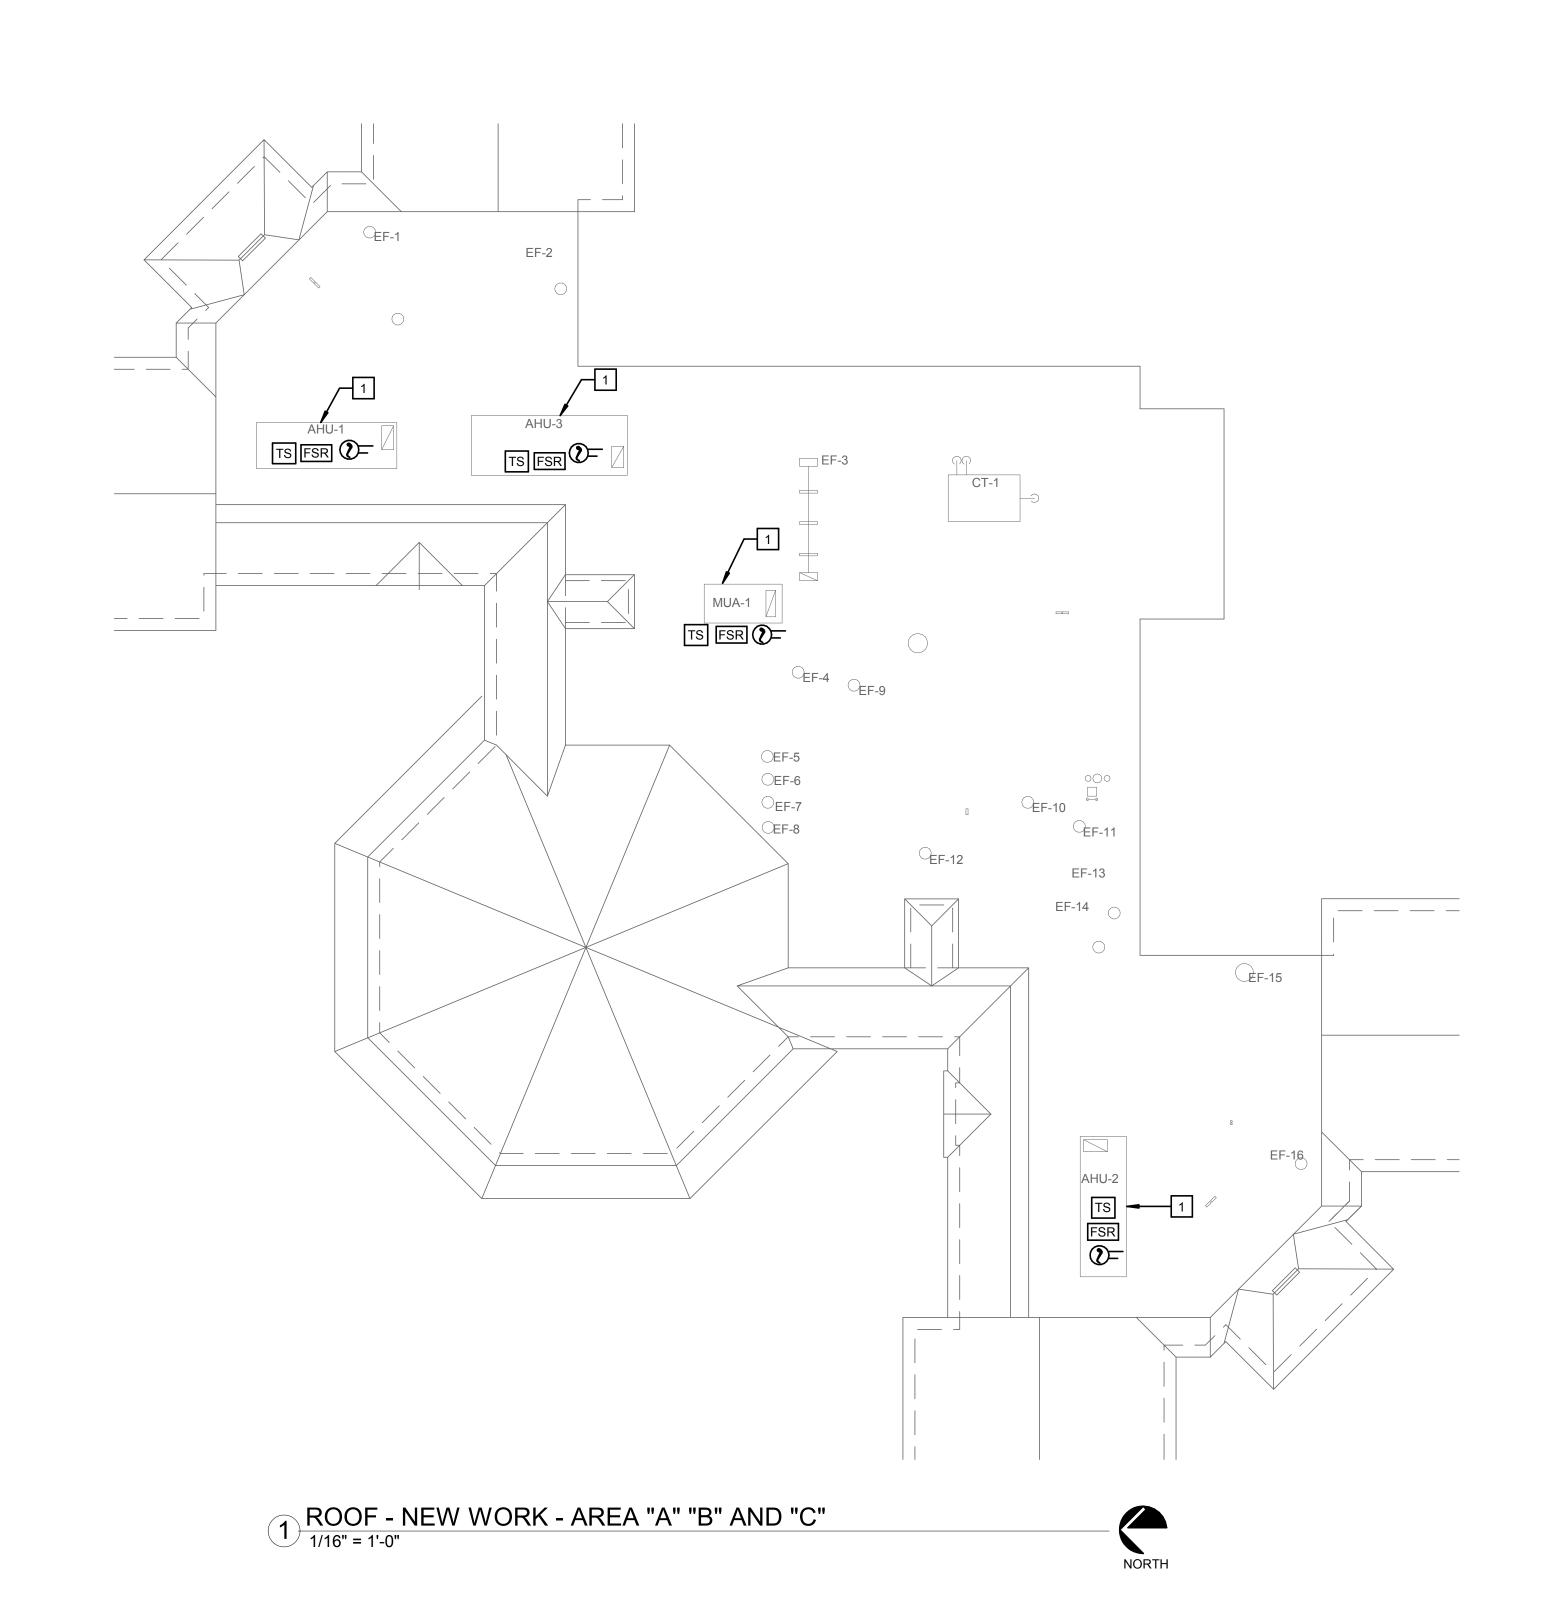



ROOF - NEW WORK

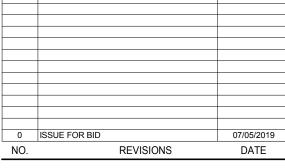


SCALE As indicated DWN. CDW PROJ. No. 307663

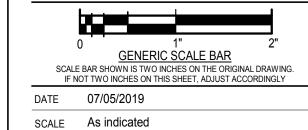E-107



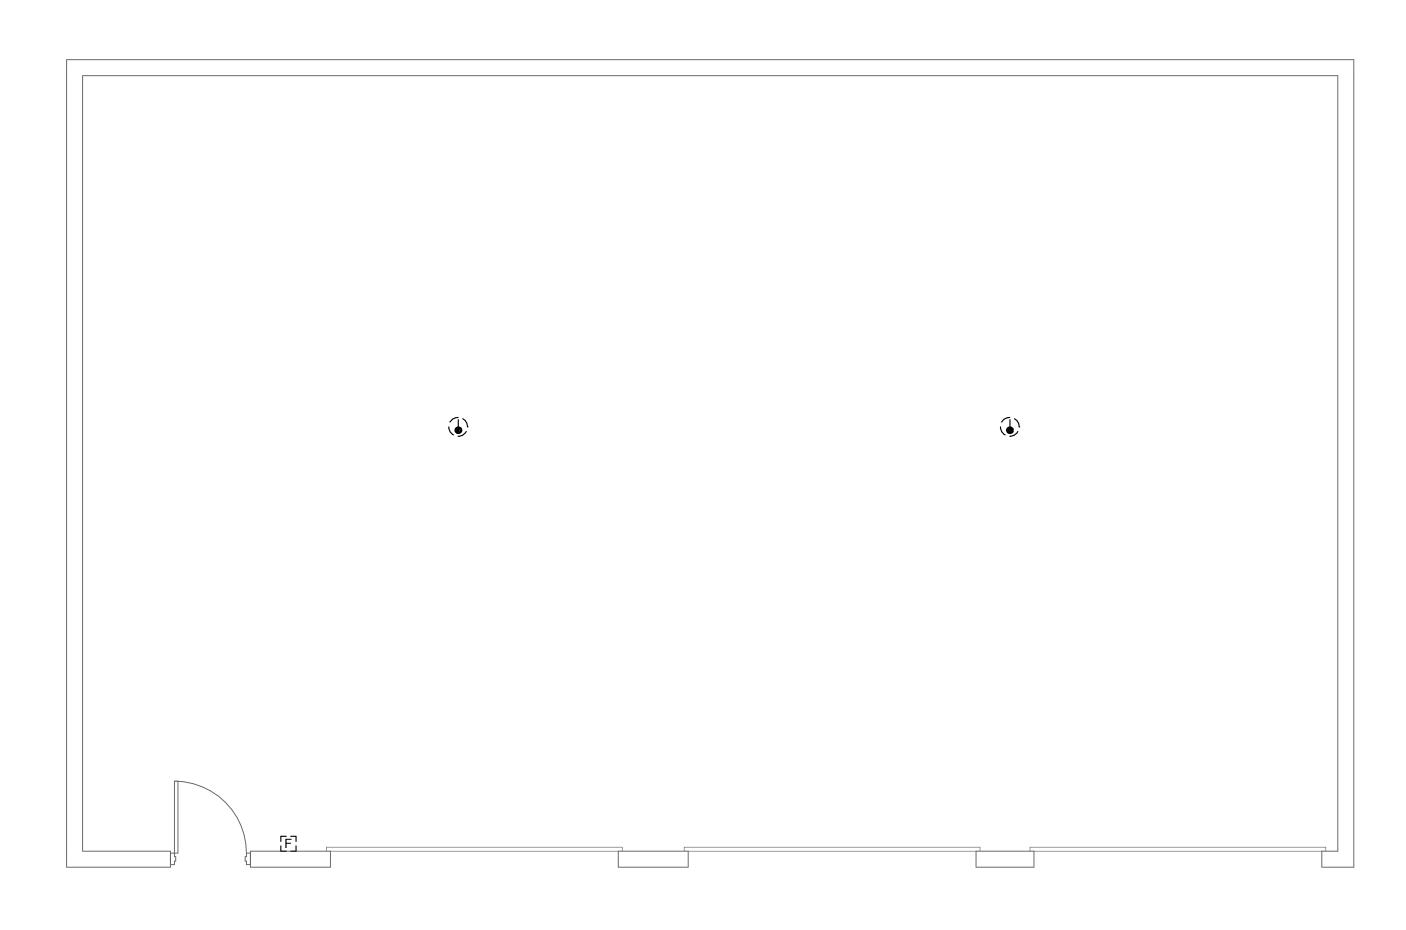

MAINTENACE GARAGE - REMOVALS 1/4" = 1'-0"

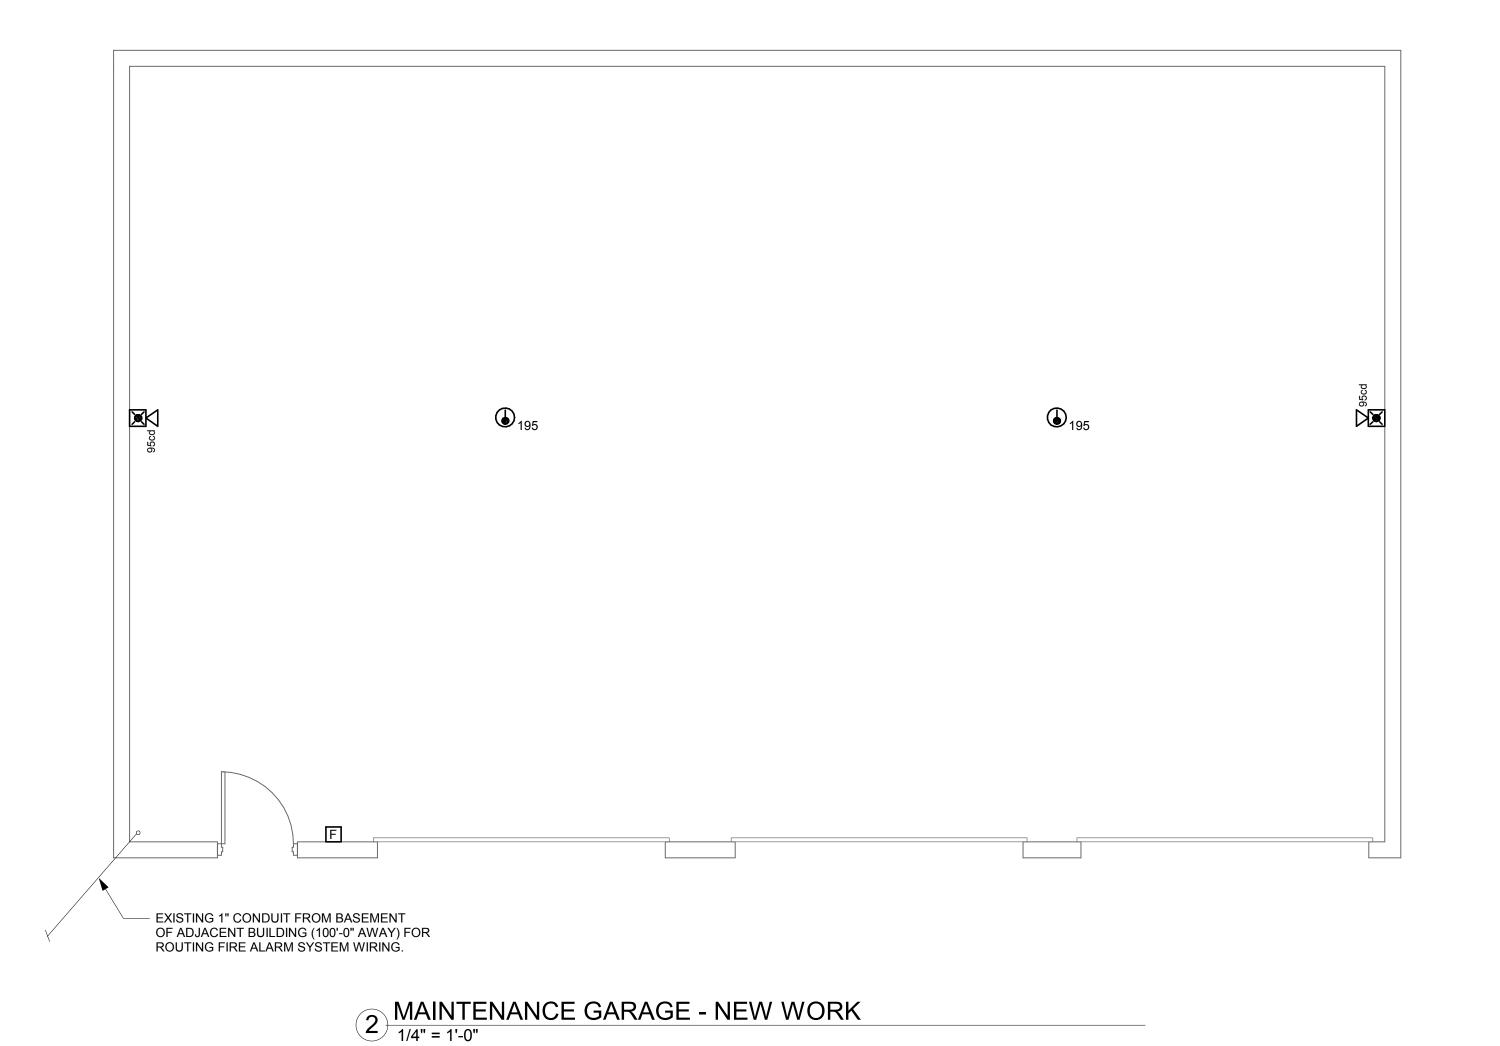

GENERAL DEMOLITION NOTES:

- A. MAINTAIN INTEGRITY OF EXISTING CIRCUIT WIRING PRESENTLY INSTALLED AND SERVING EQUIPMENT OUTSIDE THE WORK AREA. VERIFY ROUTE OF EACH FEEDER AND BRANCH CIRCUIT SCHEDULED FOR REMOVAL.
- B. PROVIDE PROTECTION FOR ALL EXISTING
 CONSTRUCTION SYSTEMS/EQUIPMENT SCHEDULED TO
 REMAIN DURING CONSTRUCTION. CONTRACTOR SHALL
 BE RESPONSIBLE FOR REPLACEMENT OR
 RECONDITIONING OF EQUIPMENT/ITEMS DAMAGED
 DURING REMOVALS.
- C. FIRE ALARM AND SECURITY SYSTEMS SHALL REMAIN OPERATIONAL DURING CONSTRUCTION. PROVIDE TEMPORARY WIRING AS REQUIRED TO MAINTAIN FIRE ALARM SYSTEM DETECTION/NOTIFICATION THROUGHOUT CONSTRUCTION PHASE AND OPERATION OF SECURITY SYSTEM. NOTIFY OWNER OF AREAS TO BE SHUTDOWN WHILE WORK IS BEING PREFORMED. FIRE ALARM AND SECURITY SYSTEMS SHALL BE FULLY OPERATIONAL AT END OF EACH WORK DAY. CONTRACTOR SHALL NOTE LEAVE ANY AREAS WITHOUT FIRE ALARM SYSTEM BEING FULLY FUNCTIONAL AND SECURITY SYSTEM FULLY OPERATIONAL.
- D. UNLESS OTHERWISE NOTED, DISCONNECT AND REMOVE ALL ELECTRICAL WORK ASSOCIATED WITH DEVICE/FIXTURE SCHEDULED FOR REMOVAL. ASSOCIATED ELECTRICAL WORK SHALL INCLUDE BUT NOT LIMITED TO CONDUCTORS, CONDUIT, BOXES, CONNECTORS, HANGERS, CONTROL EQUIPMENT, ETC. BACK TO SOURCE PANEL.
- E. CONTRACTOR SHALL PROPERLY DISPOSE OF ALL ELECTRICAL DEVICES AND MISC. ITEMS AS REQUIRED. CONTRACTOR IS RESPONSIBLE FOR ANY COST ASSOCIATED WITH DISPOSAL.
- F. DEMOLITION SHOWN SHALL BE SELECTIVE. UNLESS OTHERWISE INDICATED ON THE PLAN. THE CONTRACTOR SHALL NOTIFY THE ENGINEER OF DISCREPANCIES FOUND IN THE FIELD PRIOR TO DEMOLITION OF ANY ITEMS NOT SHOWN. CONTRACTOR SHALL, AT HIS EXPENSE, REPLACE OR REPAIR ANY DEMOLISHED ITEMS(S) THAT WERE NOT CALLED FOR ON THE PLANS OR BROUGHT TO ENGINEERS ATTENTION.



CATTARAUGUS COUNTY

9822 ROUTE 16 MACHIAS, NEW YORK

CATTARAUGUS COUNTY
PINES MACHIAS FIRE
ALARM
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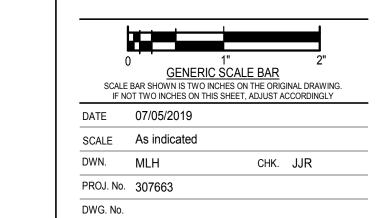


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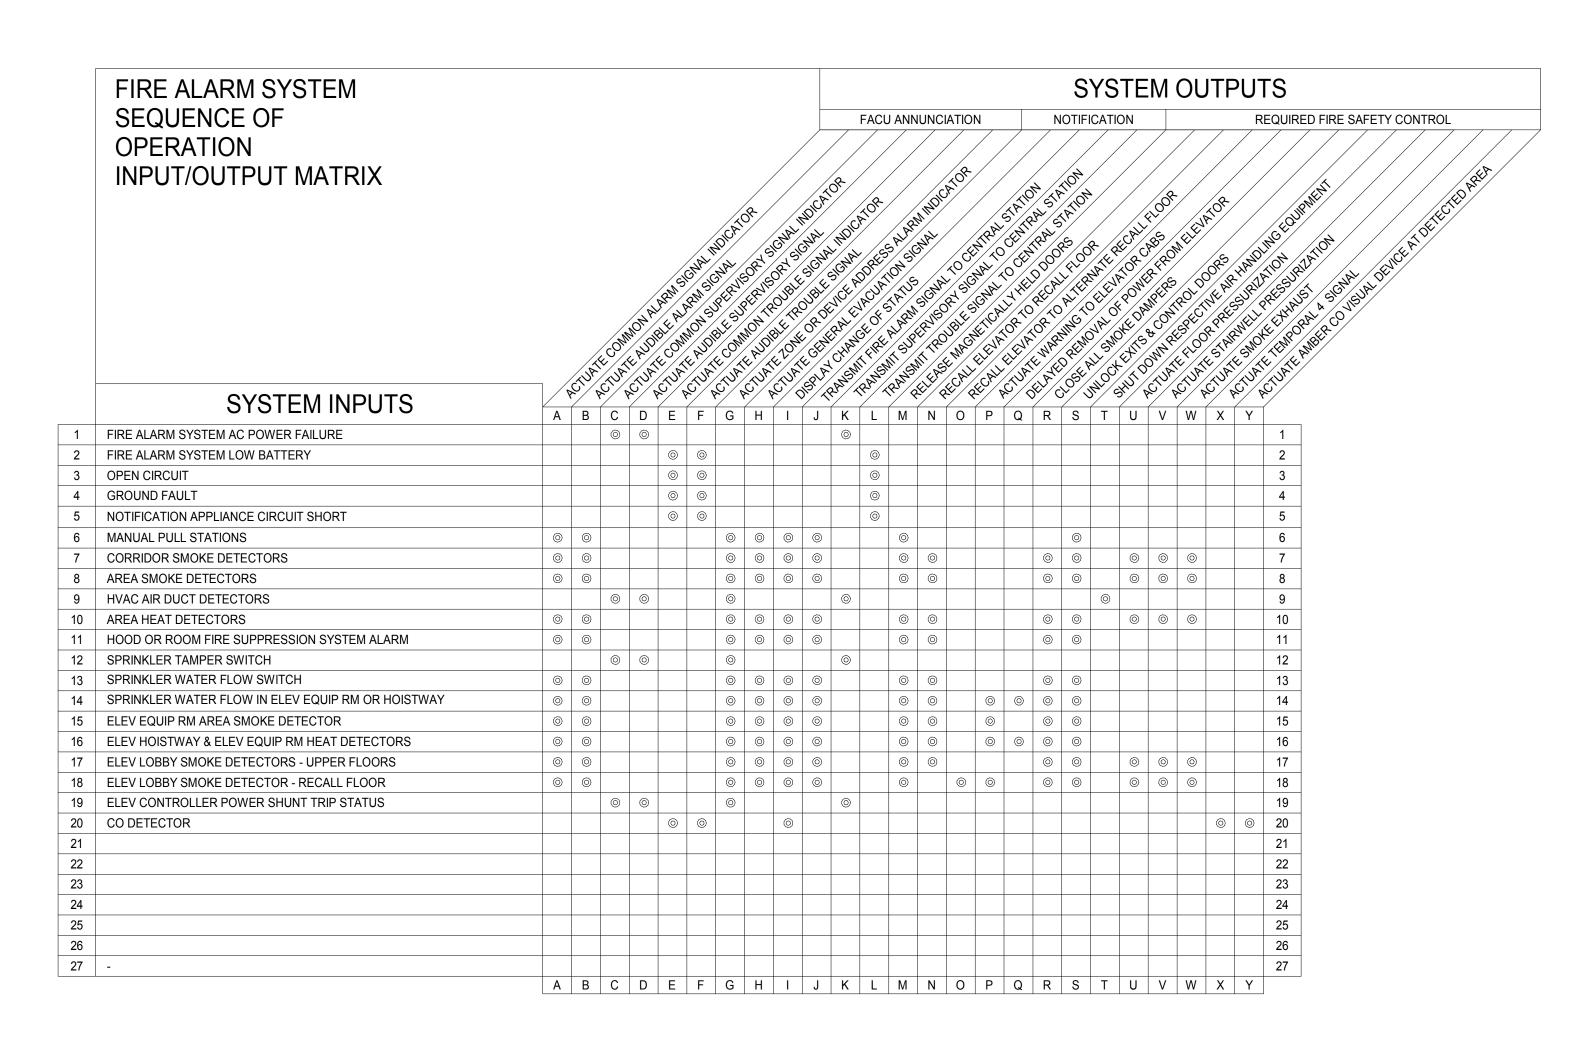
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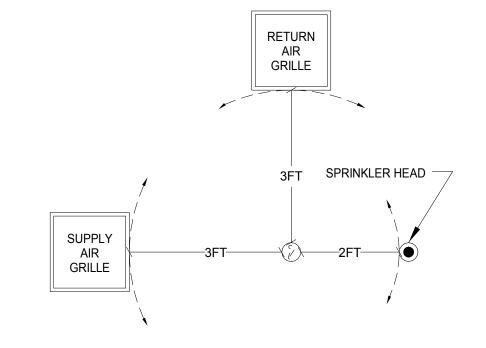
MAINTENANCE BUILDING -NEW WORK - REMOVALS




E-108




5 FIRE ALARM SYSTM INPUT OUTPUT MATRIX
SCALE: NONE




4 SMOKE DETECTOR MINIMUM CLEARANCES
SCALE: NONE

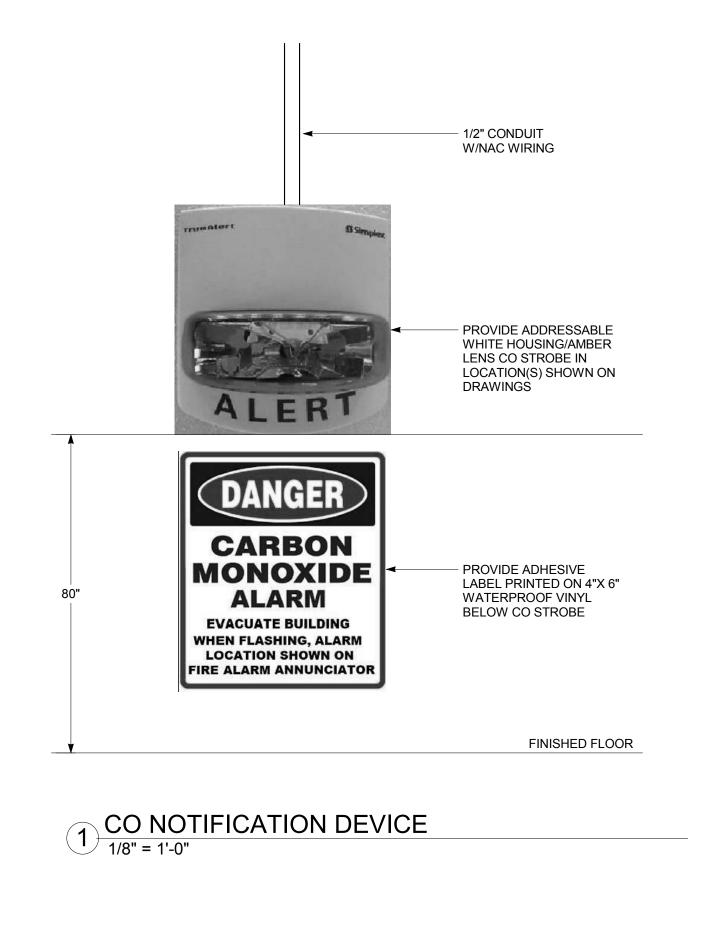

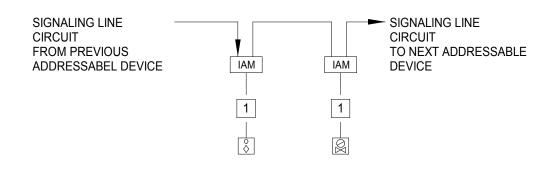


1. (1) NON DATA CONDUCTORS - (2) #14 AWG IN FLEXIBLE METAL RACEWAY.

2 TYPICAL SPRINKLER SYSTEM INTERFACE WIRING SCHEMATIC SCALE: NONE

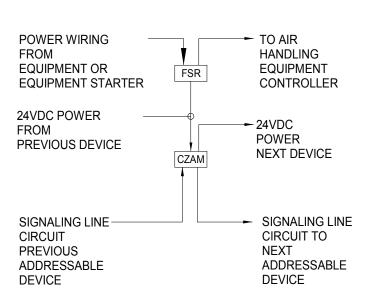

3 TYPICAL FAN SHUTDOWN RELAY WIRING DIAGRAM SCALE: NONE

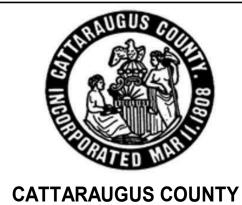


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DETAILS

DATE O7/05/2019


SCALE As indicated

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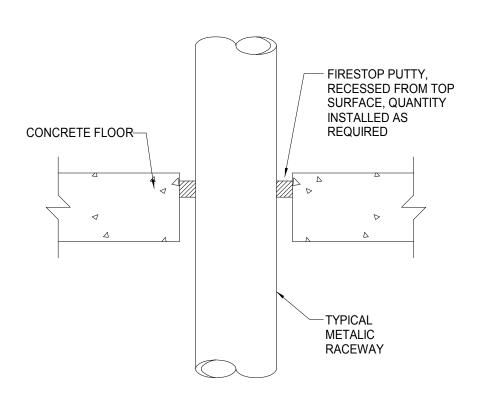
DWG. No.

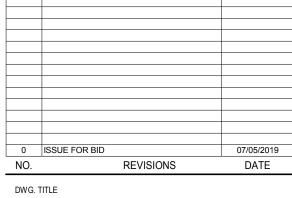

STUD WALL PENETRATION

* REFER TO UL FIRE RESISTANCE DIRECTORY FOR COMPLETE INSTALLATION REQUIREMENTS

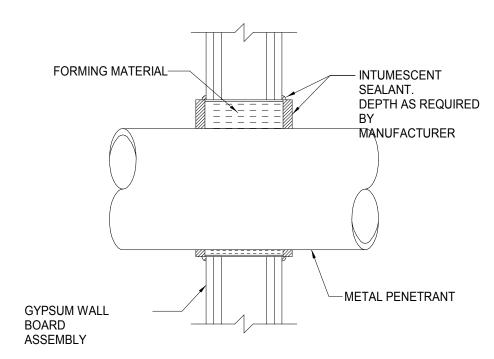
UL SYSTEM W-L-1079* STUD WALL PENETRATION DETAIL



CONCRETE FLOOR PENETRATION

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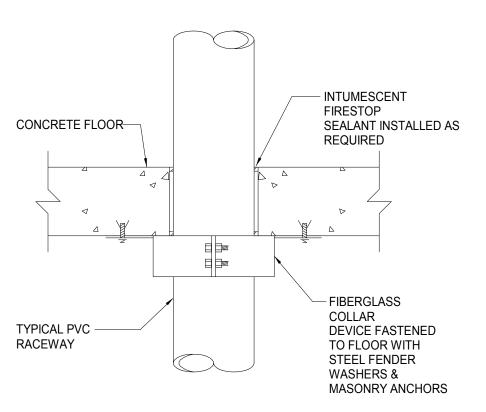
UL SYSTEM C-AJ-1090* CONCRETE FLOOR PENETRATION DETAIL 2 CONCRE SCALE: NONE

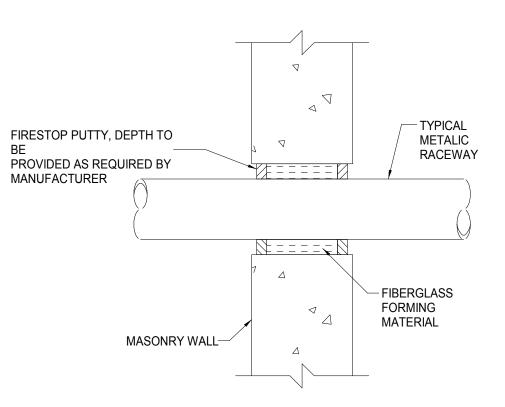

CONCRETE WALL PENETRATION

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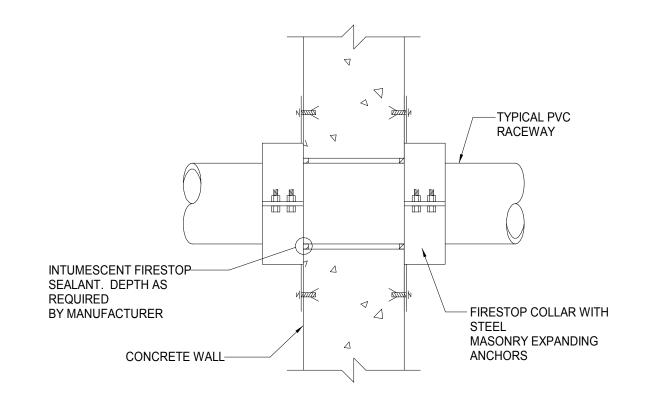
UL SYSTEM CA-J-1090* CONCRETE WALL PENETRATION DETAIL



CONCRETE FLOOR PENETRATION

REFER TO UL FIRE RESISTANCE DIRECTORY FOR COMPLETE INSTALLATION REQUIREMENTS

UL SYSTEM C-AJ-2038* CONCRETE FLOOR PENETRATION DETAIL



REFER TO UL FIRE RESISTANCE DIRECTORY FOR COMPLETE INSTALLATION REQUIREMENTS

CONCRETE WALL PENETRATION DETAIL

GENERAL NOTES:

A. CONTRACTOR SHALL GIVE OWNER 24 HOURS NOTICE OF ANY AND ALL PENETRATIONS PROVIDED, SO THAT OWNER CAN OBSERVE THE INSTALLATION OF THE PENETRATION AND FIRSTOPPING PROVIDED. WORK SHALL THEN BE SIGNED OFF BY OWNER.

CONCRETE WALL PENETRATION

UL SYSTEM C-AJ-2038*

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DETAILS

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PROJ. No. 307663

SCALE BAR SHOWN IS TWO INCHES ON THE ORIGINAL DRAWING. IF NOT TWO INCHES ON THIS SHEET, ADJUST ACCORDINGLY DATE 07/05/2019 SCALE 12" = 1'-0" DWN. CDW CHK. JJR

THROUGH PENETRATION FIRESTOP SCHEDULE • THIS SCHEDULE IDENTIFIES REQUIREMENTS FOR ACCEPTABLE THROUGH PENETRATION FIRESTOPS FOR THIS PROJECT BASED ON BARRIER TYPE, BASIS OF BARRIER CONSTRUCTION, AND PENETRANT TYPE. • THROUGH PENETRATION FIRESTOPS ARE NOT REQUIRED FOR FLOOR PENETRATIONS CONTAINED TOTALLY WITHIN A RATED SHAFT ENCLOSURE. NOMENCLATURE OF UL CLASSIFIED FIRESTOP ASSEMBLIES USED IN THE CONTRACT DOCUMENTS IS IDENTICAL TO THAT USED IN CATALOGS OF APPROVED FIRESTOP MANUFACTURERS AND IN UNDERWRITERS LABORATORIES "FIRE RESISTANCE DIRECTORY". RATED BARRIER PENETRANT TYPE FIRESTOP ASSEMBLY REQUIREMENTS BASIS OF CONSTRUCTION **ELECTRICAL BOXES** METALLIC CONDUIT NONMETALLIC CONDUIT UL # W-L-N/A CEYY OR CLIV 1079 SINGLE PENETRANT METAL STUDS & GYPSUM DETAIL #8 CLASSIFIED WALLBOARD WALL MULTIPLE PENETRANTS SERIES N/A (U400 SERIES) **EXCEPTIONS/ ADDED REQUIREMENTS** NOTE 1 N/A NOTE 1 & 2 UL # C-AJ-UL # C-AJ-CEYY 2038 POURED CONCRETE, CONCRETE SINGLE PENETRANT DETAIL #10 DETAIL #12 BLOCK OR MASONRY CLASSIFIED WALL SERIES MULTIPLE PENETRANTS N/A (BLOCK & U900 SERIES) (ANY THICKNESS) EXCEPTIONS/ ADDED REQUIREMENTS NOTE 1 NOTE 1 NONE

FLOOR

1. OPENINGS ACCOMODATING NONCOMBUSTIBLE CONDUITS THROUGH SINGLE MEMBRANES WHICH ARE PART OF A FIRE RESISTANCE RATED WALL ASSEMBLY ARE PERMITTED WHEN:

UL # C-AJ-

DETAIL #9

UL # C-AJ-

2038

DETAIL #11

CEYY

N/A

A. AGGREGATE AREA OF THE MEMBRANE OPENINGS DO NOT EXCEED 100 SQUARE INCHES FOR ANY 100 SQUARE FEET OF WALL AREA.

SINGLE PENETRANT

SERIES | MULTIPLE PENETRANTS |

2. CLASSIFIED TPFS ASSEMBLY IS NOT REQUIRED AT ELECTRICAL BOXES WHEN ALL THE FOLLOWING CONDITIONS ARE MET: A. ELECTRICAL BOX IS STEEL AND UL LISTED.


CLASSIFIED

B. AREA OF INDIVIDUAL BOX DOES NOT EXCEED 16 SQUARE INCHES.

POURED CONCRETE

(ANY THICKNESS)

C. OUTLET BOXES ON OPPOSITE SIDES OF THE WALL ARE SEPARATED BY A HORIZONTAL DISTANCE OF NOT LESS THAN 24 INCHES.

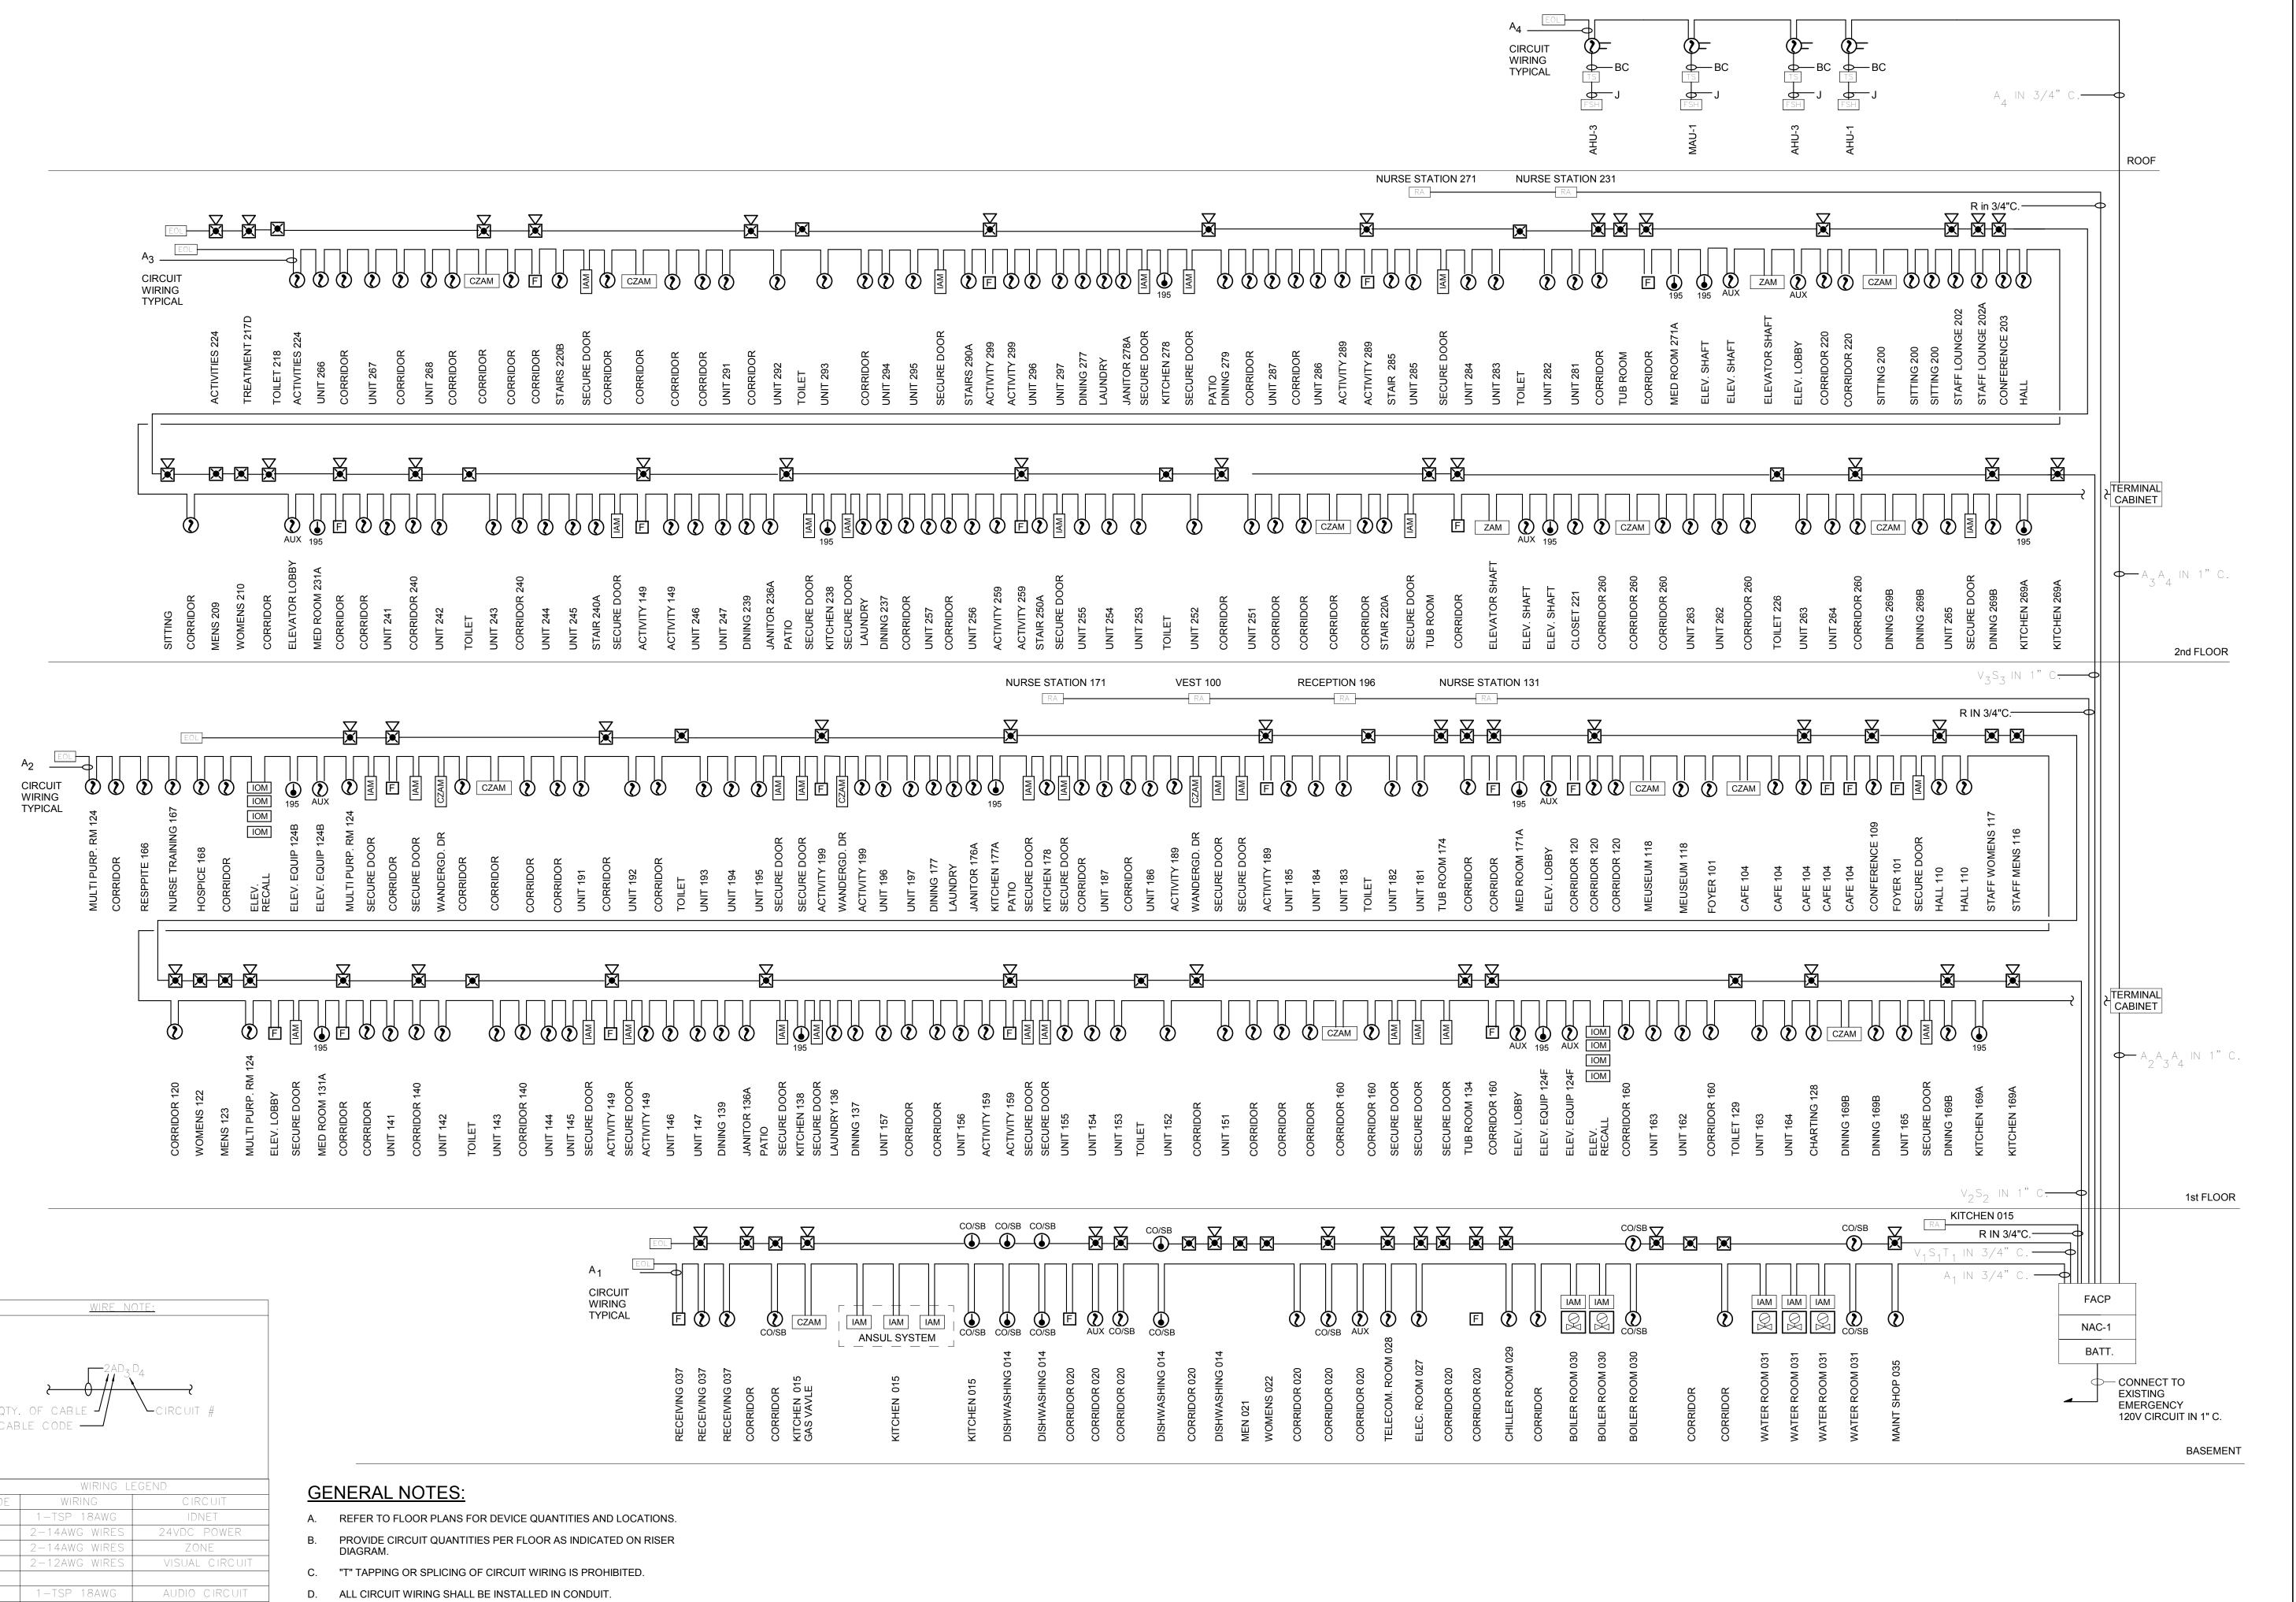



9822 ROUTE 16 MACHIAS, NEW YORK

CATTARAUGUS COUNTY PINES MACHIAS FIRE ALARM DESIGN DEVELOPEMNT



Wendel WD Architecture, Engineering, Surveying and Landscape Architecture, P.C.

 $\frac{\text{NOTE:}}{\text{THIS DOCUMENT, AND THE IDEAS AND DESIGNS INCORPORATED HEREIN, AS}}$ AN INSTRUMENT OF PROFESSIONAL SERVICE, IS THE PROPERTY OF WENDEL WD ARCHITECTURE, ENGINEERING, SURVEYING AND LANDSCAPE ARCHITECTURE, P.C. AND IS NOT TO BE USED IN WHOLE OR IN PART FOR ARCHITECTURE, P.C. AND IS NOT TO BE USED IN WHOLE OR IN PART, FOR ANY OTHER PROJECT WITHOUT THE WRITTEN AUTHORIZATION OF WENDEL. UNAUTHORIZED ALTERATION OR ADDITION TO ANY SURVEY DRAWING, DESIGN, SPECIFICATION, PLAN OR REPORT IS A VIOLATION OF SECTION 7209, PROVISION 2 OF THE NEW YORK STATE EDUCATION LAW.

0 ISSUE FOR BID 07/05/2019 DATE NO. REVISIONS DWG. TITLE

> FIRE ALARM ONE LINE **DIAGRAM**

SCALE BAR SHOWN IS TWO INCHES ON THE ORIGINAL DRAWING IF NOT TWO INCHES ON THIS SHEET, ADJUST ACCORDINGLY DATE 07/05/2019

SCALE: NONE DWN. CDW CHK. JJR PROJ. No. 307663

DWG. No.

E-600

ONE-LINE DIAGRAM - FIRE ALARM SCALE: NONE

EMPORAL 4 CIRC AN SHUTDOWN REL 2-14AWG WIRE 3—SP18ga.CABLE & 2—12ga.WIRES REMOTE PANELS

PROVIDE ANY REQUIRED PROGRAMMING UPGRADES TO EXISTINGNOTIFIER FIBER

OPTIC NETWORK INTERFACE NION PANEL.

ALL FIRE ALARM DEVICES SHALL BE NEW . FIRE ALARM SYSTEM SHALL BE COMPLETELY RE WIRED TO FACILITATE NEW CONSTRUCTION WORK.