CATTARAUGUS COUNTY COUNTY COURT COURTROOM RENOVATIONS

1 LEO MOSS DRIVE OLEAN, NEW YORK 14755

<u>ISSUED FOR: BID</u> - MARCH 25, 2019







GENERAL PROJECT NOTES:

- CONSTRUCTION SHALL CONFORM TO THE "NEW YORK STATE UNIFORM FIRE PROTECTION AND BUILDING CODE". LATEST REVISION. THE NEW YORK STATE ENERGY CODE AND ANY OTHER CODES GOVERNED BY THE JURISDICTION IN WHICH THE PROJECT IS BEING
- 3. CONSTRUCTION SHALL COMPLY WITH ALL LOCAL, STATE AND FEDERAL CODES AND REGULATIONS.
- 4. ALL DRAWINGS ARE GRAPHIC REPRESENTATIONS OF APPROXIMATE LOCATIONS OF MATERIALS. IT IS THE CONTRACTOR'S RESPONSIBILITY TO FIELD-VERIFY ALL CONDITIONS PRIOR TO COMMENCEMENT OF WORK. CONTRACTOR SHALL NOT SCALE THE
- 5. CONTRACTORS ARE RESPONSIBLE FOR ALL MATERIALS, CONSTRUCTION METHODS AND CRAFTSMANSHIP.
- 6. CONTRACTORS ARE TO VERIFY ALL EXISTING CONDITIONS, REQUIREMENTS, NOTES, AND DIMENSIONS, PRIOR TO THE START OF CONSTRUCTION AND SHALL NOTIFY THE ARCHITECT IF CONDITIONS VARY FROM THOSE SHOWN ON THE DOCUMENTS.
- CONTRACTORS ARE TO RESPONSIBLE TO PROVIDE ADEQUATE SUPPORT OF EXISTING FOUNDATION WALLS, LOAD BEARING WALLS, PARTITIONS AND CEILINGS DURING DEMOLITION AND CONSTRUCTION.
- 8. CONTRACTORS ARE RESPONSIBLE FOR THOROUGH COORDINATION OF WORK AND DETERMINE EXACT ROUTE AND LOCATION OF UTILITIES, MATERIALS AND EQUIPMENT BEFORE FABRICATION AND INSTALLATION WHEREVER THEY OVERLAP. NOTIFY THE
- ARCHITECT/ENGINEER IN WRITING IF FIELD CONDITIONS VARY FROM THOSE SHOWN ON THE DOCUMENTS. WHEN EXISTING CONSTRUCTION IS REMOVED, DISTURBED, DAMAGED, REPLACED OR RENOVATED IN ANY WAY, CONTRACTORS

SHALL PROVIDE PATCHING, PAINTING AND MATERIALS OF SAME TYPE AND QUALITY AS TO MATCH ADJACENT EXISTING SURFACES,

- UNLESS OTHERWISE NOTED. 10. AREAS OF THE SITE DISTURBED DURING THE CONSTRUCTION PROCESS SHALL BE CORRECTED TO THE SATISFACTION OF THE
- 11. PROVIDE ALL BLOCKING, FURRING AND SHIMMING FOR INSTALLATION AND COMPLETION OF WORK.
- 12. ALL WORK SHALL BE PLUMB, LEVEL AND SQUARE. SCRIBE AND MAKE FIT ALL NEW TO EXISTING AND ALL NEW TO NEW.
- 13. VERIFY ALL DIMENSIONS BEFORE ORDERING MATERIAL OR DOING WORK. NO EXTRA COMPENSATION OR CHARGES WILL BE ACCEPTED DUE TO DIFFERENCES BETWEEN THE ACTUAL MEASUREMENTS AND MEASUREMENTS INDICATED ON THE DRAWINGS.
- 14. ALL DETAILS ARE SUBJECT TO CHANGE DUE TO EXISTING FIELD CONDITIONS, CONTRACTOR MUST NOTIFY ARCHITECT IN WRITING OF
- 15. ITEMS NOTED AS 'BY OWNER' ARE TO BE FURNISHED AND INSTALLED BY THE OWNER OR THE OWNER'S VENDOR.
- 16. ITEMS NOTED 'OWNER FURNISHED CONTRACTOR INSTALLED (O.F.C.I.)' ARE TO BE SUPPLIED BY OWNER AND INSTALLED BY THE GENERAL CONTRACTOR.
- 17. OWNER PROVIDED EQUIPMENT IS INDICATED FOR REFERENCE ONLY. VERIFY DIMENSIONS AND CLEARANCE REQUIREMENTS WITH
- 18. SECURITY, WEATHERPROOFING, DUST CONTROL AND SAFETY SHALL BE THE FULL RESPONSIBILITY OF THE CONTRACTOR. CONTRACTOR SHALL PERFORM CLEAN UP OF ALL REFUSE, RUBBISH, SCRAP MATERIALS AND DEBRIS CAUSED BY THE WORK ON A DAILY BASIS AND DISPOSE OF LEGALLY OFF SITE.
- CONTRACTORS ARE RESPONSIBLE FOR OBTAINING ALL PERMITS ASSOCIATED WITH THE WORK OF THEIR CONTRACT IN ACCORDANCE WITH PLANS APPROVED BY <u>CATTARAUGUS COUNTY</u>.

GENERAL PROJECT REMOVAL NOTES:

- ALL DEMOLITION WORK IS TO BE REVIEWED WITH THE ARCHITECT/ENGINEER PRIOR TO THE COMMENCEMENT OF WORK.
- EXISTING CONDITIONS ARE TAKEN FROM FIELD OBSERVATIONS AND PRIOR CONSTRUCTION DOCUMENTS WHEN AVAILABLE AND ARE NOT GUARANTEED. CONTRACTOR SHALL FIELD VERIFY ALL EXISTING CONDITIONS PRIOR TO BID. NO ALLOWANCE WILL BE MADE FOR ADDITIONAL COSTS DUE TO CONTRACTORS FAILURE TO VERIFY EXISTING CONDITIONS AND DIMENSIONS.
- 3. ALL DEBRIS AND MATERIALS DESIGNATED FOR REMOVAL SHALL BECOME THE PROPERTY OF THE CONTRACTOR, UNLESS OTHERWISE NOTED, AND THE CONTRACTOR SHALL DISPOSE OF ALL DEMOLITION AND/OR OTHER WASTE MATERIALS, CAUSED BY THIS CONSTRUCTION, OFF SITE IN A PROPER LEGAL MANNER.
- 4. WHEN EXISTING CONSTRUCTION WHICH IS TO REMAIN IS DAMAGED DURING THE COURSE OF CONSTRUCTION AS A RESULT OF CONTRACTORS WORK, IT SHALL BE REPAIRED AND/OR REPLACED WITH SIMILAR OR LIKE MATERIALS, SUBJECT TO ARCHITECTS APPROVAL AND WITHOUT COMPENSATION.
- 5. CONTRACTORS ARE RESPONSIBLE FOR WORK OF THEIR TRADES AS INDICATED ON ALL DRAWINGS, UNLESS OTHERWISE NOTED.
- WHERE ITEMS HAVE BEEN REMOVED AND ANCHORS, LUGS, BRACKETS, SUPPORTS, VOIDS, ETC., REMAIN, THEY ARE TO BE REMOVED AND PATCHED TO MATCH AT NO ADDITIONAL COST TO THE OWNER.
- 7. ALL AREAS SCHEDULED FOR NEW FLOOR, WALL AND/OR CEILING FINISHES ARE TO HAVE OLD FINISHES REMOVED, LEVELED, PATCHED AND PREPARED FOR NEW FINISHES AT NO ADDITIONAL COST TO THE OWNER. IF FLOORING, WALLS OR CEILINGS ARE REMOVED UNDER A SEPARATE CONTRACT, THE GENERAL CONTRACTOR IS RESPONSIBLE FOR LEVELING, PATCHING AND PREPARATION FOR NEW FINISHES.
- 8. IF REMOVED EQUIPMENT PASSES THROUGH ROOF, PATCH ROOF ACCORDING TO ROOFING MANUFACTURERS REQUIREMENTS CONTACT ROOFING MANUFACTURER AND PROVIDE PROOF OF CONTINUATION OF EXISTING WARRANTY.
- 9. ALL SECURITY, WEATHERPROOFING, DUST CONTROL, AND SAFETY SHALL BE THE FULL RESPONSIBILITY OF THE CONTRACTOR.
- 10. CONTRACTOR TO COORDINATE WITH OWNER, TO REMOVE, TEMPORARILY STORE AND RELOCATE EXISTING FURNITURE AND ALL EXISTING LOOSE EQUIPMENT ITEMS AS NECESSARY TO ACCOMMODATE DEMOLITION AND RENOVATION.

DRAWING INDEX:

SHEET NUMBER	SHEET NAME										
GENERAL											
G-000	ARCHITECTURAL COVER SHEET										
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G-002	CODE COMPLIANCE AND LIFE SAFETY PLANS										
G-003	PROJECT PHASING PLAN- SECOND FLOOR										
ARCHITECTURAL											
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A-002	PARTITION TYPES & DETAILS										
A-010	FIRST FLOOR DEMOLITION PLAN										
A-012	SECOND FLOOR DEMOLITION PLAN										
A-101	SECOND FLOOR PLAN										
A-111	SECOND FLOOR REFLECTED CEILING PLAN										
A-210	ENLARGED COURTROOM 1 PLAN & INTERIOR ELEVATIONS										
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A-601	DOOR / WINDOW & FRAME TYPES, SCHEDULES & DETAILS										
INTERIORS											
I-101	ENLARGED SECOND FLOOR COURTROOM FINISH PLANS										
MECHANICAL											
M-001	MECHANICAL LEGEND SHEET										
M-012	SECOND FLOOR DUCTWORK DEMOLITION PLAN										
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M-501	MECHANICAL DETAILS AND SCHEDULES										
FIRE PROTECTION											
F-001	FIRE PROTECTION LEGEND SHEET										
F-102	SECOND FLOOR CEILING FIRE PROTECTION PLAN										
ELECTRICAL											
E001	ELECTRICAL NOTES, SYMBOL LEGEND, & ABBREVIATIONS										
E102	SECOND FLOOR POWER PLAN										
E202	SECOND FLOOR LIGHTING AND CEILING SPECIAL SYSTEMS PLAN										
E302	SECOND FLOOR SYSTEMS PLAN										
	l l										
E600	ELECTRICAL SCHEDULES										


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It is a violation of New York Education Law Article 145 Sec.7209, for any person, unless acting under the direction of a licensed architect, professional engineer, or land surveyor, to alter an item in any way. If an item bearing the seal of an architect, engineer, or land surveyor is altered; the altering architect, engineer, or land surveyor shall affix to the item their seal and notation "altered by" followed by their signature and date of such alteration, and a specific description of the alteration.

CATTARAUGUS COUNTY **DEPARTMENT OF**

LITTLE VALLEY, NEW YORK 14755

PROJECT LOCATION MAP:

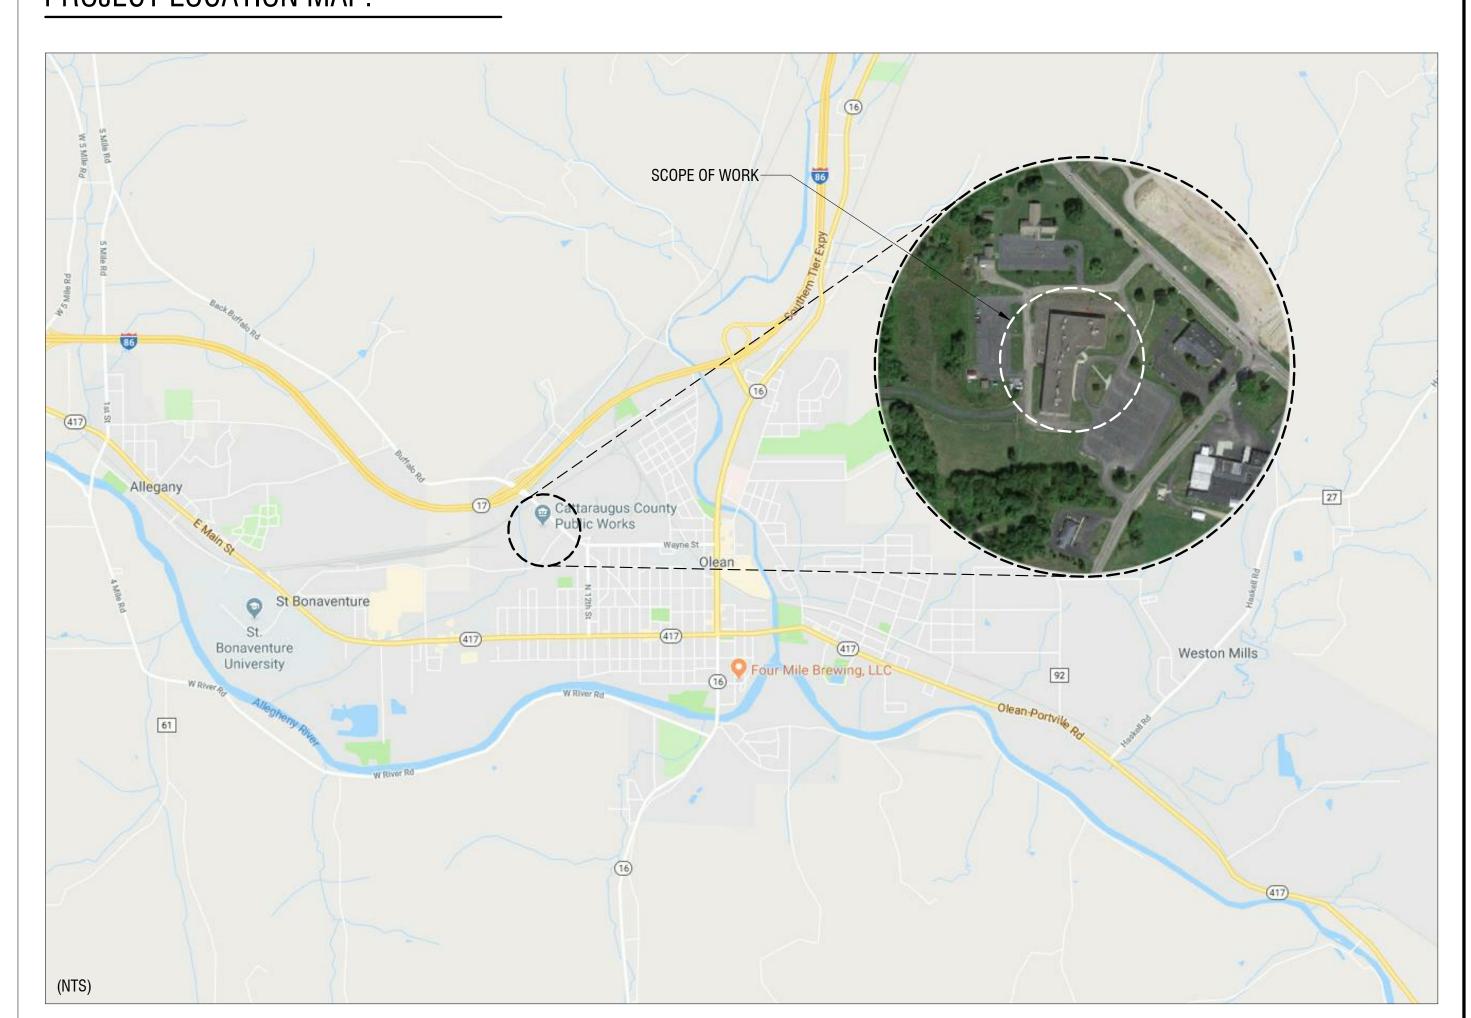

COUNTY COURT COURTROOM RENOVATIONS

1 LEO MOSS DRIVE OLEAN, NEW YORK 14760


PROJECT NUMBER: 2180593.01 DRAWN BY: REVIEWED BY: ISSUED FOR: BID MARCH 25, 2019

DRAWING NAME:

DRAWING INDEX AND **PROJECT INFORMATION &** LOCATION

DRAWING NUMBER:

G-001

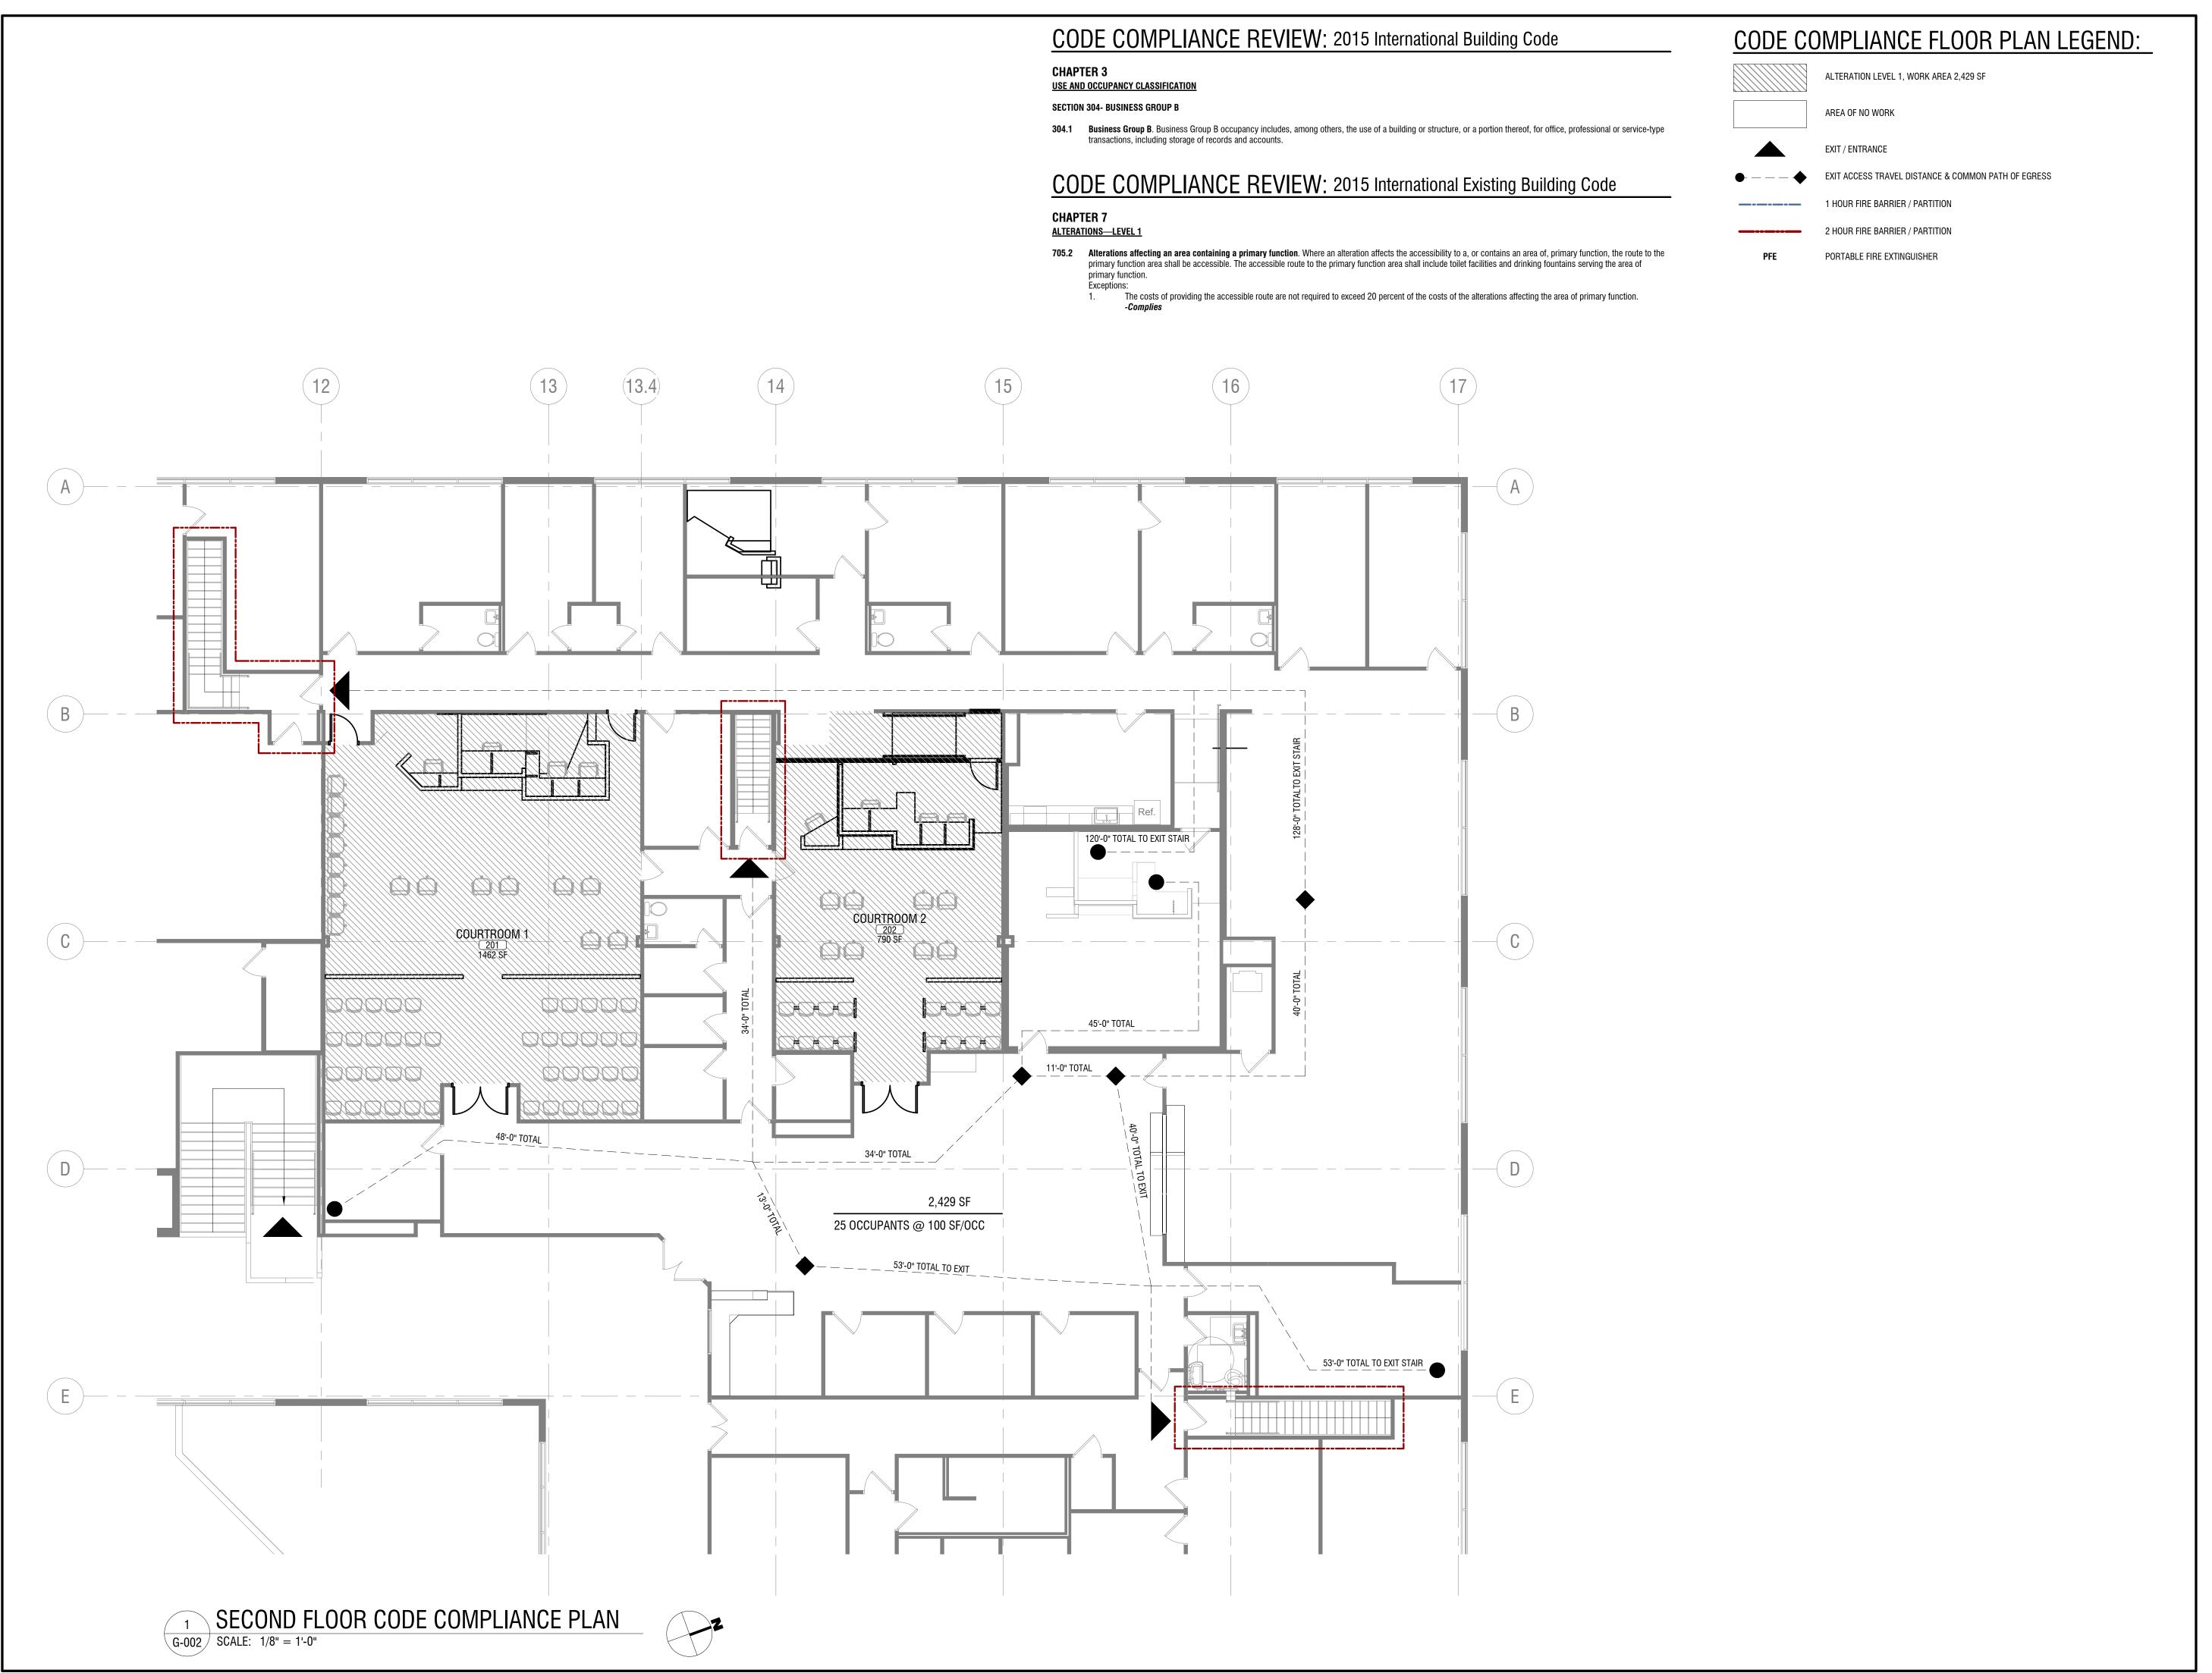

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CATTARAUGUS COUNTY DEPARTMENT OF PUBLIC WORKS

8810 ROUTE 242 LITTLE VALLEY, NEW YORK 14755

COUNTY COURT COURTROOM RENOVATIONS

1 LEO MOSS DRIVE OLEAN, NEW YORK 14760

PROJECT NUMBER:

2180593.01

DRAWN BY:
BMH
REVIEWED BY:
JMK

ISSUED FOR:
BID


MARCH 25, 2019

DRAWING NAME:

CODE COMPLIANCE AND LIFE SAFETY PLANS

DRAWING NUMBER:

G-002

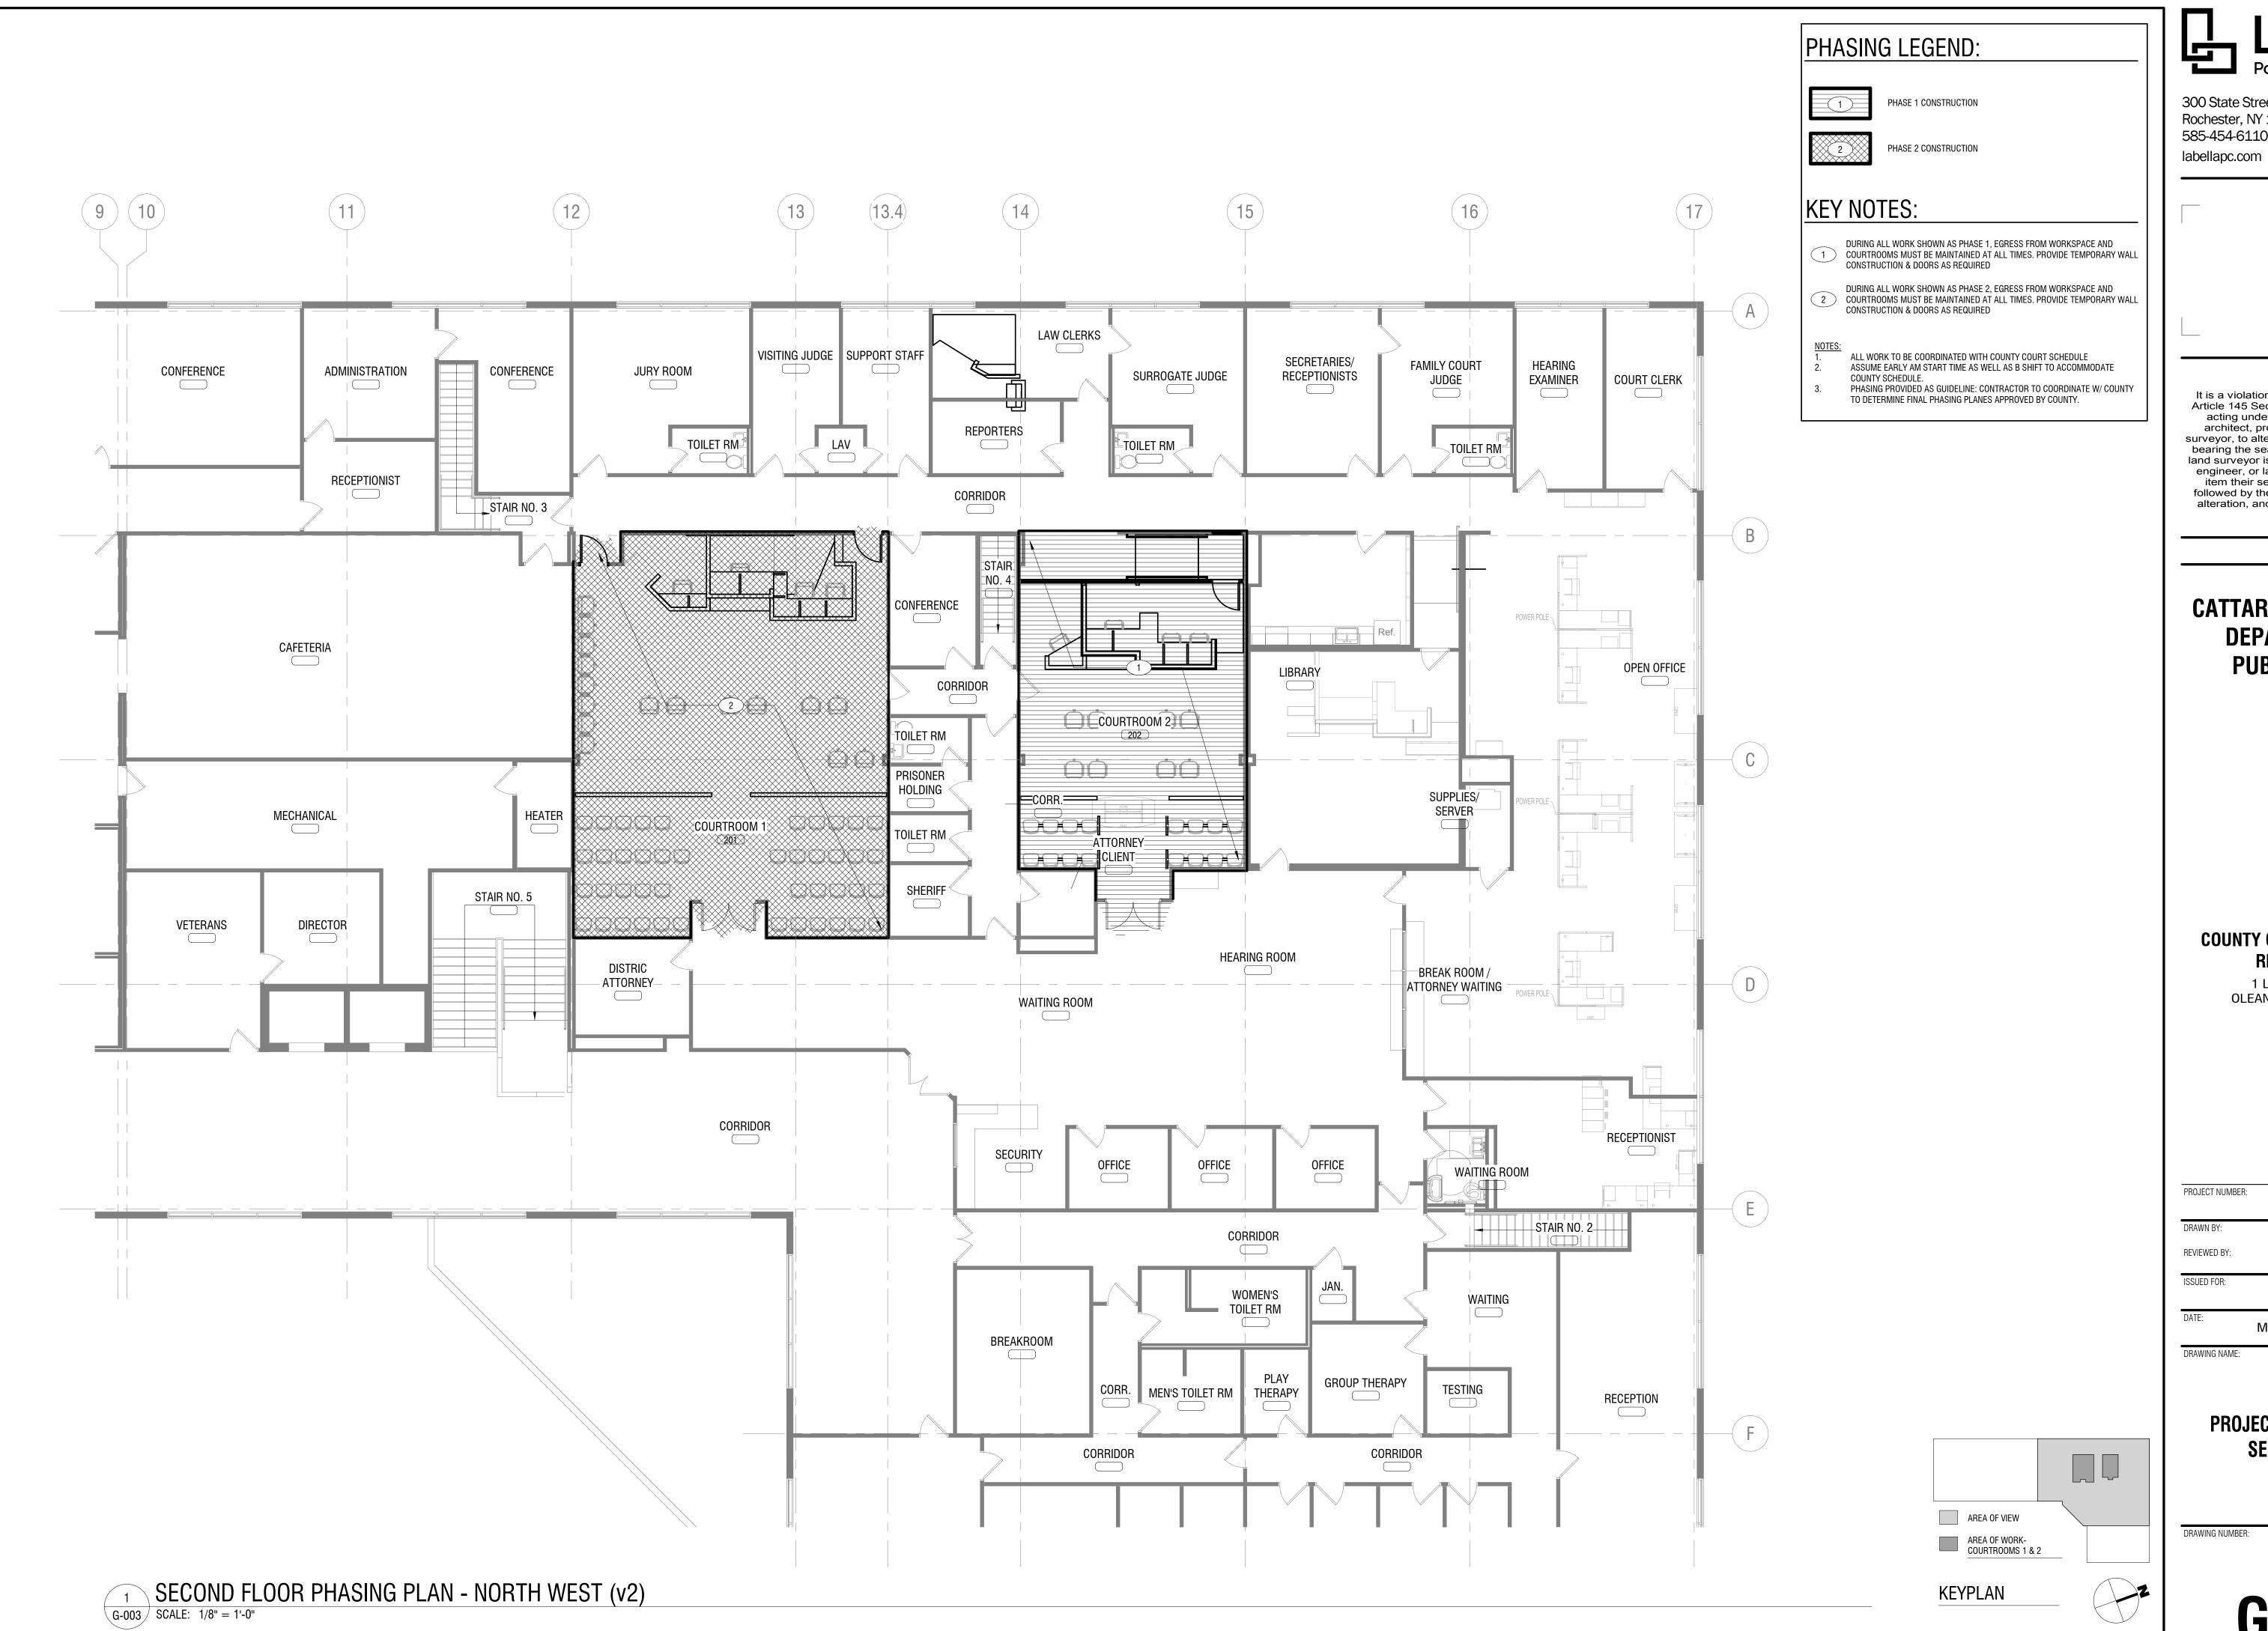



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CATTARAUGUS COUNTY DEPARTMENT OF PUBLIC WORKS

COUNTY COURT COURTROOM RENOVATIONS

1 LEO MOSS DRIVE OLEAN, NEW YORK 14760

PROJECT NUMBER: 2180593.01 DRAWN BY: REVIEWED BY: JMK ISSUED FOR: BID

MARCH 25, 2019

DRAWING NAME:

PROJECT PHASING PLAN-**SECOND FLOOR**

DRAWING NUMBER:

ARCHITECTURAL ABBREVIATIONS:

GA: @ GALV: Area GC: AB: Anchor Bolt ABV: Above ACC: Access
ACOUST: Acoustical GRTG: ACR: ACST: GVL: Acrylic GYP: Acoustic ACT: Acoustical Tile AD: Access Door ADH: Adhesive Adjust, Adjustable, Adjacent ADJ: AFF: Above Finished Floor AGGR: Aggregate ALT: HGT: Alternate ALUM: Aluminum ANOD: Anodized AP: Access Panel HR: APPROX: Approximate ATC: Acoustical Tile Ceiling BDRM: Bedroom BETW: Between IN: BF: INCL: Board Foot BIT: INFO: Bituminous BLDG: Building INSTL: BLKG: Blocking BOT: BPL: BRG: BRK: BRZ: BS: Bottom INT: Bearing Plate Bearing Brick Bronze Both Sides JAN: BSMT: Basement BUR: Built-up Roof C/C: LAB: Center to Center CAB: CAR: CAV: CCW: LAV: Cabinet Carpet LB: Cavity LBL: LINO: Linoleum Counter Clockwise CCTV: LNTL: Lintel Closed Circuit TV CEM: Cement CER: CF: Ceramic MAINT: Cubic Feet CHAM: CJ: MAN; Chamfer MAR: Control Joint CK: CL: MARB: MAS: Caulking Centerline CLG: CLKG: MAT: Ceiling Caulking MATL: CLR: Clear MAX: CLR OPG: Clear Opening MECH: Mechanical MEMB: Membrane CMT: Ceramic Mosaic Tile CMU: MFD: Concrete Masonry Unit COL: Column MFG: CONC: Concrete MFR: **CONSTR: Construction** CONT: Continuous MIKE: CONTR: Contractor MIN: COP: MIR: Copper CPR: CPT: MISC: Copper MK: Carpet CT: ML&P: Metal Lath & Plaster Ceramic Tile CW: Clockwise MLD: MLDG: MM: DEG: MMB: Degree DEMO: MO: Demolition DF: Drinking Fountain MOD: DIAG: DIA: MONO: Monolithic MOV: Movable Diameter DIAM: DIFF: MP: Diameter Diffuser MPS: DN: Down DWG: Drawing MR: Mop Receptor DWGS: Drawings MT: DWR: Drawer MTD: MTL: Each MTR: MUL: EB: Expansion Bolt EE: Each End MULL: Mullion Each Face MV: Mercury Vapor EIFS: Exterior Insulation and Finish System MWP: Maximum Working Pressure EJ: Expansion Joint MWK: EL: Elevation, Elevator ELEC: Electrical ELEV: Elevator, Elevation NAP: NAT: ENCL: Enclosure EPDM: Ethylene Propylene Diene Monomer EQ: NB: Egual EQUIP: Equipment EW: Each Way
EXG: Existing NEC: NEUT: Neutral EXH: NF: Near Face Exhaust EXIST: NFWH: Non-freeze Wall Hydrant Existing EXP: Exposed NI: NIC: Face Brick NK: NMT: Non-Metallic FD: Floor drain FDC: Fire Department Connection

Maintenance

Manual

Marble

Marble

Masonry

Material

Material

Maximum

Manufactured

Microphone

Miscellaneous

Minimum

Mirror

Mark

Molding

Millimeter

Module

Membrane

Masonry Opening

Metal Acoustal Panel

Metal Roof Deck

Mount, Mounted

Material, Metal

Mounted

Motor

Mullion

Millwork

Napkin

Natural

Nickel

Neck

NOM: Nominal

NTS: Not To Scale

Obscure

Obscure

On Center

Office

Overhead

OHD: Overhead Door

OPP H: Opposite Hand

OPNG: Opening OPP: Opposite

Outside Face

Outside Diameter

OFCI: Owner Furnished - Contractor Installed

OFOI: Owner Furnished - Owner Installed

NR:

OB:

OBS:

OC:

OF:

OFF:

OH:

Not In Contract

Noise Reduction NRC: Noise Reduction Coefficient

North, Nitrogen

"Nota Bene" Latin phrase for "Take Special Note"

Normally Closed, Noise Criteria

National Electrical Code

Number, Normally Open

Medium Pressure Steam

Manufacturer, Manufacturing

Manufacture, Manufacturer

Malleable Iron, Miles

P. LAM: Plastic Laminate Gauge, Gage Galvanized PAR: Parallel PBD: Particle Board General Contractor PERIM: Perimeter Glass PERP: Perpendicular GL BLK: Glass Block GRND: Ground Plate Grating PLBG: Plumbing PLYWD: Plywood Gravel Gypsum PLUMB: Plumbing GYP BD: Gypsum Board PR: Pair PREFAB: Prefabricated PRES: Pressure HDCP: Handicapped (better called "Accessible") PRESS: Pressure PRMLD: Premolded HDW: Hardware HDWD: Hardwood PRTN: Partition Height Pounds per square foot HM: Hollow Metal Pounds per square inch HORIZ: Horizontal PAINT PTD: Hour HWD: Hardwood PTN: Partition Inside Diameter QUAL: Quality Quarry Tile, Quart Inch QTY: Include Quantity Information Install Rubber Base INSUL: Insulation RCP: Reflected Ceiling Plan Interior INTERM: Intermediate REBAR: Reinforcing Bar REFL: Reflected, Janitor REFR: Refrigerate, Refrigerator REINF: Reinforcement, or Reinforce Janitor's Closet REQD: Required Joint RESIL: Resilient Roof RF: RGH: Rough Laboratory, Labor RGH OPNG: Rough Opening Lavatory RO: Rough Opening Pound (weight) Label

Painted, Paper Towel Dispenser PTD/R: Combination Paper Towel Dispenser/Receptacle Roof Drain, Round, Receptacle Distribution Panel Refer, Reference, Refrigerator

RT: Rubber Tile SALV: Salvage SCHED: Schedule Square Foot SHR: Shower Sheet SPEC: Specification, Specifications SPECS: Specifications Square Stainless Steel Sound Transmission Class STD: Standard STL: Steel STOR: Storage STRT: Straight STRUC: Structural STRUCT: Structural SUR: Surface SUSP: Suspended, Suspend T&B: Top and Bottom Tongue & Groove Towel Bar Trench Drain TERR: Terrazzo THK: Thick, Thickness THRU: Through Toilet Toilet paper Dispenser Toilet Paper Holder TYP: Typical Terrazzo UNFIN: Unfinished UNO: Unless Noted Otherwise UON: Unless Otherwise Noted UP: Unpainted UR: Urinal Vinyl Asbestos Tile Vinyl Base (Coved) Vinyl Composition Tile VERT: Vertical VEST: Vestibule

Verify In the Field

Vinyl Tile

VTR: Vent Through Roof

VWC: Vinyl Wall Covering

W/: With

W/0: Without

WD: Wood

WAINS: Wainscot

WC: Watercloset

GENERAL ARCHITECTURAL NOTES:

PRESSURE TREATED LUMBER OR PLYWOOD.

- 1. UNLESS OTHERWISE NOTED, ALL MASONRY DIMENSIONS ARE NOMINAL TO FACE OF MASONRY, ALL NON-MASONRY DIMENSIONING IS TO STUD WALLS AND ALL CONCRETE DIMENSIONING IS FACE TO FACE OF WALL.
- 2. FINISHED DOOR OPENINGS SHALL BE NOMINAL 4" FROM FINISHED CORNER OF ROOM EXCEPT WHERE DIMENSIONED
- 3. SEALANT AND BACKER ROD SHALL BE PROVIDED AT THE EXTERIOR PERIMETER OF ALL WINDOWS, DOOR FRAMES, LOUVERS OR OTHER ITEMS INSERTED IN AN EXTERIOR WALL.
- 4. SUSPENDING GRID CEILINGS SHALL BE ARRANGED SO THAT THE GRID IS SPACED EQUALLY FROM EACH MOST REMOTE WALL, IN EACH DIRECTION, WITH NO TILE LESS THAN 6" UNLESS OTHERWISE INDICATED.
- 5. WOOD USED FOR BLOCKING OR OTHER PURPOSES ON OR ABOVE THE ROOF DECK, WITHIN 2'-0' OF GRADE, AGAINST CMU OR CONCRETE AND OTHER LOCATIONS OUTSIDE THE BUILDING ENVELOPE WHERE EXPOSED TO THE WEATHER SHALL BE
- 6. CMU WALLS SHALL RECEIVE AS A MINIMUM, GALVANIZED HORIZONTAL REINFORCEMENT 16" O.C. VERTICALLY (EVERY OTHER COURSE) UNLESS OTHERWISE NOTED.
- WHEN MATERIALS AND/OR FINISHES ARE FOUND TO BE ABSENT, OR WHEN EXISTING CONSTRUCTION IS REMOVED, DISTURBED, DAMAGED, REPLACED OR RENOVATED IN ANY WAY; CONTRACTOR SHALL PROVIDE PATCHING, PAINTING AND MATERIALS OF SAME TYPE AND QUALITY AS TO MATCH ADJACENT EXISTING SURFACES UNLESS OTHERWISE NOTED, AT NO ADDITIONAL COST TO THE OWNER.
- 8. INSTALL WORK AS INDICATED AND VERIFY EXACT LOCATION AND ELEVATIONS ON JOB; DO NOT DIRECTLY SCALE PLANS. CONTACT ARCHITECT IF ADDITIONAL DIMENSIONS ARE REQUIRED.
- 9. ALL DETAILS ARE SUBJECT TO CHANGE DUE TO EXISTING UNKNOWN FIELD CONDITIONS, CONTRACTOR MUST NOTIFY THE ARCHITECT AND OWNER OF SUCH ENCOUNTERED CONDITIONS IN WRITING AND RECEIVE APPROVAL PRIOR TO MODIFICATION OF DETAILS.
- 10. ALL AREAS DISTURBED DURING DEMOLITION OR CONSTRUCTION, ARE TO RECEIVE PRIME AND PAINT TO MATCH UNLESS OTHERWISE INDICATED. WALLS THAT HAVE AREAS DISTURBED, OR NEW WALLS, ARE TO HAVE PRIMER AND PAINT PROVIDED ON THE ENTIRE WALL SURFACE TO AN INTERIOR OR EXTERIOR CORNER OF THE SAME WALL.
- 11. THESE DOCUMENTS DO NOT PURPORT TO SHOW ALL ITEMS AND PROCEDURES REQUIRED FOR A COMPLETE INSTALLATION AND COMPLETION. THE INTENT IS TO INDICATE THE GENERAL SCOPE OF THE PROJECT IN TERMS OF THE GENERAL ARCHITECTURAL DESIGN CONCEPT, THE LOCATION/DIMENSIONS OF THE CONSTRUCTION AND MAJOR ARCHITECTURAL ELEMENTS OF CONSTRUCTION.

LINE TYPES


VISIBLE ITEMS — — — — — CENTER LINE OR COLUMN GRID — — — — — HIDDEN OR NOT IN CONTRACT BREAK LINE ---- OVERHEAD

WALL/ PARTITION DESIGNATIONS

BRICK FACE C.M.U. WALL / PARTITION - SEE PARTITION TYPES METAL STUD PARTITION - SEE PARTITION TYPES EXISTING WALL CONSTRUCTION

MATERIAL SYMBOLS:

CONCRETE MASONRY UNITS (CMU) WOOD (FINISHED) RIGID INSULATION WOOD (ROUGH) CONCRETE BATT. OR LOOSE INSULATION WOOD (BLOCKING) CEMENT, SAND, GROUT, PLASTER, PARTICLE BOARD OR GYPSUM WALL BOARD

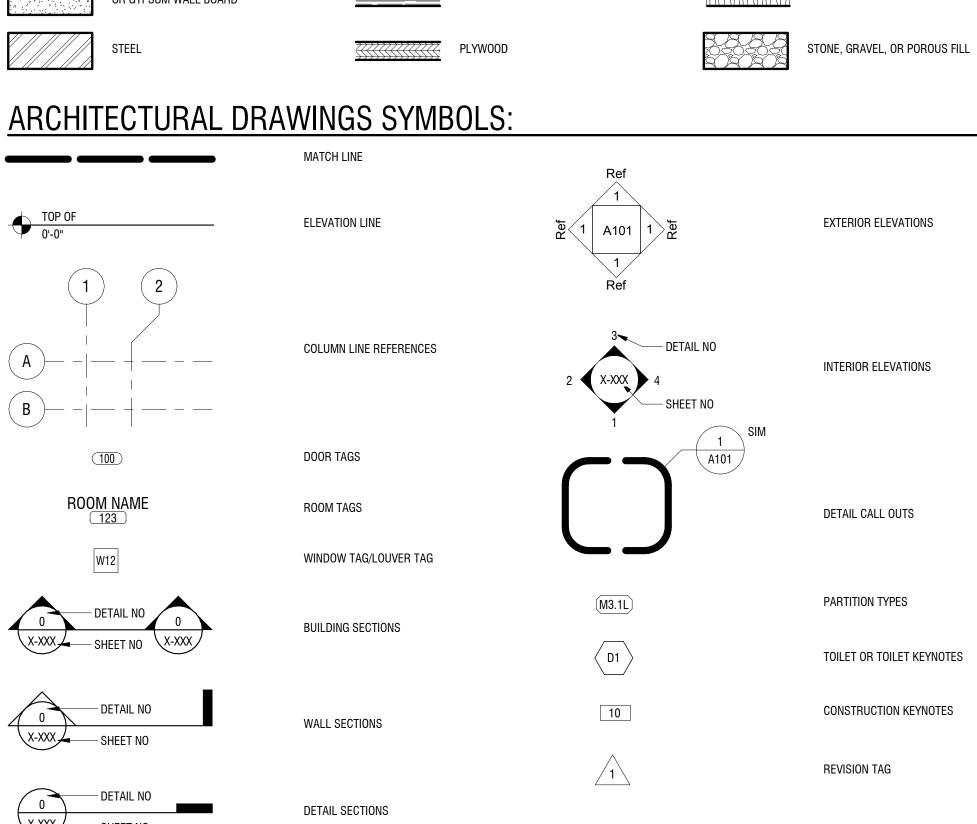

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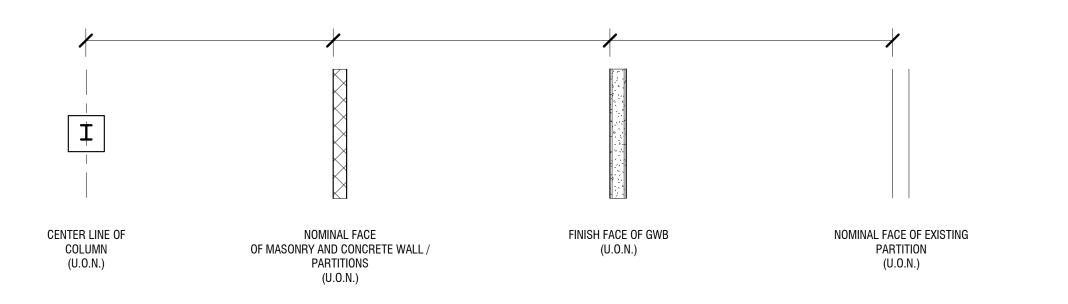
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> **ARCHITECTURAL INFORMATION**

DRAWING NUMBER:

DRAWING NAME:

TYPICAL PLAN DIMENSIONING:



FDN:

FEC:

FFE:

FGL:

FHC:

FIN:

FIXT:

FLR:

F0:

FOF:

FOS:

FP:

FRT:

FT:

FDTN:

Foundation

Foundation

Fiberglass

Fixture

Floor

Floor

Fire Extinguisher

Fire Extinguisher Cabinet

FF&E: Fixtures, Furnishings & Equipment

Finished Floor Elevation

Finished Floor Line

Fire Hose Cabinet

Finished Opening

Face of Finish


Face of Studs


Fire Retardant

Fireproof

Foot, Feet, FTG: Footing, Fitting FURN: Furnish, Furniture FURR: Furring

Finish, finished

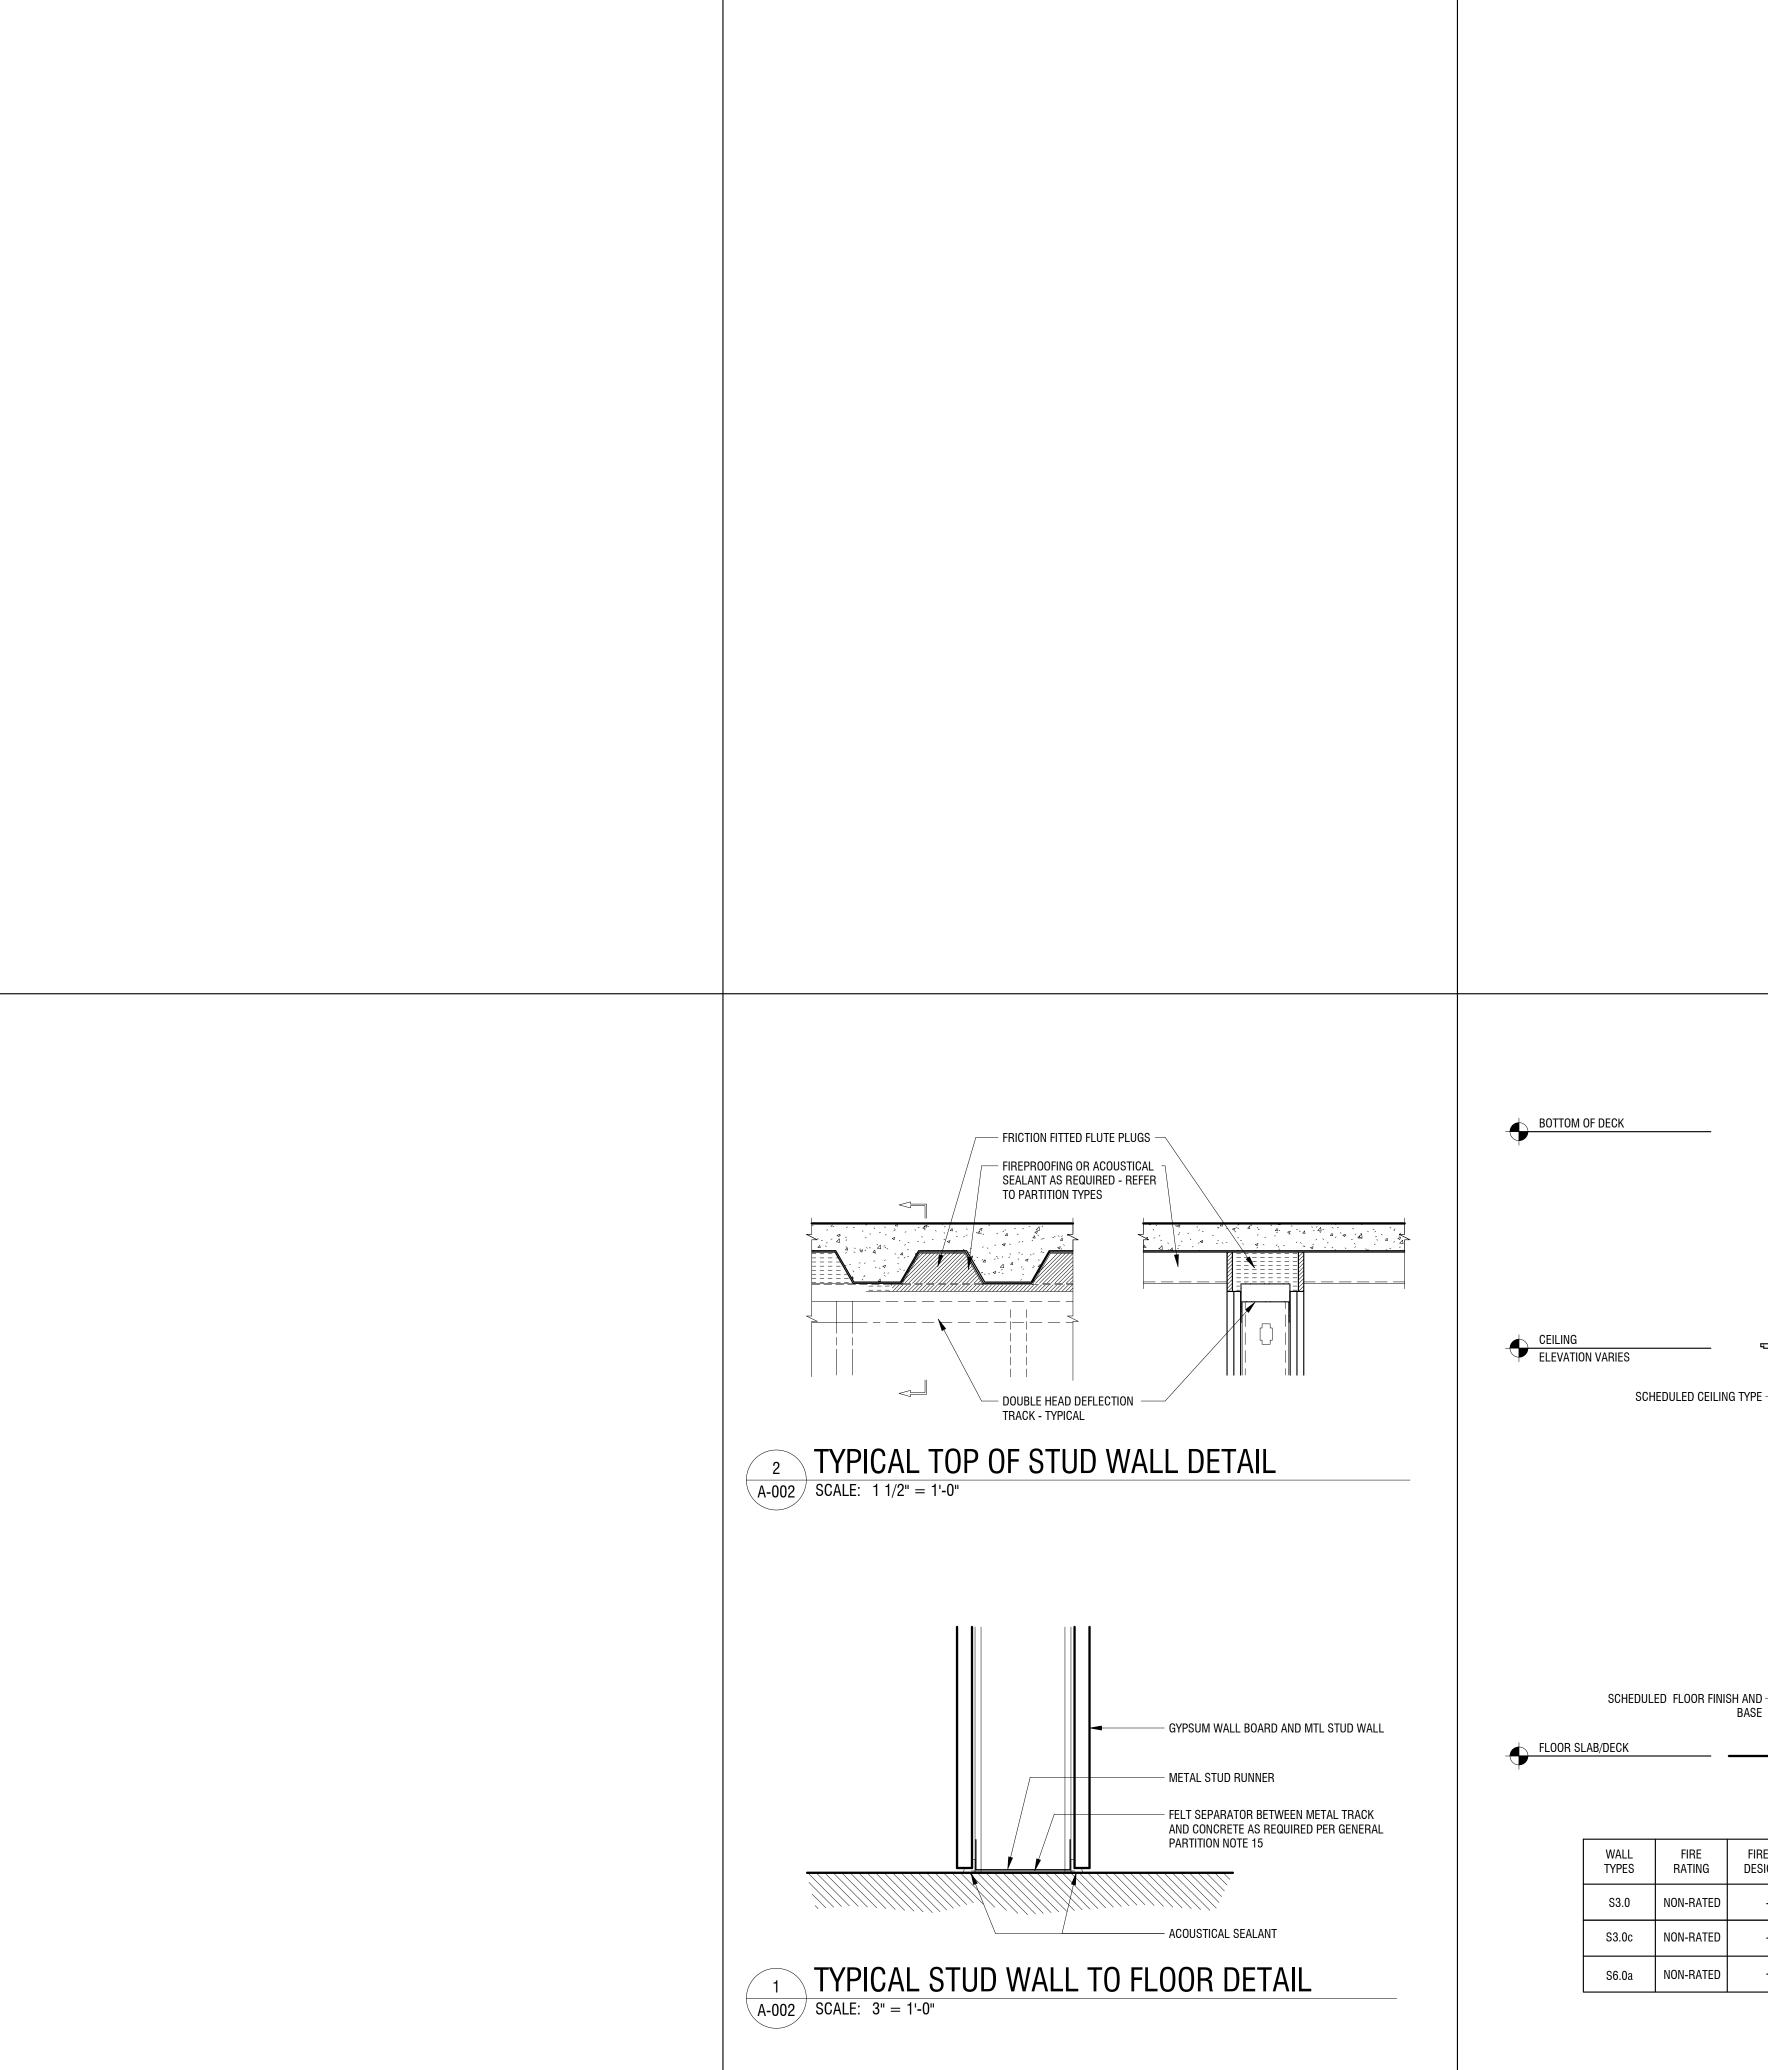

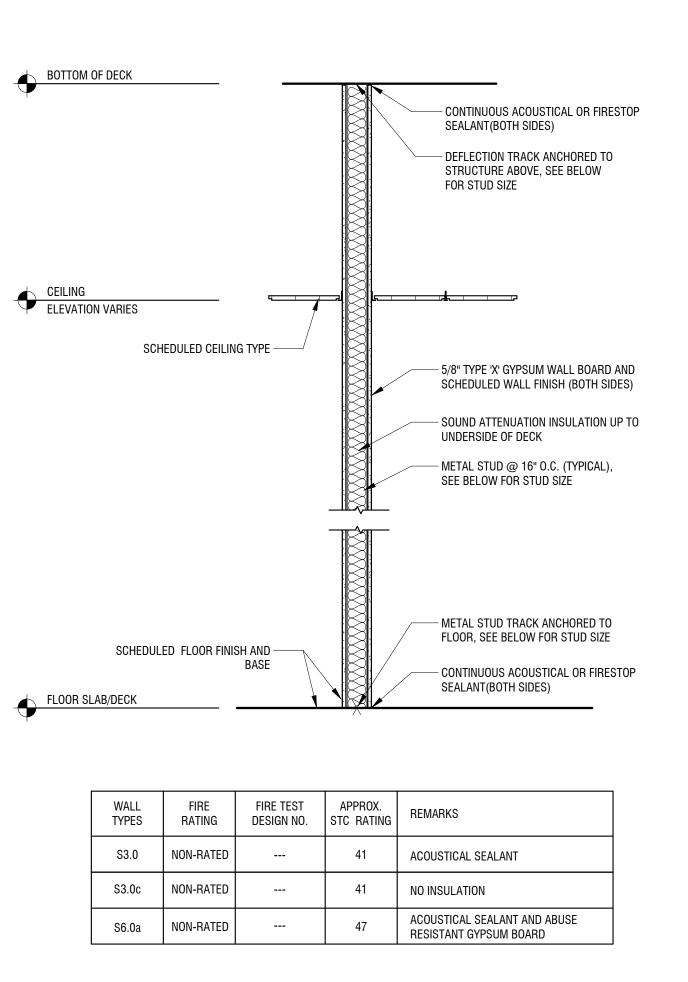

PARTITION TYPE LEGEND:



MATERIAL DESIGNATION

- S METAL STUDS @ 16" O.C., x REFER TO SPEC'S FOR GA./MIL THICKNESS
- F METAL STUDS @ 16" O.C./ FURRING CHANNELS / HAT CHANNELS/ Z- FURRING CHANNELS x REFER TO SPECS FOR GA./MIL THICKNESS
- T TEMPORARY BARRIERS. METAL STUDS x REFER TO SPEC'S FOR GA./MIL THICKNESS

SIZE SUFFIX

- 3 5/8" METAL STUDS
- 6 6" CONCRETE MASONRY UNIT (CMU) OR 6" METAL STUDS
- 9 (2) 3 5/8" METAL STUDS w/ 1/2" AIR SPACE OR SOUND BOARD

RATING SUFFIX

- 0 NON-RATED CMU OR METAL STUD PARTITION
- 1 HR RATED CMU OR METAL STUD PARTITION (PER UL DESIGN NO.)
- 2 HR RATED CMU OR METAL STUD PARTITION (PER UL DESIGN NO.)

ACCESSORIES SUFFIX

a GYPSUM WALL BOARD TO 8" ABOVE CEILING ON BOTH SIDES

GENERAL PARTITION NOTES

- 1. ALL PARTITIONS EXTEND FROM CONCRETE FLOOR TO METAL DECK ABOVE, UNLESS OTHERWISE INDICATED.
- 2. FILL FLUTES IN METAL DECK ABOVE PARTITION WITH FIRE SAFING INSULATION AND FIRE STOP ENTIRE PERIMETER AT RATED PARTITIONS, AND EXTERIOR WALLS WITH A UL LISTED JOINT SYSTEM FIRESTOP ASSEMBLY.
- PROVIDE DEFLECTION TRACKS AT METAL STUD PARTITIONS THAT TERMINATE AT THE UNDERSIDE OF STRUCTURE/ METAL DECK ABOVE.
- 4. ALL NON-BEARING PARTITIONS SHALL BE CONSTRUCTED TO LIMIT DEFLECTION TO L/362 OF THE SPAN WITH UNIFORM 5 PSF HORIZONTAL LOADING.
- 5. ALL PENETRATIONS IN FIRE RATED PARTITIONS TO BE FIRE STOPPED AND SEALED.
- 6. ALL PARTITIONS SHALL BE SEALED TO PREVENT PASSAGE OF SMOKE.
- 7. CONTRACTOR TO REFER TO CODE/LIFE SAFETY DRAWINGS FOR RATED PARTITIONS.
- 8. PROVIDE MOISTURE RESISTANT GYPSUM BOARD AT ALL WET LOCATIONS AND AREAS TO RECEIVE WALL TILE, REFER TO SPECIFICATION IN PROJECT MANUAL.
- 9. REFER TO STRUCTURAL DRAWINGS FOR MASONRY WALL REINFORCEMENT.
- 10. PROVIDE DOUBLE FRAMING AT ALL DOOR, WINDOW AND CASED OPENINGS JAMBS AND HEAD CONDITIONS.
- 11. FOR ALL PARTITIONS, COORDINATE AND PROVIDE BLOCKING FOR ALL BUT NOT LIMITED TO WALL MOUNTED ARCHITECTURAL WOODWORK, FINISH CARPENTRY, TOILET PARTITIONS AND ACCESSORIES, EQUIPMENT, HANDRAILS, HARDWARE AND SIMILAR MOUNTED ITEMS.
- 12. ALL CORRIDOR WALLS TO HAVE ABUSE RESISTANT GYPSUM ON CORRIDOR SIDE.
- 13. ALL KNEE WALLS DO NOT REQUIRE INSULATION.
- 14. ALL ACOUSTICALLY RATED PARTITIONS SHALL HAVE BACK BOXES STAGGERED AT A MINIMUM OF 4'-0" O.C. OR BE PROVIDED WITH ACOUSTICAL PUTTY PADS.
- 15. PROVIDE FELT SEPERATOR BETWEEN METAL TRACK AND CONCRETE AT ALL ACOUSTICALLY RATED PARTITIONS.



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BID

DATE:


MARCH 25, 2019

DRAWING NAME:

PARTITION TYPES & DETAILS

DRAWING NUMBER:

A-002

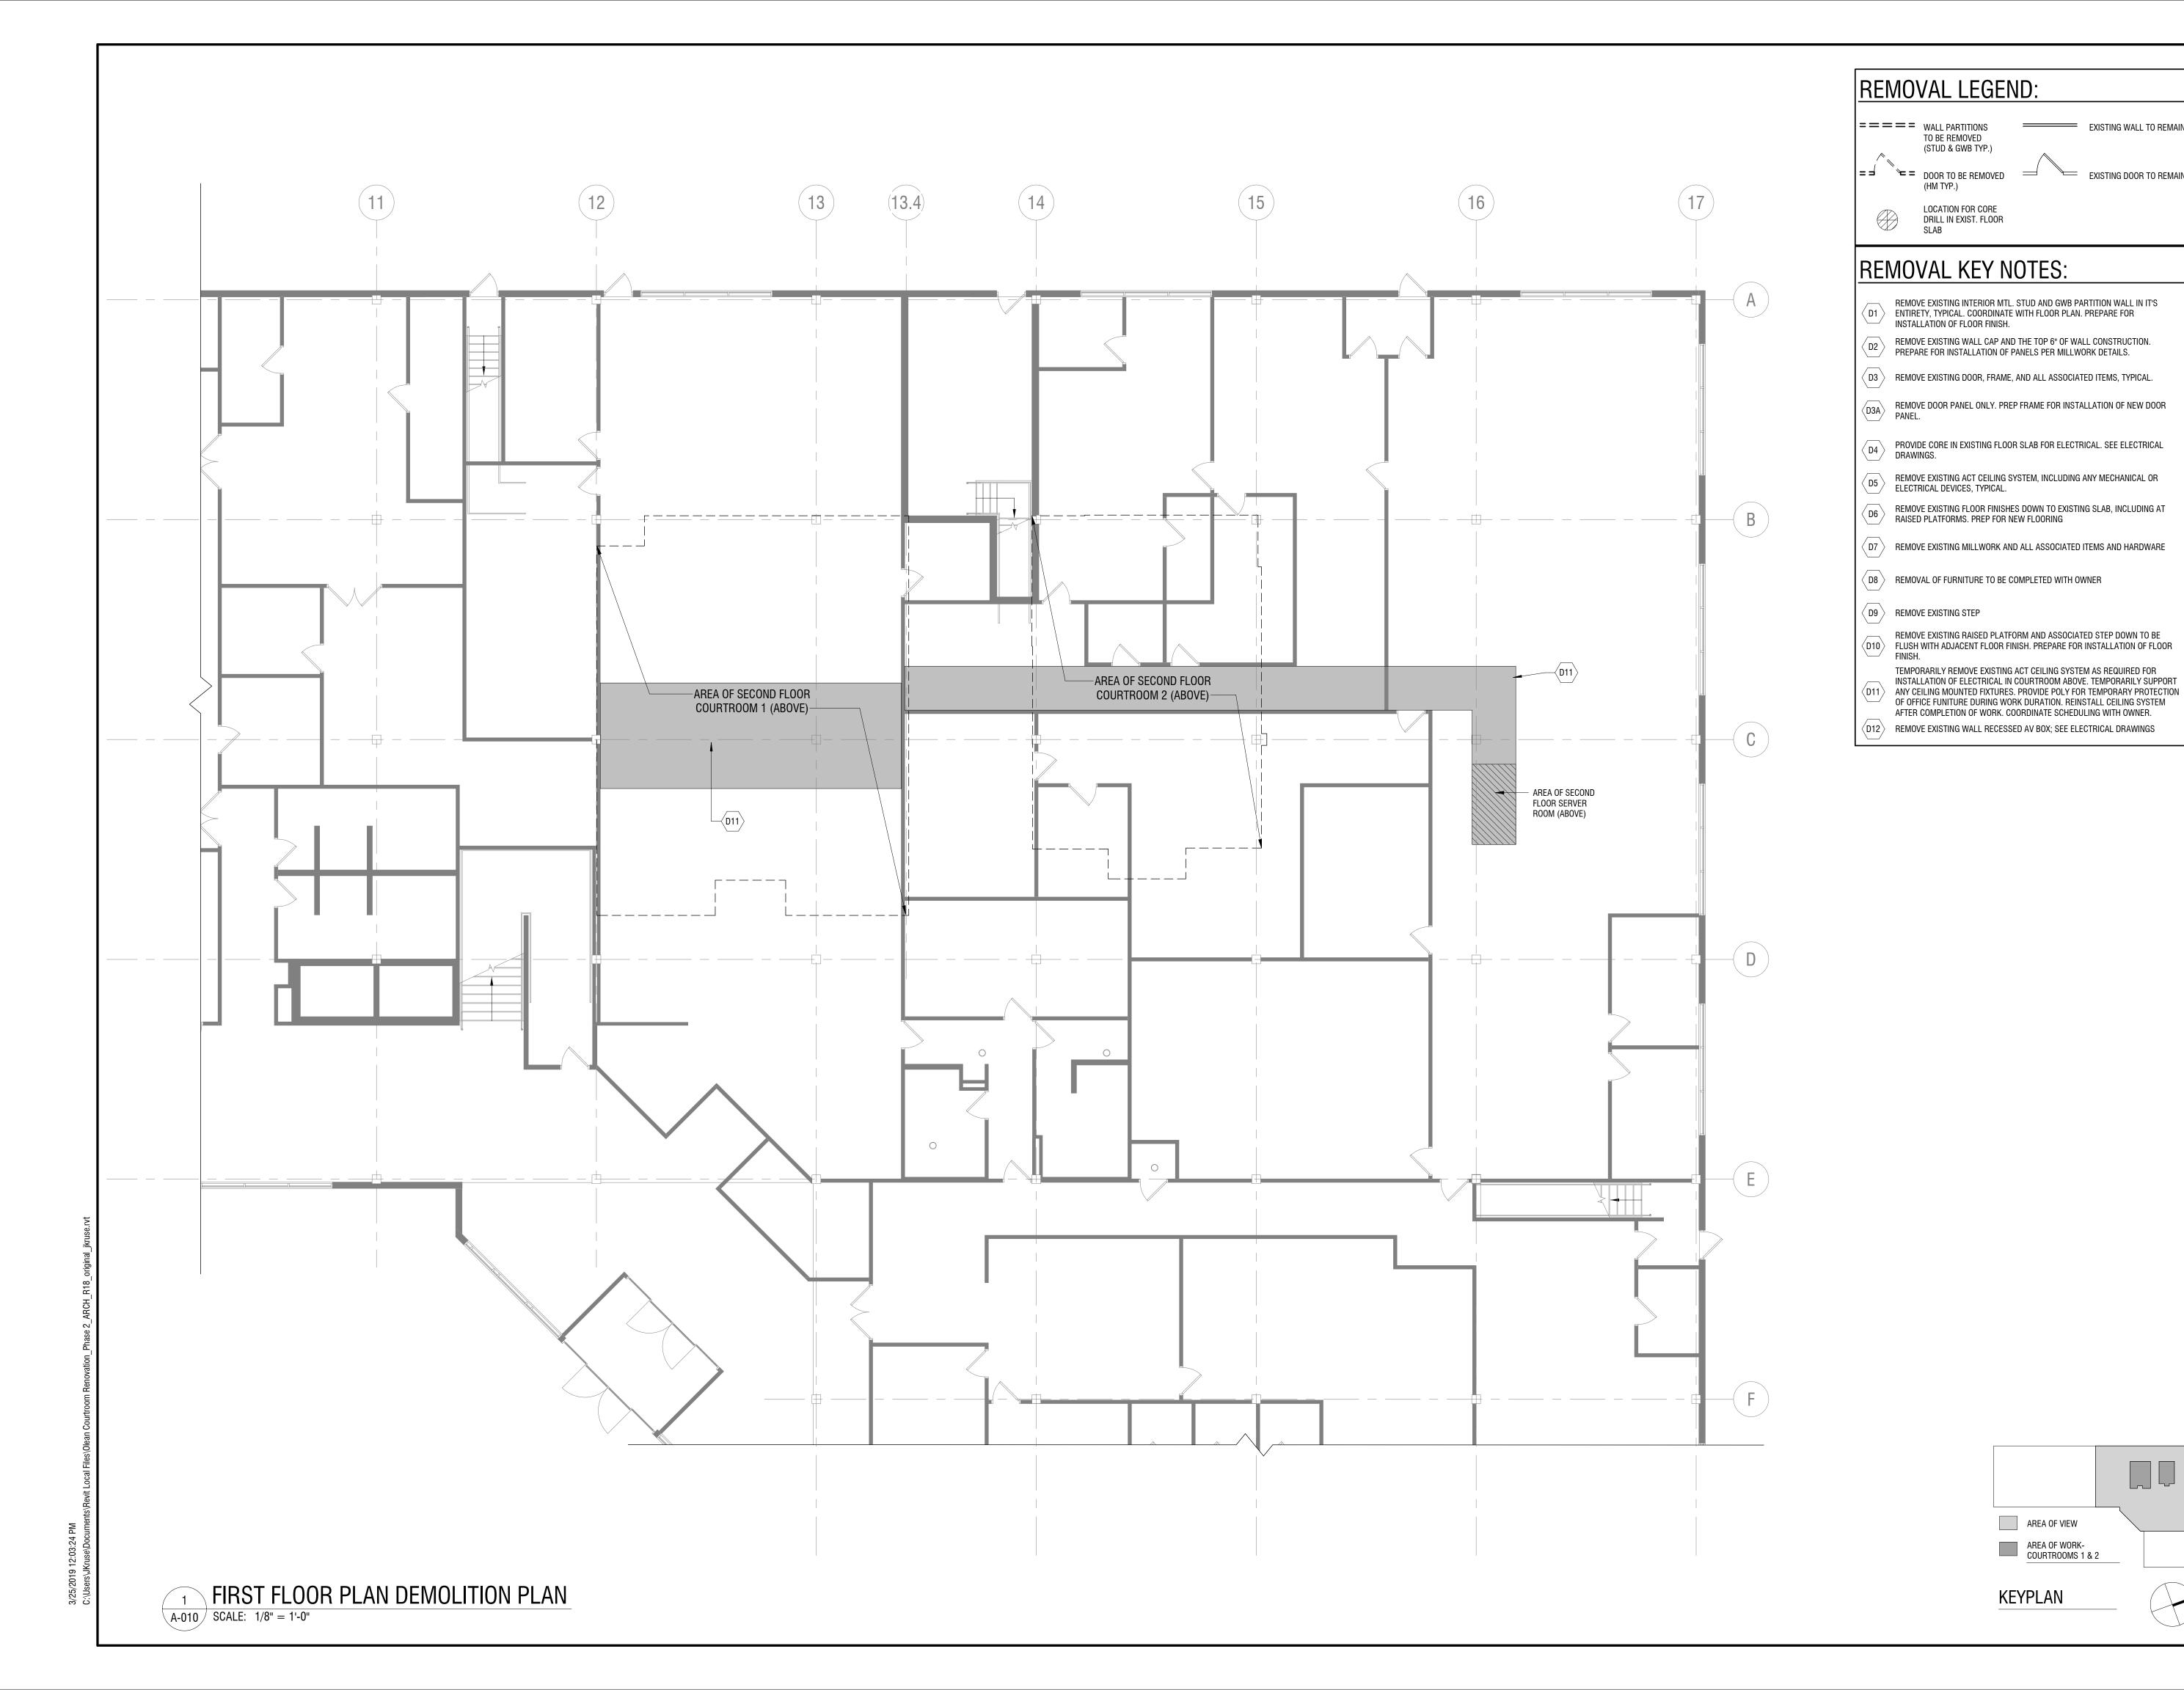



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EXISTING WALL TO REMAIN

EXISTING DOOR TO REMAIN

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alteration.

CATTARAUGUS COUNTY DEPARTMENT OF PUBLIC WORKS

COUNTY COURT COURTROOM RENOVATIONS

1 LEO MOSS DRIVE OLEAN, NEW YORK 14760

PROJECT NUMBER: 2180593.01 DRAWN BY: REVIEWED BY: ISSUED FOR: BID DATE: MARCH 25, 2019

DRAWING NAME:

FIRST FLOOR DEMOLITION **PLAN**


DRAWING NUMBER:

AREA OF VIEW

KEYPLAN

AREA OF WORK-COURTROOMS 1 & 2



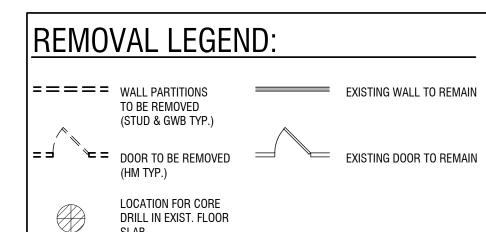

REMOVAL KEY NOTES:

- REMOVE EXISTING INTERIOR MTL. STUD AND GWB PARTITION WALL IN IT'S ENTIRETY, TYPICAL. COORDINATE WITH FLOOR PLAN. PREPARE FOR INSTALLATION OF FLOOR FINISH.
- REMOVE EXISTING WALL CAP AND THE TOP 6" OF WALL CONSTRUCTION. PREPARE FOR INSTALLATION OF PANELS PER MILLWORK DETAILS.
- \langle D3 \rangle remove existing door, frame, and all associated items, typical.
- REMOVE DOOR PANEL ONLY. PREP FRAME FOR INSTALLATION OF NEW DOOR
- PROVIDE CORE IN EXISTING FLOOR SLAB FOR ELECTRICAL. SEE ELECTRICAL DRAWINGS.
- REMOVE EXISTING ACT CEILING SYSTEM, INCLUDING ANY MECHANICAL OR ELECTRICAL DEVICES, TYPICAL.
- REMOVE EXISTING FLOOR FINISHES DOWN TO EXISTING SLAB, INCLUDING AT RAISED PLATFORMS. PREP FOR NEW FLOORING
- \langle D7 angle Remove existing millwork and all associated items and hardware
- D8 REMOVAL OF FURNITURE TO BE COMPLETED WITH OWNER
- ⟨ D9 ⟩ REMOVE EXISTING STEP
- REMOVE EXISTING RAISED PLATFORM AND ASSOCIATED STEP DOWN TO BE ⟨D10⟩ FLUSH WITH ADJACENT FLOOR FINISH. PREPARE FOR INSTALLATION OF FLOOR
- TEMPORARILY REMOVE EXISTING ACT CEILING SYSTEM AS REQUIRED FOR INSTALLATION OF ELECTRICAL IN COURTROOM ABOVE. TEMPORARILY SUPPORT ANY CEILING MOUNTED FIXTURES. PROVIDE POLY FOR TEMPORARY PROTECTION OF OFFICE FUNITURE DURING WORK DURATION. REINSTALL CEILING SYSTEM AFTER COMPLETION OF WORK. COORDINATE SCHEDULING WITH OWNER.

AREA OF VIEW

KEYPLAN

AREA OF WORK-COURTROOMS 1 & 2

(D12) REMOVE EXISTING WALL RECESSED AV BOX; SEE ELECTRICAL DRAWINGS



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CATTARAUGUS COUNTY DEPARTMENT OF PUBLIC WORKS

8810 ROUTE 242 LITTLE VALLEY, NEW YORK 14755

COUNTY COURT COURTROOM RENOVATIONS

1 LEO MOSS DRIVE OLEAN, NEW YORK 14760

PROJECT NUMBER: 2180593.01 DRAWN BY: REVIEWED BY: JMK ISSUED FOR: BID DATE:

DRAWING NAME:

SECOND FLOOR DEMOLITION PLAN

MARCH 25, 2019

DRAWING NUMBER:

A-012

A-012 SCALE: 1/8" = 1'-0"





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CATTARAUGUS COUNTY DEPARTMENT OF PUBLIC WORKS

8810 ROUTE 242 LITTLE VALLEY, NEW YORK 14755

COUNTY COURT COURTROOM RENOVATIONS

1 LEO MOSS DRIVE OLEAN, NEW YORK 14760

PROJECT NUMBER:

2180593.01

DRAWN BY:

KC

REVIEWED BY:

JMK

ISSUED FOR:

BID

DATE:

MARCH 25, 2019

DRAWING NAME:

SECOND FLOOR PLAN

DRAWING NUMBER:

AREA OF VIEW

KEYPLAN

AREA OF WORK-COURTROOMS 1 & 2


A-101




GENERAL CEILING NOTES

- 1. REFER TO SPECIFICATION SECTION 09 00 00 "COLOR AND FINISH LEGEND" FOR DETAILED FINISH INFORMATION.
- 2. PROVIDE ACT1 IN ALL LOCATIONS WHERE ACOUSTICAL CEILING TILE IS SHOWN UNLESS NOTED OTHERWISE.
- 3. ALL GWB CEILINGS AND SOFFITS TO BE PAINTED PT3, UNLESS NOTED OTHERWISE. PAINT ALL SIDES OF SOFFITS THE INDICATED

CEILING TYPE INDICATIONS

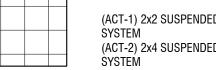


(ACT-1) 2x2 SUSPENDED ACOUSTICAL PANEL CEILING (ACT-2) 2x4 SUSPENDED ACOUSTICAL PANEL CEILING

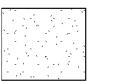

(GYP-1) SUSPENDED GYPSUM BOARD CEILING SYSTEM / GYPSUM BOARD SOFFIT



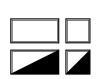

LUMINARIES - (REFER TO ELECTRICAL DRAWINGS FOR TYPE)



HVAC SUPPLY



SINGLE FACE EXIT SIGN

HVAC RETURN

SECURITY CAMERA - SEE ELECTRICAL SPEAKER - SEE ELECTRICAL

EXISTING SPRINKLER TO REMAIN - MODIFY HEAD LOCATION AS SHOWN ON FP DRAWINGS

AREA OF VIEW

KEYPLAN

AREA OF WORK-COURTROOMS 1 & 2



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8810 ROUTE 242 LITTLE VALLEY, NEW YORK 14755

COUNTY COURT COURTROOM RENOVATIONS

1 LEO MOSS DRIVE OLEAN, NEW YORK 14760

PROJECT NUMBER: 2180593.01 DRAWN BY: REVIEWED BY: JMK ISSUED FOR: BID DATE:


MARCH 25, 2019

DRAWING NAME:

SECOND FLOOR REFLECTED CEILING PLAN

DRAWING NUMBER:

A-111 SCALE: 1/8" = 1'-0"

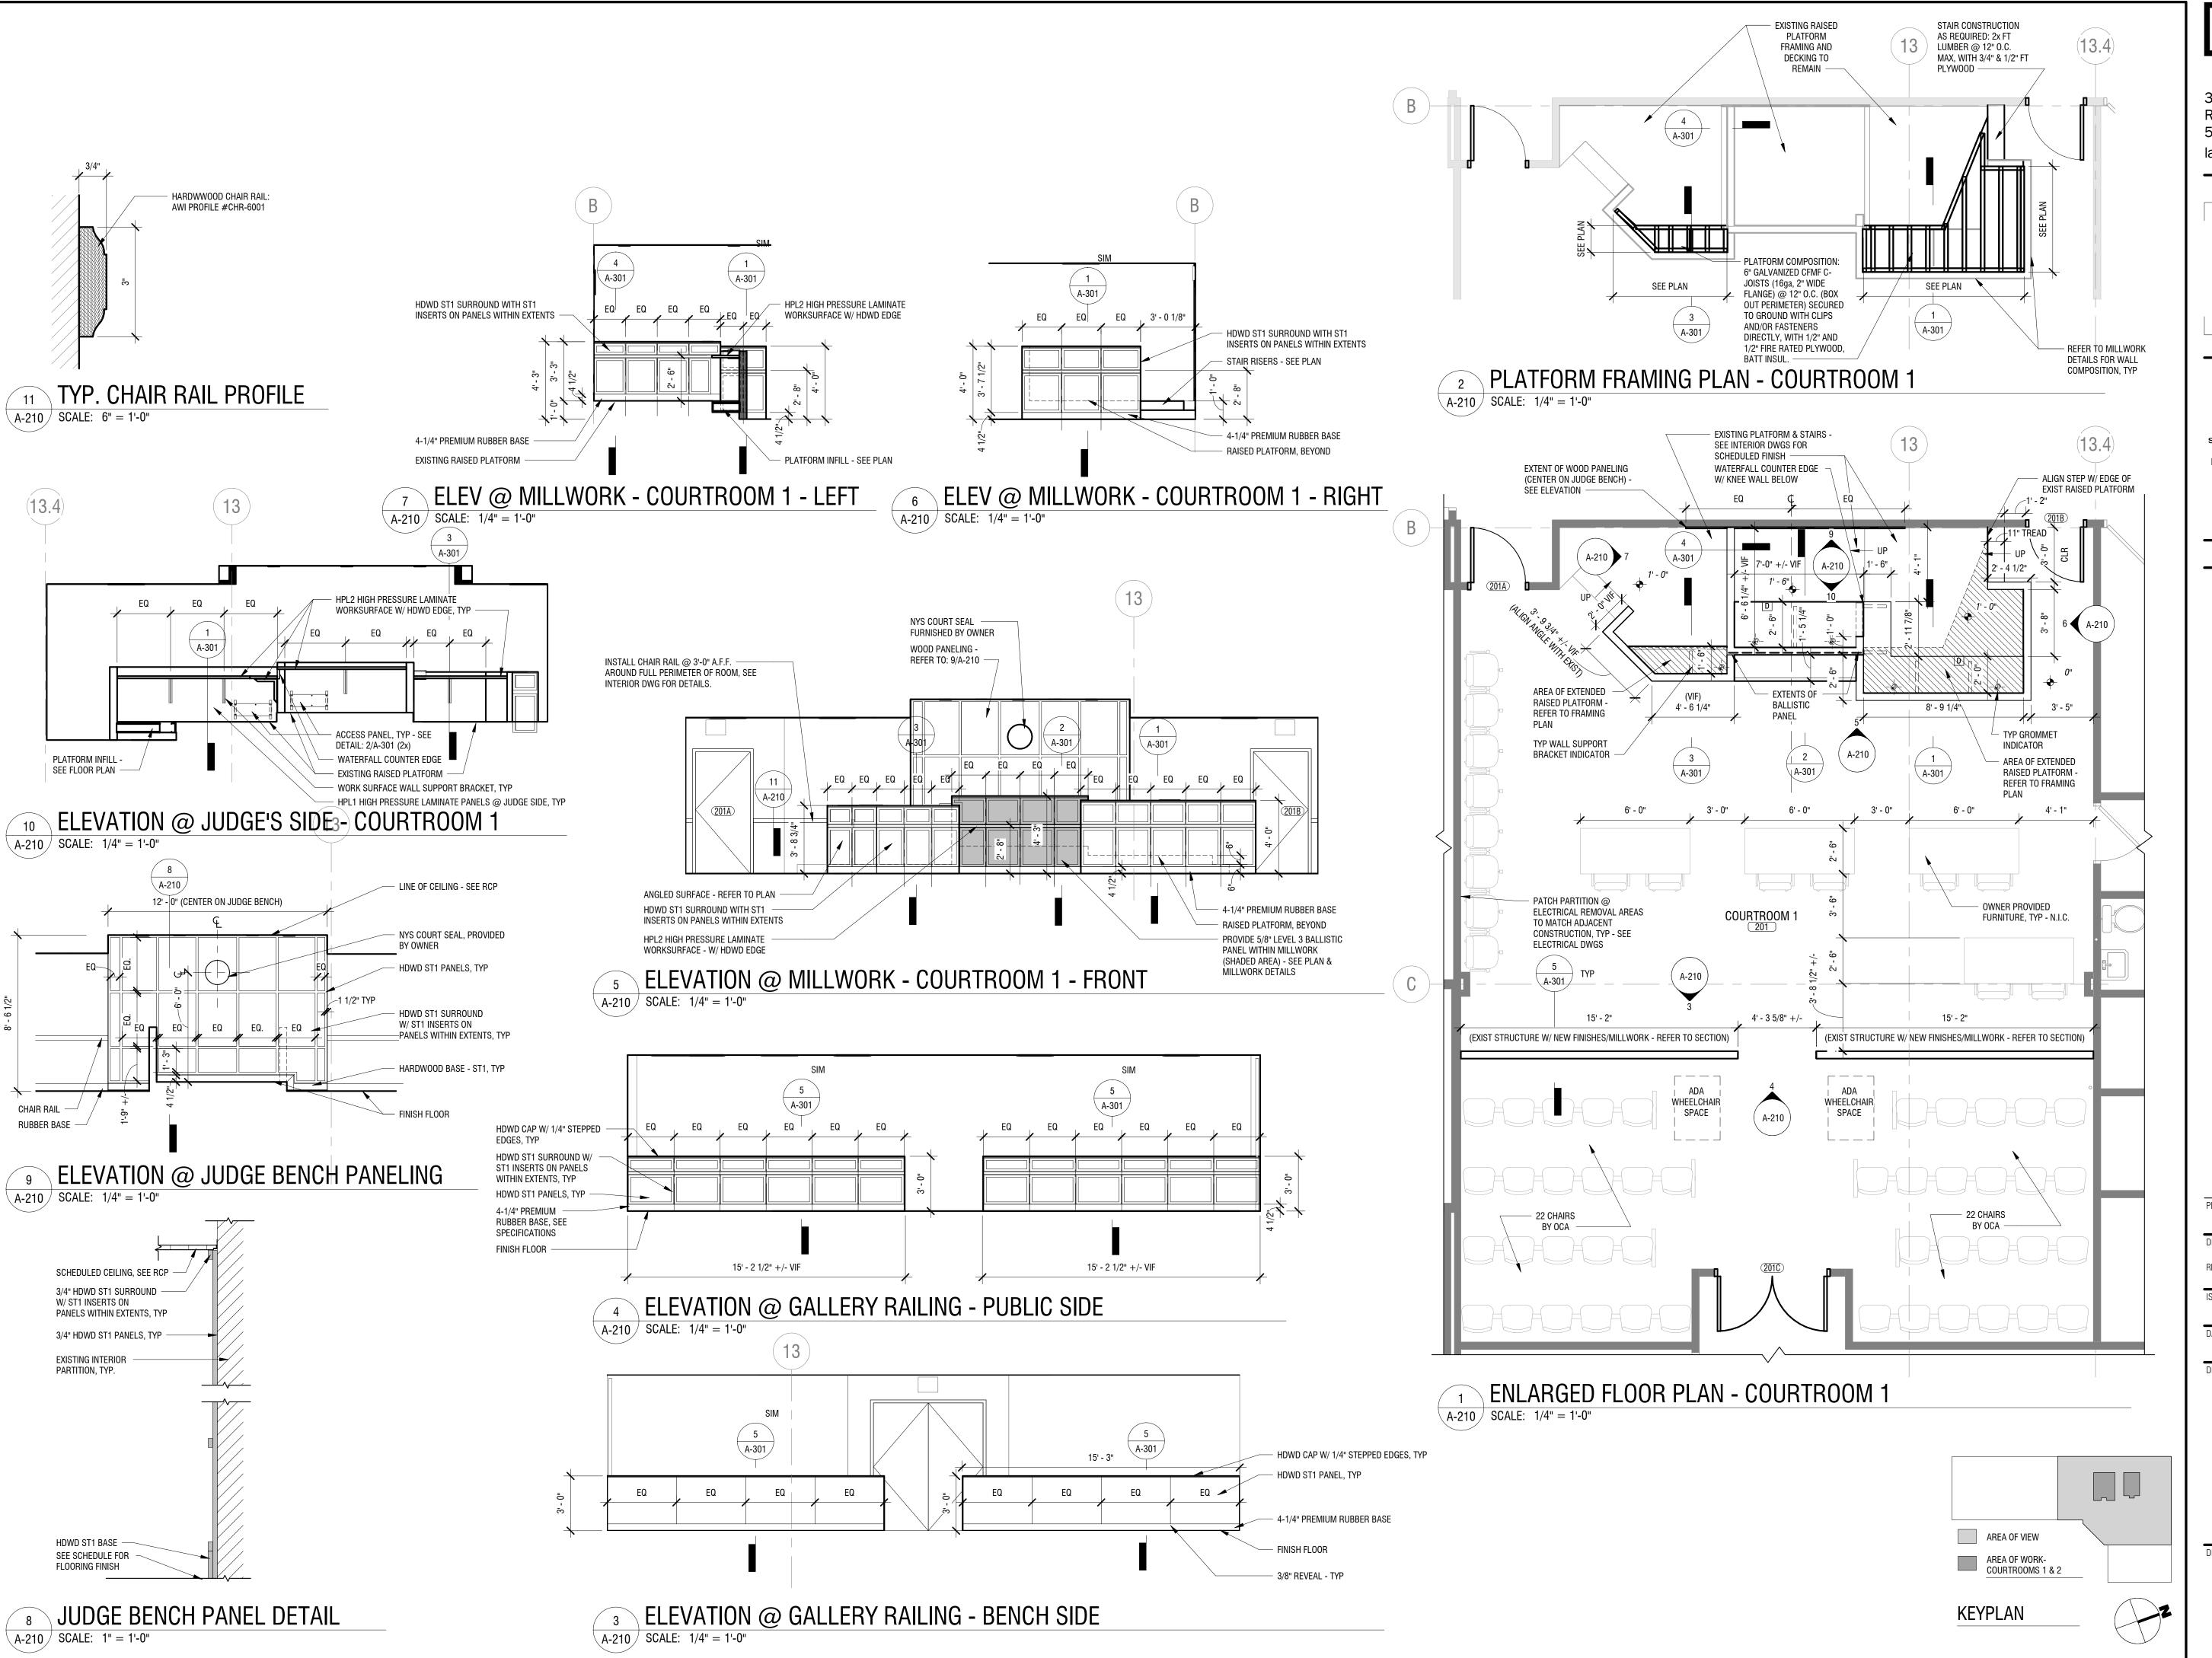

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CATTARAUGUS COUNTY DEPARTMENT OF PUBLIC WORKS

8810 ROUTE 242 LITTLE VALLEY, NEW YORK 14755

COUNTY COURT COURTROOM RENOVATIONS

1 LEO MOSS DRIVE OLEAN, NEW YORK 14760

PROJECT NUMBER:

2180593.01

DRAWN BY:

KC

REVIEWED BY:

JMK

ISSUED FOR:

BID

DATE:


MARCH 25, 2019

DRAWING NAME:

ENLARGED COURTROOM 1
PLAN & INTERIOR
ELEVATIONS

DRAWING NUMBER:

A-210

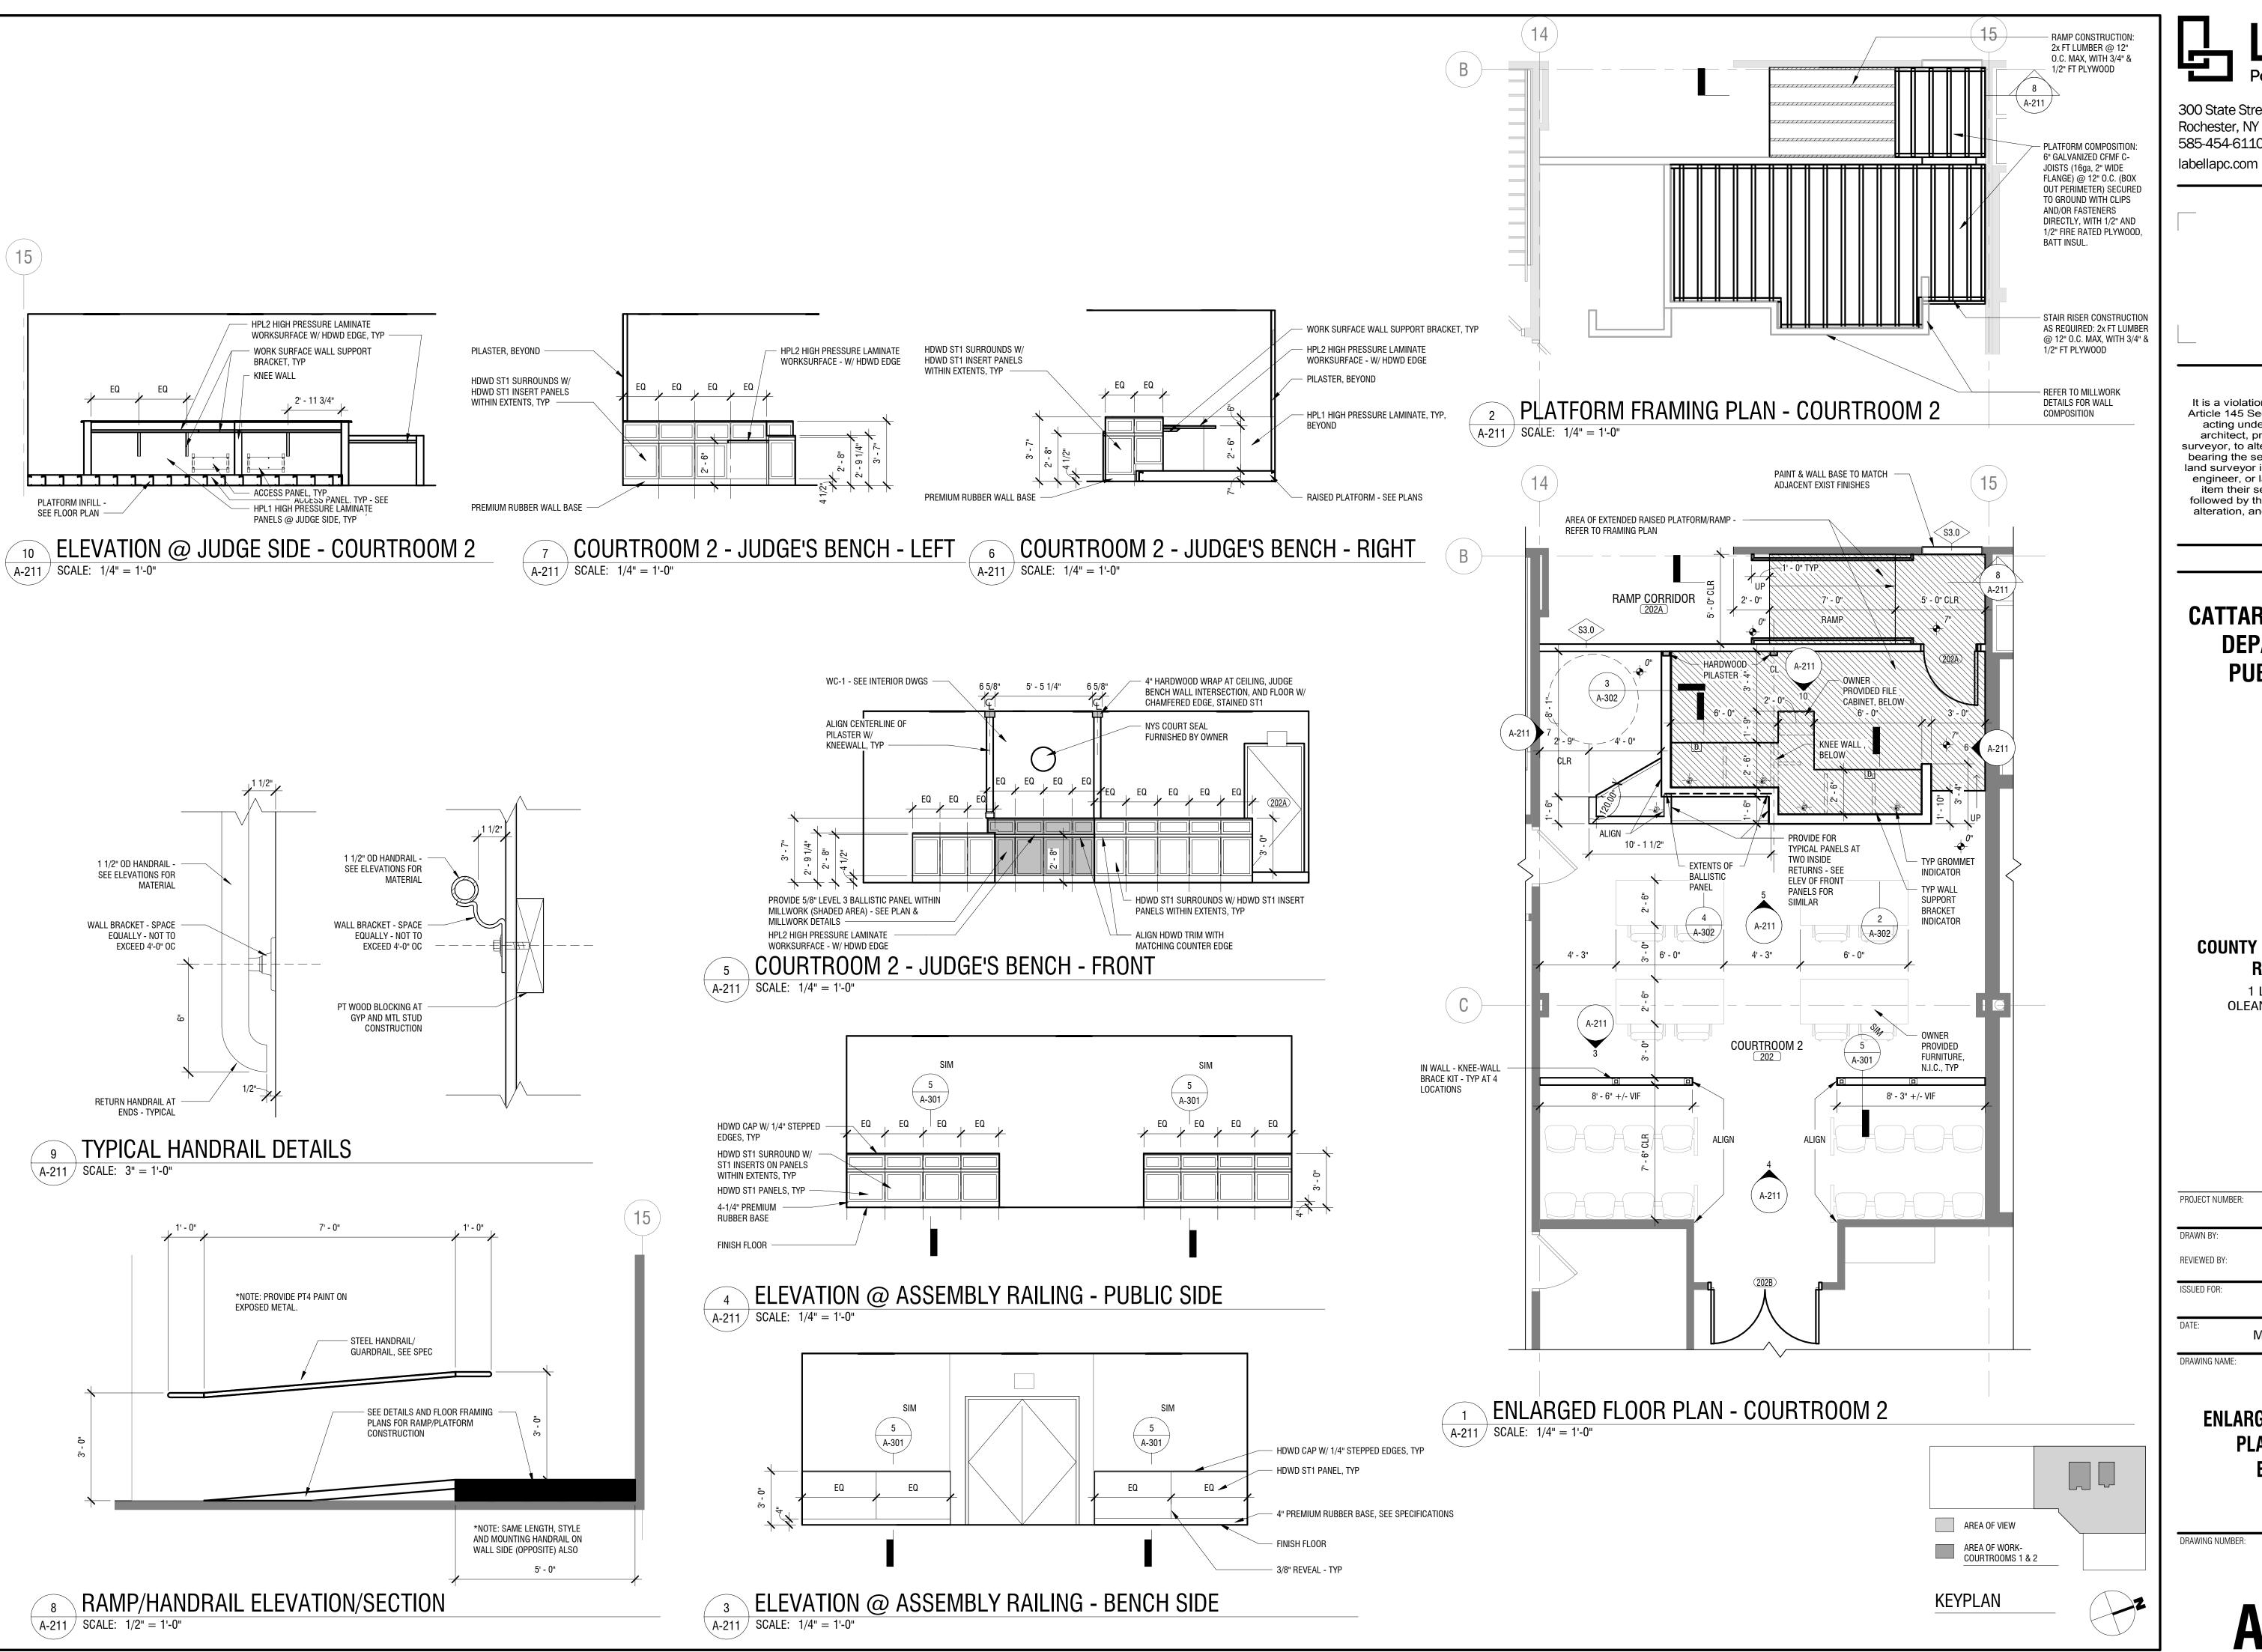

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CATTARAUGUS COUNTY DEPARTMENT OF PUBLIC WORKS

alteration.

COUNTY COURT COURTROOM RENOVATIONS


1 LEO MOSS DRIVE OLEAN, NEW YORK 14760


PROJECT NUMBER: 2180593.01 DRAWN BY: REVIEWED BY: JMK ISSUED FOR: BID DATE: MARCH 25, 2019

DRAWING NAME:

ENLARGED COURTROOM 2 PLAN & INTERIOR ELEVATIONS

DRAWING NUMBER:

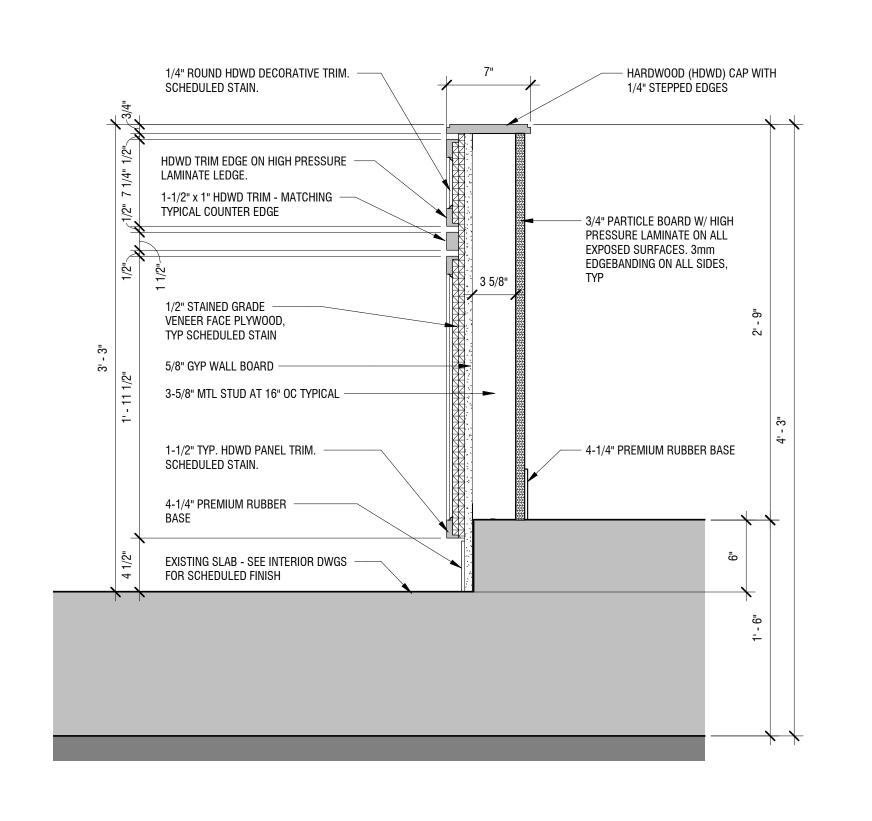

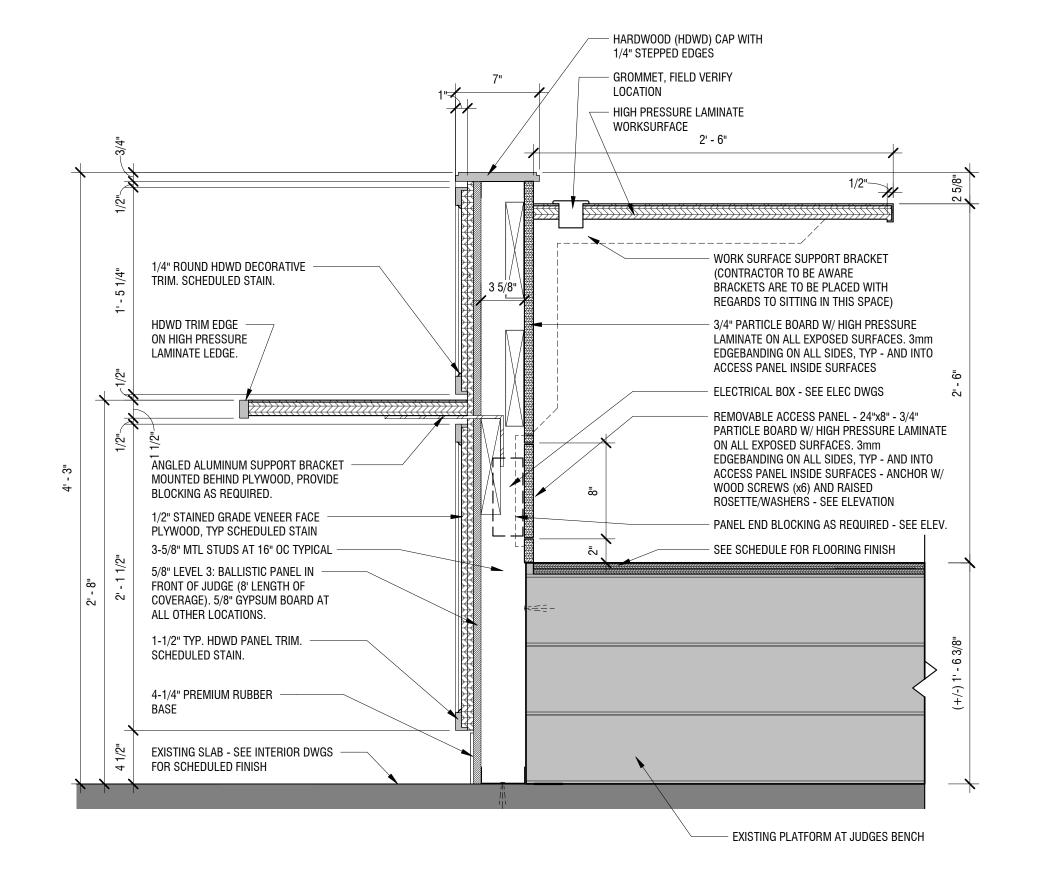

TYPICAL CEILING TRANSITION DETAIL

A-301 SCALE: 1 1/2" = 1'-0"

ACOUSTICAL CEILING GRID SYSTEM, TYP.


EXTRUDED ALUMINUM PERIMETER TRIM

ACOUSTICAL CEILING TILE, TYP.

4 DETAIL @ JUDGE SIDE WALL - COURTROOM 1

SCALE: 1 1/2" = 1'-0"

2 DETAIL @ JUDGES BENCH - COURTROOM 1
SCALE: 1 1/2" = 1'-0"

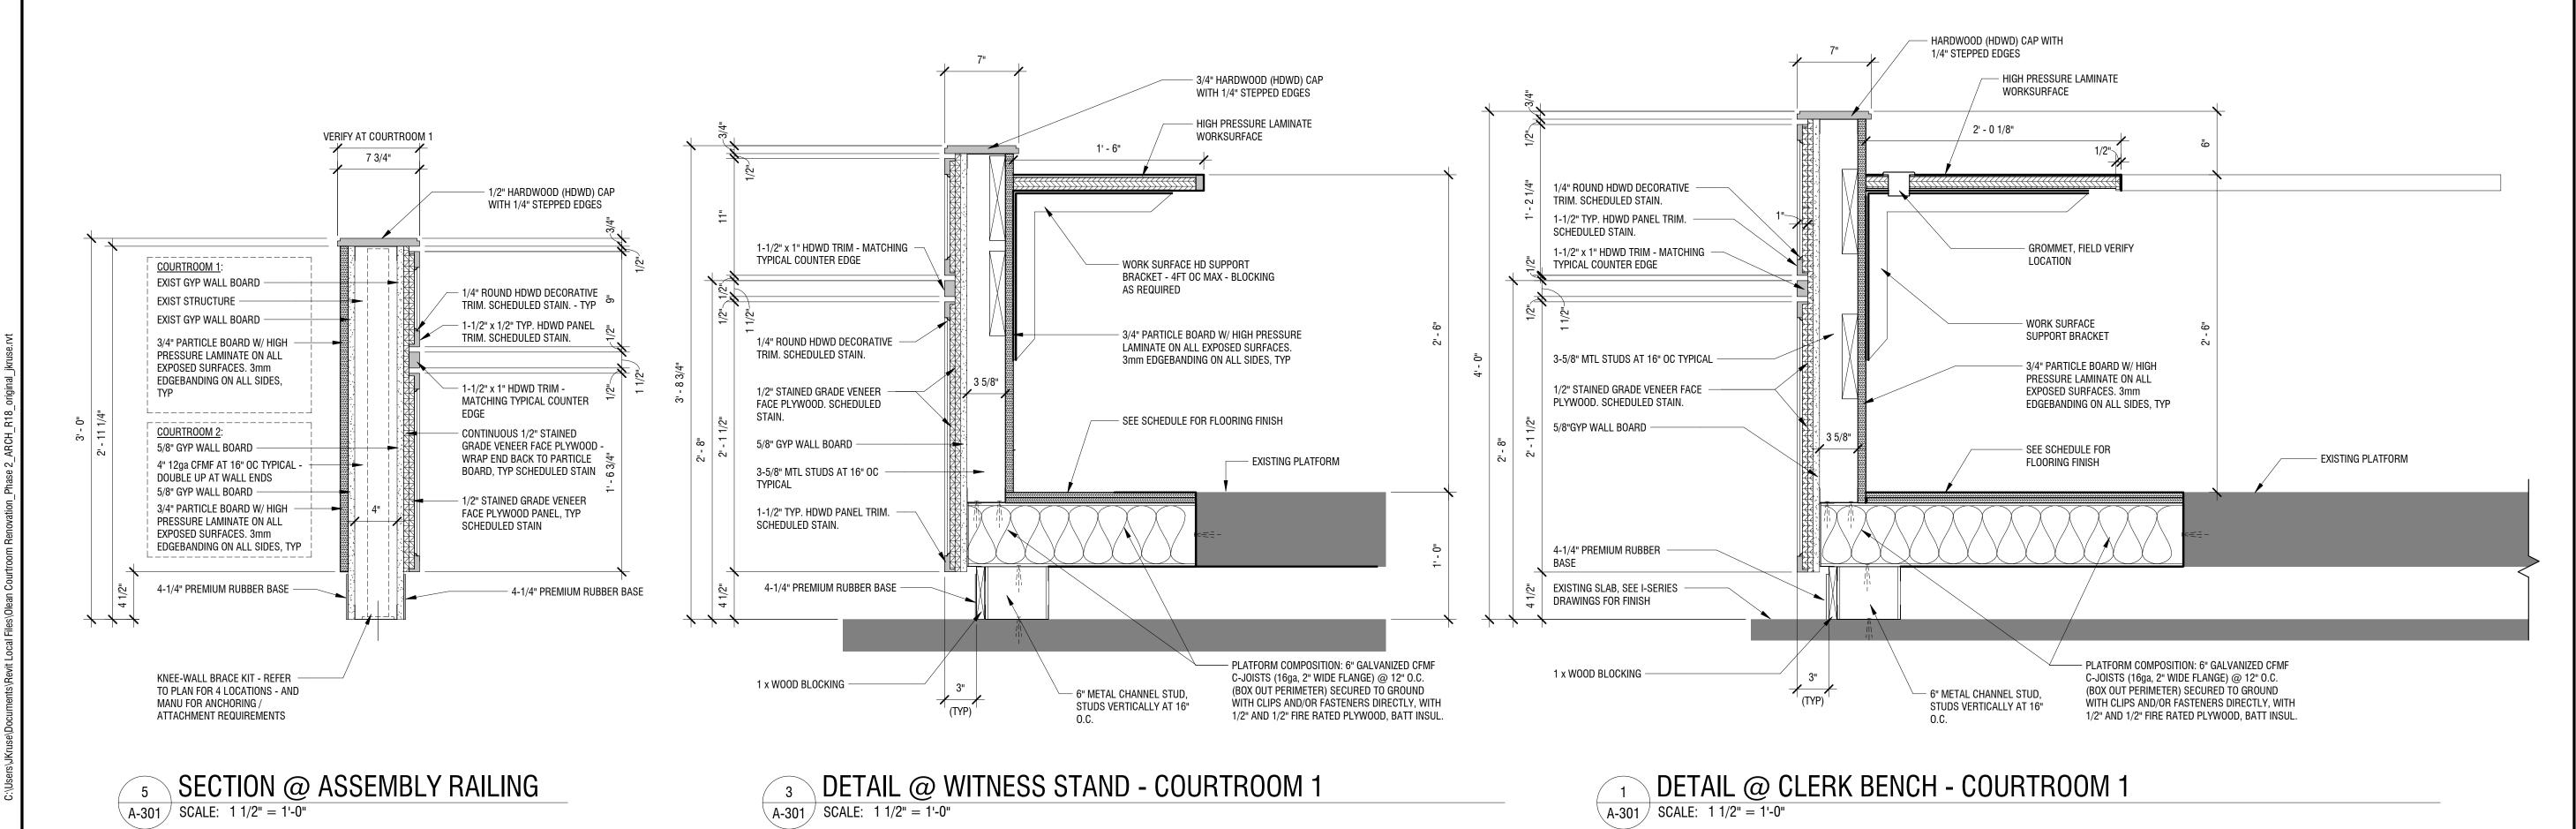

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CATTARAUGUS COUNTY DEPARTMENT OF PUBLIC WORKS

8810 ROUTE 242 LITTLE VALLEY, NEW YORK 14755

COUNTY COURT COURTROOM RENOVATIONS

1 LEO MOSS DRIVE OLEAN, NEW YORK 14760

PROJECT NUMBER:

2180593.01

DRAWN BY:

KC

REVIEWED BY:

JMK

ISSUED FOR:

BID

DATE:

MARCH 25, 2019

DRAWING NAME:


MILLWORK DETAILS -

COURTROOM 1

DRAWING NUMBER:

A-301

DETAIL @ TYPICAL COURT JUDGES BENCH-COURTROOM 2 SCALE: 1 1/2" = 1'-0"

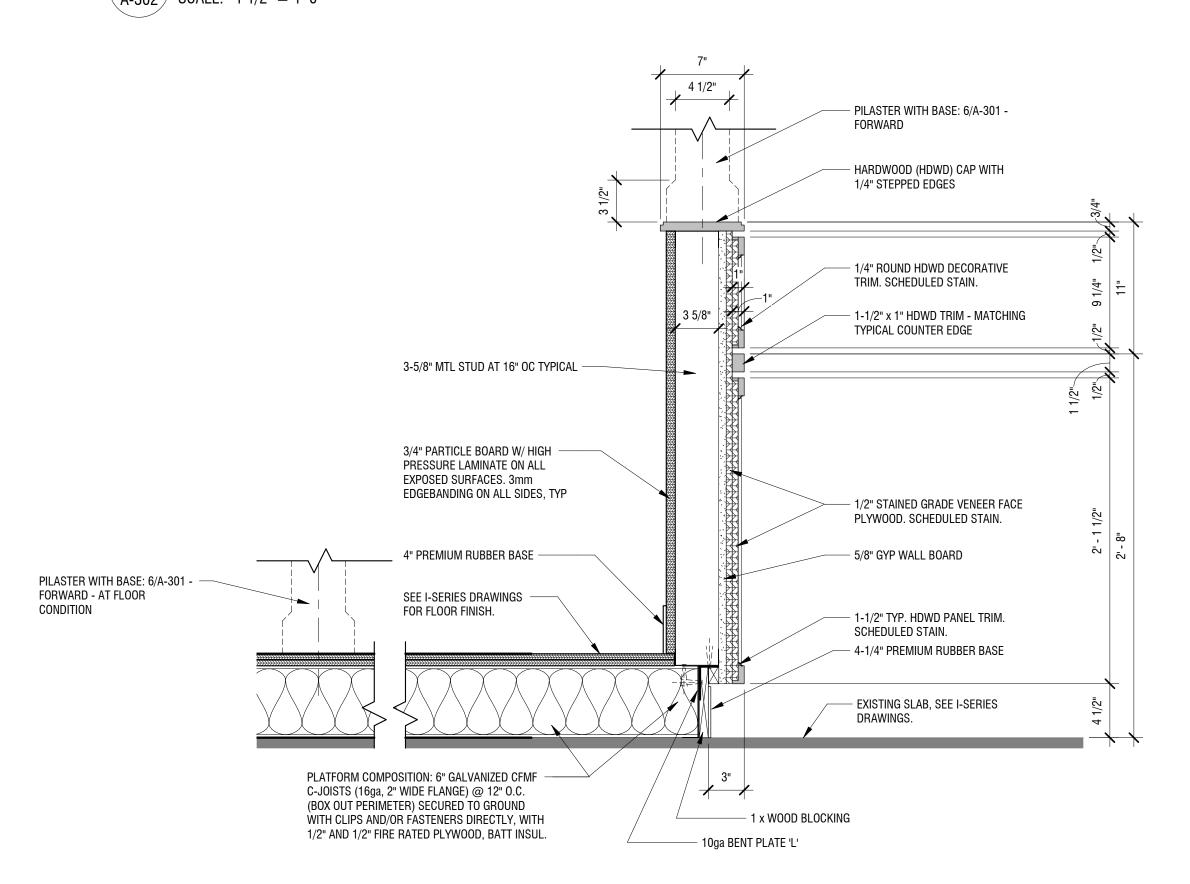

3 DETAIL @ TYPICAL JUDGES BENCH SIDE WALL A-302 SCALE: 1 1/2" = 1'-0"

GYPSUM WALL BOARD

BLOCKING AS REQ'D


STAINED VENEER PANEL PLYWOOD

w/ BEVELLED EDGE


3/4"x3-1/2" HDWD BASE WITH 45d

CHAMFERED TOP - ALL SIDES

JUDGE'S BENCH WALL PILASTER

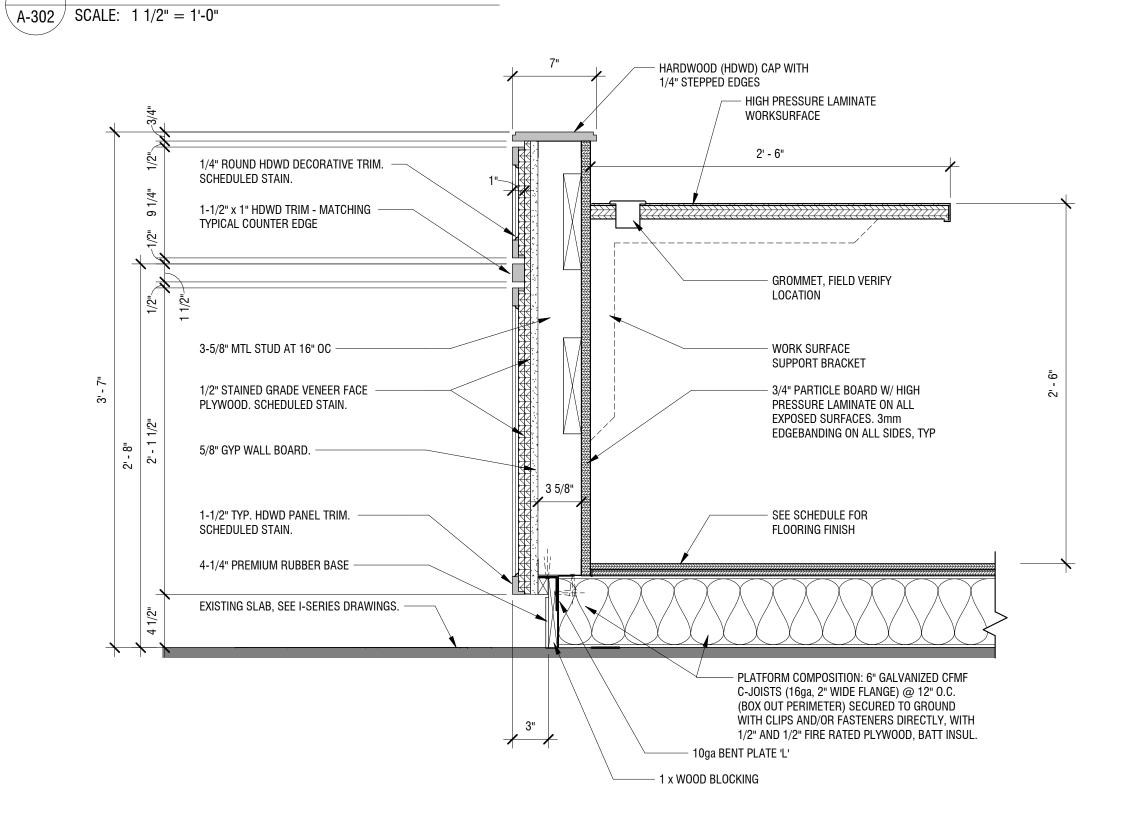

2 DETAIL @ TYPICAL CLERK BENCH SCALE: 1 1/2" = 1'-0"

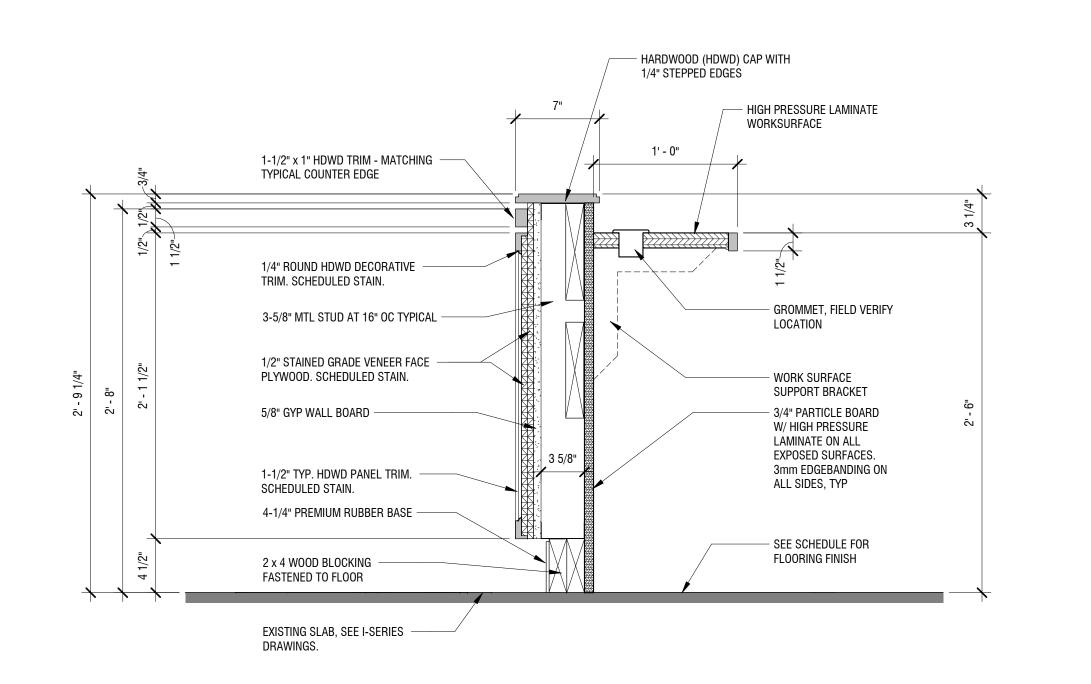

1 DETAIL @ TYPICAL WITNESS STAND

SCALE: 1 1/2" = 1'-0"

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CATTARAUGUS COUNTY DEPARTMENT OF PUBLIC WORKS

8810 ROUTE 242 LITTLE VALLEY, NEW YORK 14755

COUNTY COURT COURTROOM RENOVATIONS

1 LEO MOSS DRIVE OLEAN, NEW YORK 14760

PROJECT NUMBER:

2180593.01

DRAWN BY:

REVIEWED BY:

JMK

ISSUED FOR:

BID

DATE:

MARCH 25, 2019

DRAWING NAME:

MILLWORK DETAILS -COURTROOM 2

DRAWING NUMBER:

A-302

						D	00R S	CHED	ULE									
					D00	R				FRAME								
ROOM NAME	ROOM NO.	NO.	TYPE	WIDTH	HEIGHT	THICK.	MATL	FINISH	ТҮРЕ	MATL	FINIS H	HEAD	JAMB	GLAZING	RATING	HARD WARE		COMMENTS
COURTROOM 1	201	201A	F-1	3' - 0"	6' - 8"	1 3/4"	WD	FF	EXIST		PT					01	1, 4	
COURTROOM 1	201	201B	F-1	3' - 0"	6' - 8"	1 3/4"	WD	FF	EXIST		PT					01	1, 4	
COURTROOM 1	201	201C	EXIST	EXIST	EXIST	EXIST	EXIST	EXIST	HM-A	HM	PT	3/A-601	2/A-601			02	2, 3	
COURTROOM 2	202	202A	F-1	3' - 0"	7' - 0"	1 3/4"	WD	FF	EXIST		PT	3/A-601	2/A-601			01		
COURTROOM 2	202	202B	EXIST	EXIST ¹	EXIST ¹	EXIST	EXIST	EXIST	HM-A	НМ	PT	3/A-601	2/A-601			02	2, 3	

NO	TES/COMMENT KEY	
1.	FRAME TO REMAIN (PAINT AS INDICATED), INSTALL NEW DOOR HARDWARE	ANI

- NEW FRAME, HARDWARE, AND PAINT. INFILL FRAME WITH MINERAL WOOL INSULATION FOR ACOUSTIC PROPERTIES.
- 3. OWNER TO PROVIDE ACOUSTICAL DOOR FOR CONTRACTOR INSTALLATION
- 4. VERIFY EXSITING OPENING SIZE

<u>SCHE</u>	DULE ABBREV	ATIONS	
ALUM -	ALUMINUM	LQR -	LACQUER
ANRR -	ANODIZED - BRONZE	MANII -	PER MANUFAC

MTL - METAL

STL - STEEL

WD - WOOD

PAINT

SS - STAINLESS STEEL

ST - FACTORY STAINED

PT -

ANCL - ANODIZED - CLEAR

EXIST - EXISTING TO REMAIN

FAC - FACTORY/PREFINISHED

ANOD - ANODIZED

GALV - GALVANIZED


HM - HOLLOW METAL

GL - GLASS

GENERAL DOOR NOTES:

- 1. ALL HOLLOW METAL (HM) DOORS TO BE OF 'HEAVY-DUTY' TYPE, UNLESS NOTED OTHERWISE IN THE COMMENTS COLUMN. 2. ALL WOOD (WD) DOORS TO BE SOLID CORE, WOOD VENEER, HEAVY-DUTY
- TYPE, UNLESS NOTED OTHERWISE IN THE COMMENTS COLUMN.
- 3. ALL DOORS TO RECEIVE 5/8" UNDERCUT UNLESS OTHERWISE NOTED.

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CATTARAUGUS COUNTY DEPARTMENT OF PUBLIC WORKS

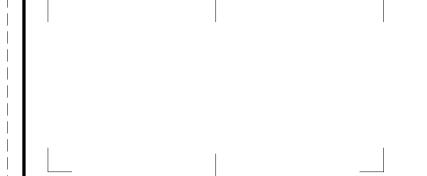8810 ROUTE 242 LITTLE VALLEY, NEW YORK 14755

COUNTY COURT COURTROOM RENOVATIONS

1 LEO MOSS DRIVE OLEAN, NEW YORK 14760

PROJECT NUMBER: 2180593.01 DRAWN BY: REVIEWED BY: ISSUED FOR: BID

MARCH 25, 2019


DRAWING NAME:

DATE:


DOOR / WINDOW & FRAME TYPES, SCHEDULES & **DETAILS**

DRAWING NUMBER:


A-601

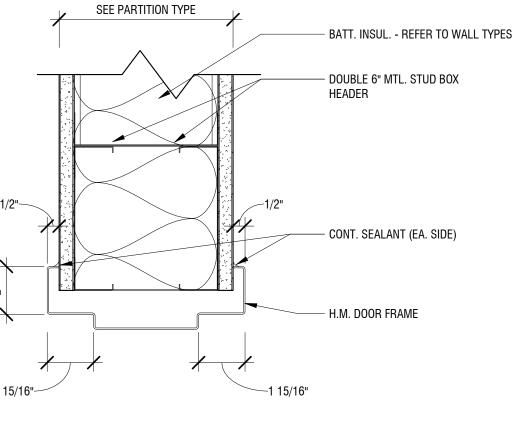


3 INTERIOR HM DOOR HEAD AT GWB AND MTL STUD A-601 | SCALE: 3" = 1'-0"

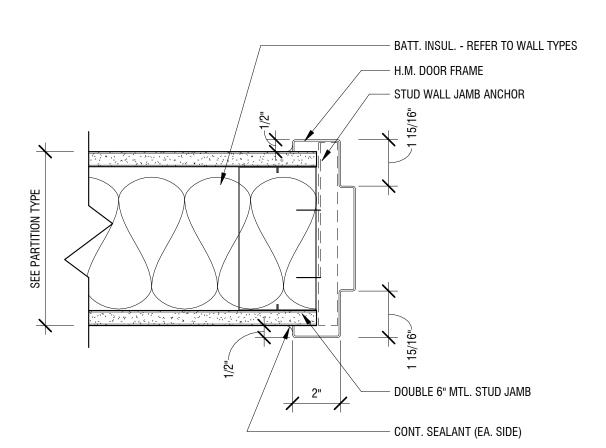


2 INTERIOR HM DOOR JAMB AT GWB AND MTL STUD A-601 SCALE: 3" = 1'-0"

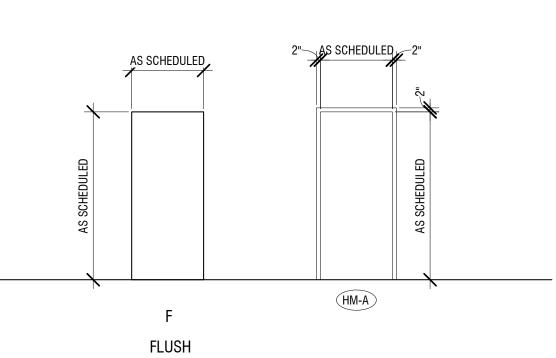

1 DOOR AND FRAME TYPES A-601 SCALE: 1/4" = 1'-0"

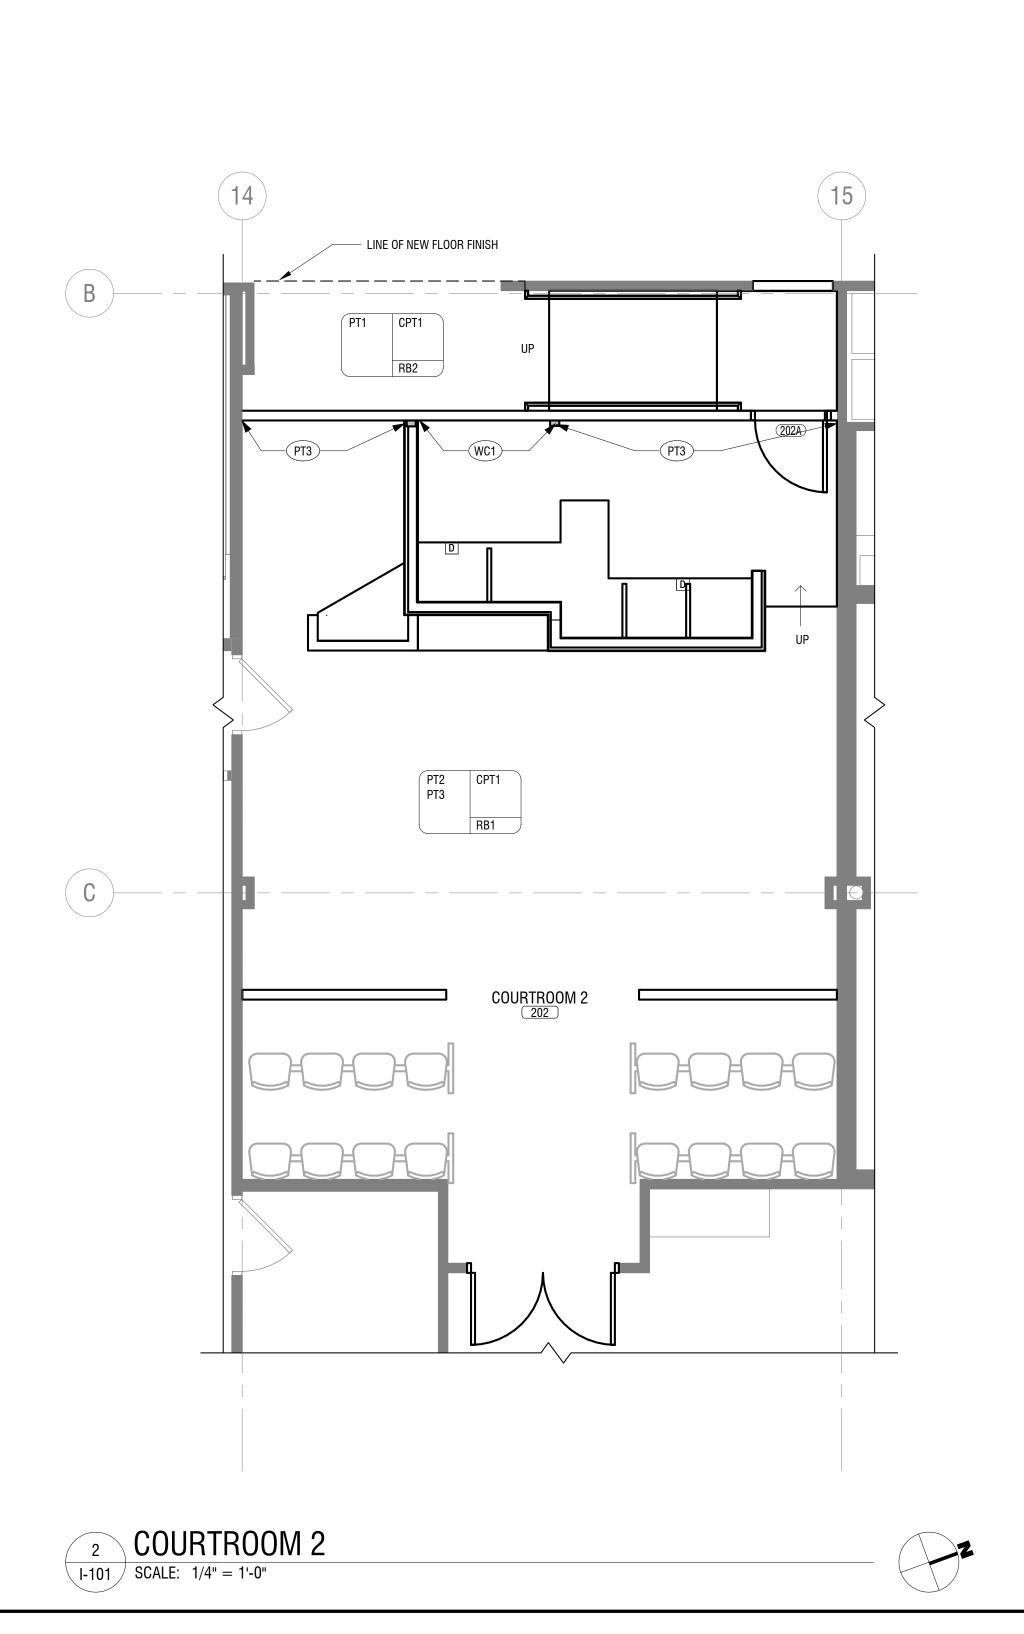

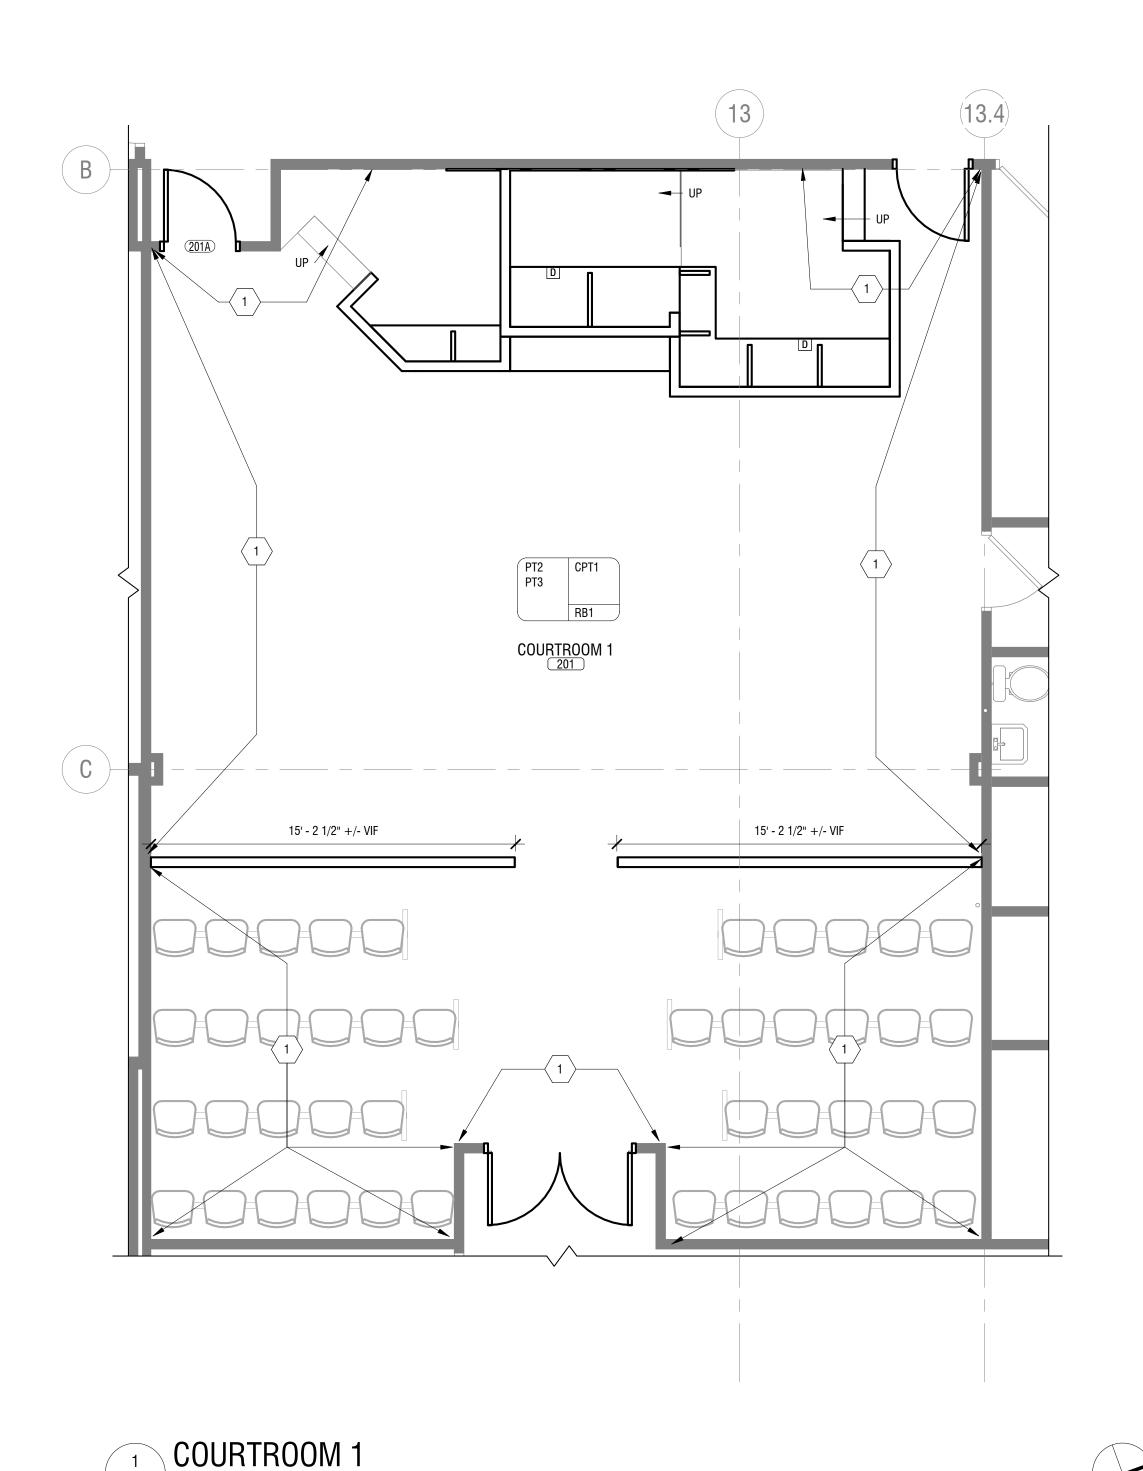

I-101 SCALE: 1/4" = 1'-0"

FINISH PLAN GENERAL NOTES

INSTALL CPT1 IN A QUARTERTURNED PATTERN.

REFER TO DIVISION 09 SECTION 09000 COLOR AND FINISH LEGEND FOR DETAILED INFORMATION ON FINISHES AND ABBREVIATIONS.

3. ALL NEW AND EXISTING HOLLOW METAL DOORS, DOOR FRAMES, AND HOLLOW METAL WINDOW FRAMES WITHIN AREA OF WORK SHALL BE PAINTED PT4.


ALL LOUVERS, VENTS, GRILLES, AND OTHER MISC. MECHANICAL & ELECTRICAL DEVICES ARE TO BE PAINTED TO MATCH SURFACE ON WHICH THEY APPEAR, UNLESS NOTED OTHERWISE.

5. ALL FLOOR FINISHES SHALL TRANSITION AT CENTERLINE OF DOOR, UNLESS NOTED OTHERWISE.

WHERE NEW FINISHES ARE SCHEDULED AT EXISTING CONDITIONS, REMOVE EXISTING FINISHES AND PREPARE SURFACES FOR NEW FINISH

7. PROVIDE PREMIUM RUBBER BASE (RB-3) AT MILLWORK. NO BASE ON PRIVATE SIDE OF MILLWORK.

FINISH SYMBOLS LEGEND & ABBREVIATIONS

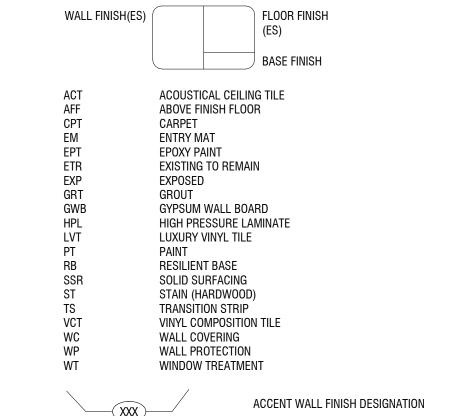

EXTENTS OF CHAIR RAIL

FINISH PLAN KEYNOTES

PROVIDE CHAIR RAIL WITH TOP INSTALLED AT 3'-0" AFF, WITH PT-3 BELOW AND PT-2 ABOVE.

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CATTARAUGUS COUNTY DEPARTMENT OF PUBLIC WORKS

8810 ROUTE 242 LITTLE VALLEY, NEW YORK 14755

COUNTY COURT COURTROOM RENOVATIONS

1 LEO MOSS DRIVE OLEAN, NEW YORK 14760

PROJECT NUMBER:

2180593.01

DRAWN BY:

KC

REVIEWED BY:

JMK

ISSUED FOR:

BID

MARCH 25, 2019

DRAWING NAME:

ENLARGED SECOND FLOOR COURTROOM FINISH

PLANS

DRAWING NUMBER:

DATE:

I-101


DRAWING SYMBOLS

DUCTWORK GENERAL NOTES

- GENERAL CONTRACTOR TO PROVIDE ALL ROOF PENETRATIONS REQUIRED TO ACCOMMODATE HVAC EQUIPMENT OPENINGS AND SET CURBS. HVAC CONTRACTOR TO COORDINATE EXACT LOCATION OF PENETRATIONS WITH G.C. AND SHALL ASSIST WITH SETTING ALL HVAC EQUIPMENT ROOF CURBS. HVAC CONTRACTOR SHALL BE RESPONSIBLE FOR TEMPORARY CAP OF ALL ROOF PENETRATIONS IN INTERIM FROM TIME PENETRATIONS ARE COMPLETE TO TIME EQUIPMENT IS SET ON ROOF CURBS. GENERAL CONTRACTOR SHALL BE RESPONSIBLE FOR FLASHING ALL EQUIPMENT CURBS AND OTHER HVAC RELATED ROOF PENETRATIONS. HVAC CONTRACTOR SHALL REMOVE AND DISPOSE OF TEMPORARY CAP WHEN EQUIPMENT IS SET IN PLACE.
- PROVIDE 45 DEGREE SHOE-TAP FITTING AND VOLUME DAMPER AT ALL BRANCH DUCT TAKE-OFFS (TOP, SIDE AND BOTTOM) FOR SUPPLY, RETURN AND EXHAUST AIR, UNLESS SHOWN OR NOTED OTHERWISE. VOLUME DAMPERS SHALL BE OMITTED FROM VAV INLET BRANCH DUCTWORK.
- COORDINATE HVAC INSTALLATION WITH STRUCTURE, CEILING, LIGHTING, CONDUIT, HEATING AND DOMESTIC PIPING, STORM AND SANITARY DRAIN PIPING (ALL TRADES). PREPARE AND SUBMIT FULL COORDINATION DRAWINGS FOR APPROVAL BY ENGINEER PRIOR TO ORDERING MATERIALS AND/OR BEGINNING CONSTRUCTION.
- 4 INSULATE OR LINE DUCTWORK AS SPECIFIED IN THE MECHANICAL INSULATION AND METAL DUCTS SPECIFICATIONS OR NOTED ON DRAWINGS. NOTE THAT DUCT SIZES SHOWN ON DRAWINGS ARE INSIDE NET CLEAR DIMENSIONS.
- ALL 90 DEGREE RECTANGULAR ELBOWS AND DUCTWORK TEES SHALL BE HARD MITERED WITH FACTORY TURNING VANES.
 TURNING VANES SHALL BE OMITTED FROM AIR TRANSFER DUCT ELBOWS.
- ALL DUCTWORK PASSING THROUGH NON-FIRE RATED WALLS TO BE SEALED AROUND PERIMETER (BOTH SIDES) WITH DRYWALL JOINT COMPOUND OR APPROVED EQUAL.
- INLET OF VAV BOX TO BE ARRANGED SUCH THAT THERE IS NO RESTRICTION OF AIRFLOW. THERE SHALL BE A MINIMUM OF THREE DUCT DIAMETERS OF STRAIGHT DUCT (FLEX DUCT WILL NOT BE PERMITTED) UPSTREAM OF THE INLET. INLET DUCT SIZE TO BE SAME SIZE AS VAV BOX INLET COLLAR UNLESS NOTED OTHERWISE. REFER TO VAV BOX INSTALLATION DETAIL FOR ADDITIONAL REQUIREMENTS.
- HVAC CONTRACTOR TO PROVIDE ALL WALL & ROOF PENETRATIONS 8"x8" OR SMALLER. ALL PENETRATIONS LARGER THAN 8"x8" IS THE RESPONSIBILITY OF THE G.C. COORDINATE ALL 8"x8" OR LARGER PENETRATION LOCATIONS WITH G.C. LINTELS (BY G.C.) REFER TO STRUCTURAL DRAWINGS FOR LINTEL SCHEDULE. PENETRATIONS AND LINTEL LOCATIONS TO BE COORDINATED WITH G.C. AND DOCUMENTED ON COORDINATION DRAWINGS.
- 9 BALANCING CONTRACTOR TO SET MINIMUM OUTSIDE AIR DAMPER POSITION TO MEET VENTILATION AIR QUANTITIES REQUIRED AS SHOWN ON PLANS OR LISTED IN EQUIPMENT SCHEDULES.
- NATURAL GAS PIPING WHERE REQUIRED SHALL BE PROVIDED BY THE PLUMBING CONTRACTOR, WHICH SHALL INCLUDE FINAL CONNECTIONS TO HVAC EQUIPMENT. COORDINATE ALL EQUIPMENT LOCATIONS THAT REQUIRE NATURAL GAS WITH THE PLUMBING CONTRACTOR.
- ALL SUPPORT OF EQUIPMENT, DUCTWORK AND ASSOCIATED DISTRIBUTION SERVICES SHALL BE DESIGNED AND INSTALLED IN ACCORDANCE WITH THE BUILDING CODE OF NEW YORK STATE. THE DISCIPLINE CONTRACTOR SHALL BE RESPONSIBLE TO PROVIDE STRUCTURAL STEEL WHERE REQUIRED IN ORDER TO SUPPORT EQUIPMENT, DUCTWORK AND ASSOCIATED DISTRIBUTION SERVICES WHERE THE BUILDING STRUCTURE SPACING IS TOO GREAT TO ALLOW DIRECT SUPPORT. THE DISCIPLINE CONTRACTOR SHALL BE RESPONSIBLE FOR CONFIRMATION OF ALL SUPPORTS AND SHALL OBTAIN THE PROFESSIONAL SERVICE OF A STRUCTURAL ENGINEER LICENSED IN THE STATE OF NEW YORK AND FURNISH SEALED DRAWINGS AND DETAILS ILLUSTRATING SUCH SUPPORTS AND COMPLIANCE METHODS.
- 12 THE ABOVE GENERAL NOTES APPLY TO ALL HVAC CONSTRUCTION DOCUMENT DRAWINGS.

PIPING GENERAL NOTES

- COORDINATE HVAC PIPING INSTALLATION WITH DUCTWORK, STRUCTURE, CEILING, LIGHTING, CONDUIT, HEATING AND DOMESTIC PIPING, STORM AND SANITARY DRAIN PIPING (ALL TRADES). PREPARE AND SUBMIT FULL COORDINATION DRAWINGS FOR APPROVAL BY ENGINEER PRIOR TO ORDERING MATERIALS AND/OR BEGINNING CONSTRUCTION.
- 2 PROVIDE ALL PIPING PENETRATIONS THROUGH WALLS, FLOORS AND DECKS REQUIRED WHERE SHOWN. SEAL ALL EXTERIOR WALL AND ROOF PENETRATIONS WEATHER TIGHT.
- 3 ALL PIPING PASSING THROUGH WALLS THAT HAVE A FIRE RATING ARE TO BE PROVIDED WITH A UL-LISTED FIRE STOP SYSTEM
- 4 INSTALL VAV BOX REHEAT PIPING AND ASSOCIATED VALVES/COMPONENTS SUCH THAT CONTROL BOX HAS A MINIMUM 2'-0"
- 5 HVAC CONTRACTOR IS RESPONSIBLE FOR DRAINING, FILLING WITH WATER/CHEMICALS, AND AIR REMOVAL ASSOCIATED WITH
- 6 ALL REFRIGERANT PIPING IS TO BE PURGED WITH NITROGEN AND BRAZED PER SPECIFICATIONS.
- 7 ALL ABOVE GENERAL NOTES APPLY TO HVAC CONSTRUCTION DOCUMENT DRAWINGS.

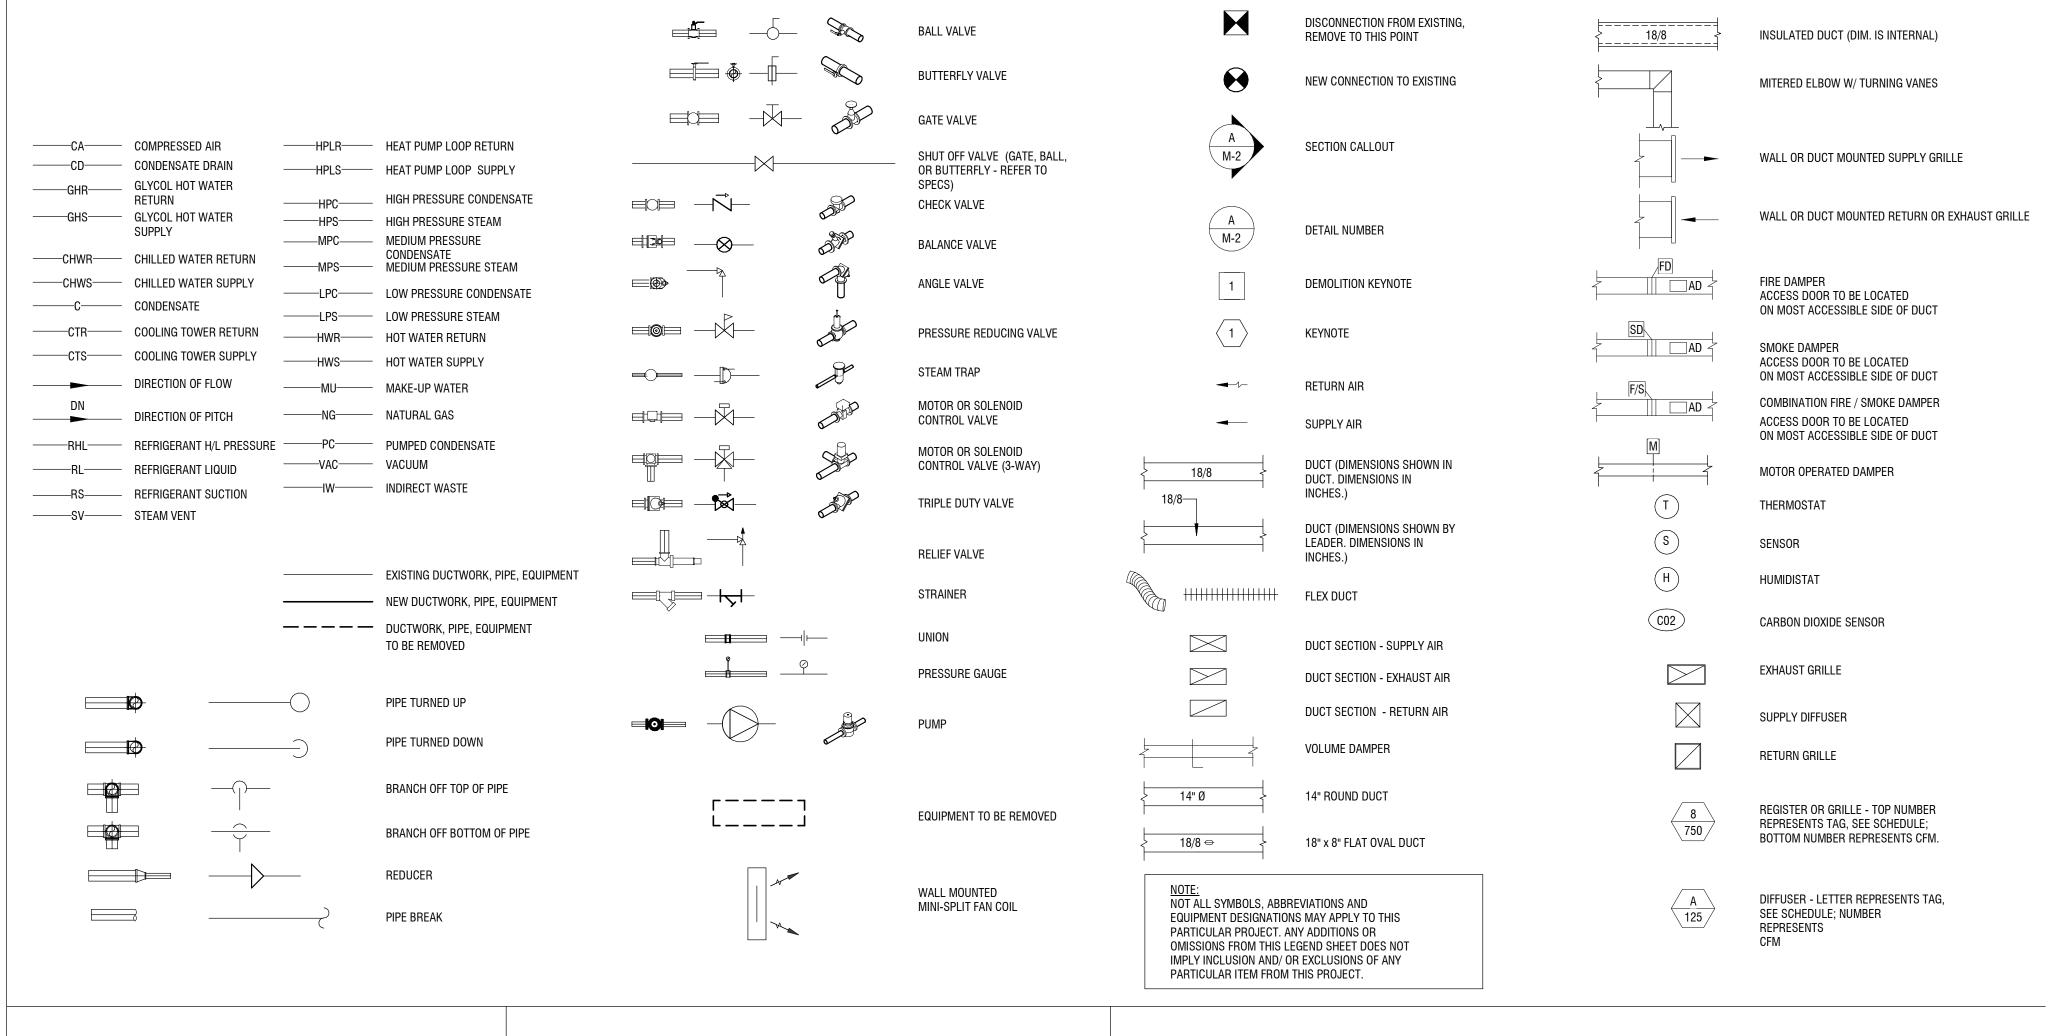

	ATIONS	REVIA	ABB		IONS	DESIGNAT	EQUIPM			APPLICABLE CODES
NIC NO NPT NRS NTS OC OD OS&Y PC PLBG PH PRESS PSF PSI PSIG PRV RCVR RECIRC RHW RO RPDA TIONING TIONING TIONING TYP SQ SQ FT SQ IN STD SUCT T'STAT TBD TC TD TEMP TMV TO TYP V VAC VAR VEL VIF VOL W W/ W/O WCO WHA WMI WPD WT WWP	FREE AREA FINISHED FLOOR FULL LOAD AMPS FEET PER MINUTE FEET PER SECOND FOOT OR FEET FUTURE GAGE OR GAUGE GALLONS GENERAL CONTRACTOR GALLONS PER MINUTE GALLONS PER MINUTE GALLONS PER HOUR HEAD MERCURY HORIZONTAL HORSEPOWER HIGH PRESSURE CONDENSATE HIGH PRESSURE STEAM HOUR HEATING, VENTILATING, AND AIR CONDITIONING FREQUENCY DIAMTER, INSIDE INCH INSULATION INTERIOR IRON PIPE SIZE INVERT KILOWATT KILOWATT KILOWATT KILOWATT HOUR POUNDS LINEAR FEET LENGTH LOCATION LOW PRESSURE CONDENSATE LOW PRESSURE STEAM LOCKED ROTOR AMPS LEAVING WATER TEMPERATURE MATERIAL MAXIMUM BTU PER HOUR (THOUSAND) MECHANICAL MANUFACTURER MINIMUM MISCELLANEOUS MAXIMUM OVERCURRENT PROTECTION MEDIUM PRESSURE CONDENSATE MEDIUM PRESSURE STEAM MOUNTING NOT APPLICABLE NORMALLY CLOSED	FA FIN FLA FPM FPS FT FUT GAL GPM GPD HORIZ HPC HPS HVAC HPS INV KWH LBS LPC LPS LWT MAX MBH MISC MINSUL LPS LPS LWT MAX MBH MISC MINSUL MINSU	CENT ERNATING CURRENT ACENT VE FINISHED FLOOR VE FINISHED GRADE ERNATE JENT ERE (AMP,AMPS) RICAN NATIONAL STANDARD INSTITUTE ORXIAMTE (LY) RAGE KFLOW PREVENTER KE HORSEPOWER DING TOM OF EMENT ISH THERMAL UNIT ANCING VALVE ACITY T IRON PIPE ING AR ANOUT OF CARBON MONOXIDE UMN NECTION CRETE TINUOUS IC FEET VE FLOW COEFFICIENT BLE CHECK DETECTOR ASSEMBLY ECTOR CHECK VALVE JESTIC COLD WATER OLISH OF DEMOLITION JESTIC HOT WATER METER TILE IRON PIPE JESTIC WATER HEATER IN, WASTE, & VENT WING TING INGER AL MATED TING TO REMAIN CTRIC WATER HEATER ERING WATER HEATER ERING WATER TEMPERATURE TING TING TING TING TING TING TING TING	% AC ADJ AFF AFG ALT AMB AMP ANSI APPROX AVG BFP BLDG BSMT BTU BV CAP CIP CLG CONC CONT CU FT CV DCDA DCV DCW DEMO DHW DIA DIP DWH DWV DWG (E) ENGR EQ EST ETR EWH EXT EXP EXT °F	HEATING COIL HEAT PUMP HUMIDIFIER HOT WATER PUMP HEAT EXCHANGER LOUVER MAKE UP AIR UNITS MOTORIZED DAMPER PUMP PREHEAT COIL PUMPING PACKAGED UNIT GAS PRESSURE REGULATOR PRESSURE REDUCING VALVE REGISTER RADIANT CEILING PANEL ROOF TOP UNIT UNIT HEATER UNIT VENTILATOR VARIABLE AIR VOLUME BOX VOLUME DAMPER VARIABLE SPEED DRIVE WATER SOFTENER	HC HP HU HWP HX L MAU MD P PHC PPU PRG PRV R RCP RTU UH UV VAV VD VFD WS REVIATIONS MAY NOT BE USEI	RATOR AFT DAMPER PRESSOR T AIR VOLUME BOX COIL A FEED PUMP WATER PUMP ATE PUMP R ROOM UNIT ATE RETURN UNIT TOWER ING UNIT JNIT HEATER VALVE C WATER HEATER FAN IN TANK UNIT P	AIR ACC AIR BAC BOII AIR CON COC CHE CHI CON COC COC	전보의 의 의 의 의 의 의 의 의 의 의 의 의 의 의 의 의 의 의	BUILDING CODE OF NEW YORK STATE ENERGY CODE OF NEW YORK STATE MECHANICAL CODE OF NEW YORK STATE FIRE CODE OF NEW YORK STATE PLUMBING CODE OF NEW YORK STATE ENERGY CONSERVATION CODE OF NEW YORK STATE ACCESSIBLE AND USABLE BUILDING AND FACILITIES-CABO/ANSI A117.1 NATIONAL ELECTRIC CODE NATIONAL FIRE CODE NFPA 13



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alteration.

CATTARAUGUS COUNTY DEPARTMENT OF PUBLIC WORKS

8810 ROUTE 242 LITTLE VALLEY, NEW YORK 14755

COUNTY COURT COURTROOM RENOVATIONS

1 LEO MOSS DRIVE OLEAN, NEW YORK 14760

NO: DATE: DESCRIPTION:
Revisions

PROJECT NUMBER:

2180593.01

DRAWN BY: ZZ
REVIEWED BY: EJL

ISSUED FOR: BID


DATE: MARCH 25, 2019

MECHANICAL LEGEND SHEET

DRAWING NUMBER:

DRAWING NAME:

M-001

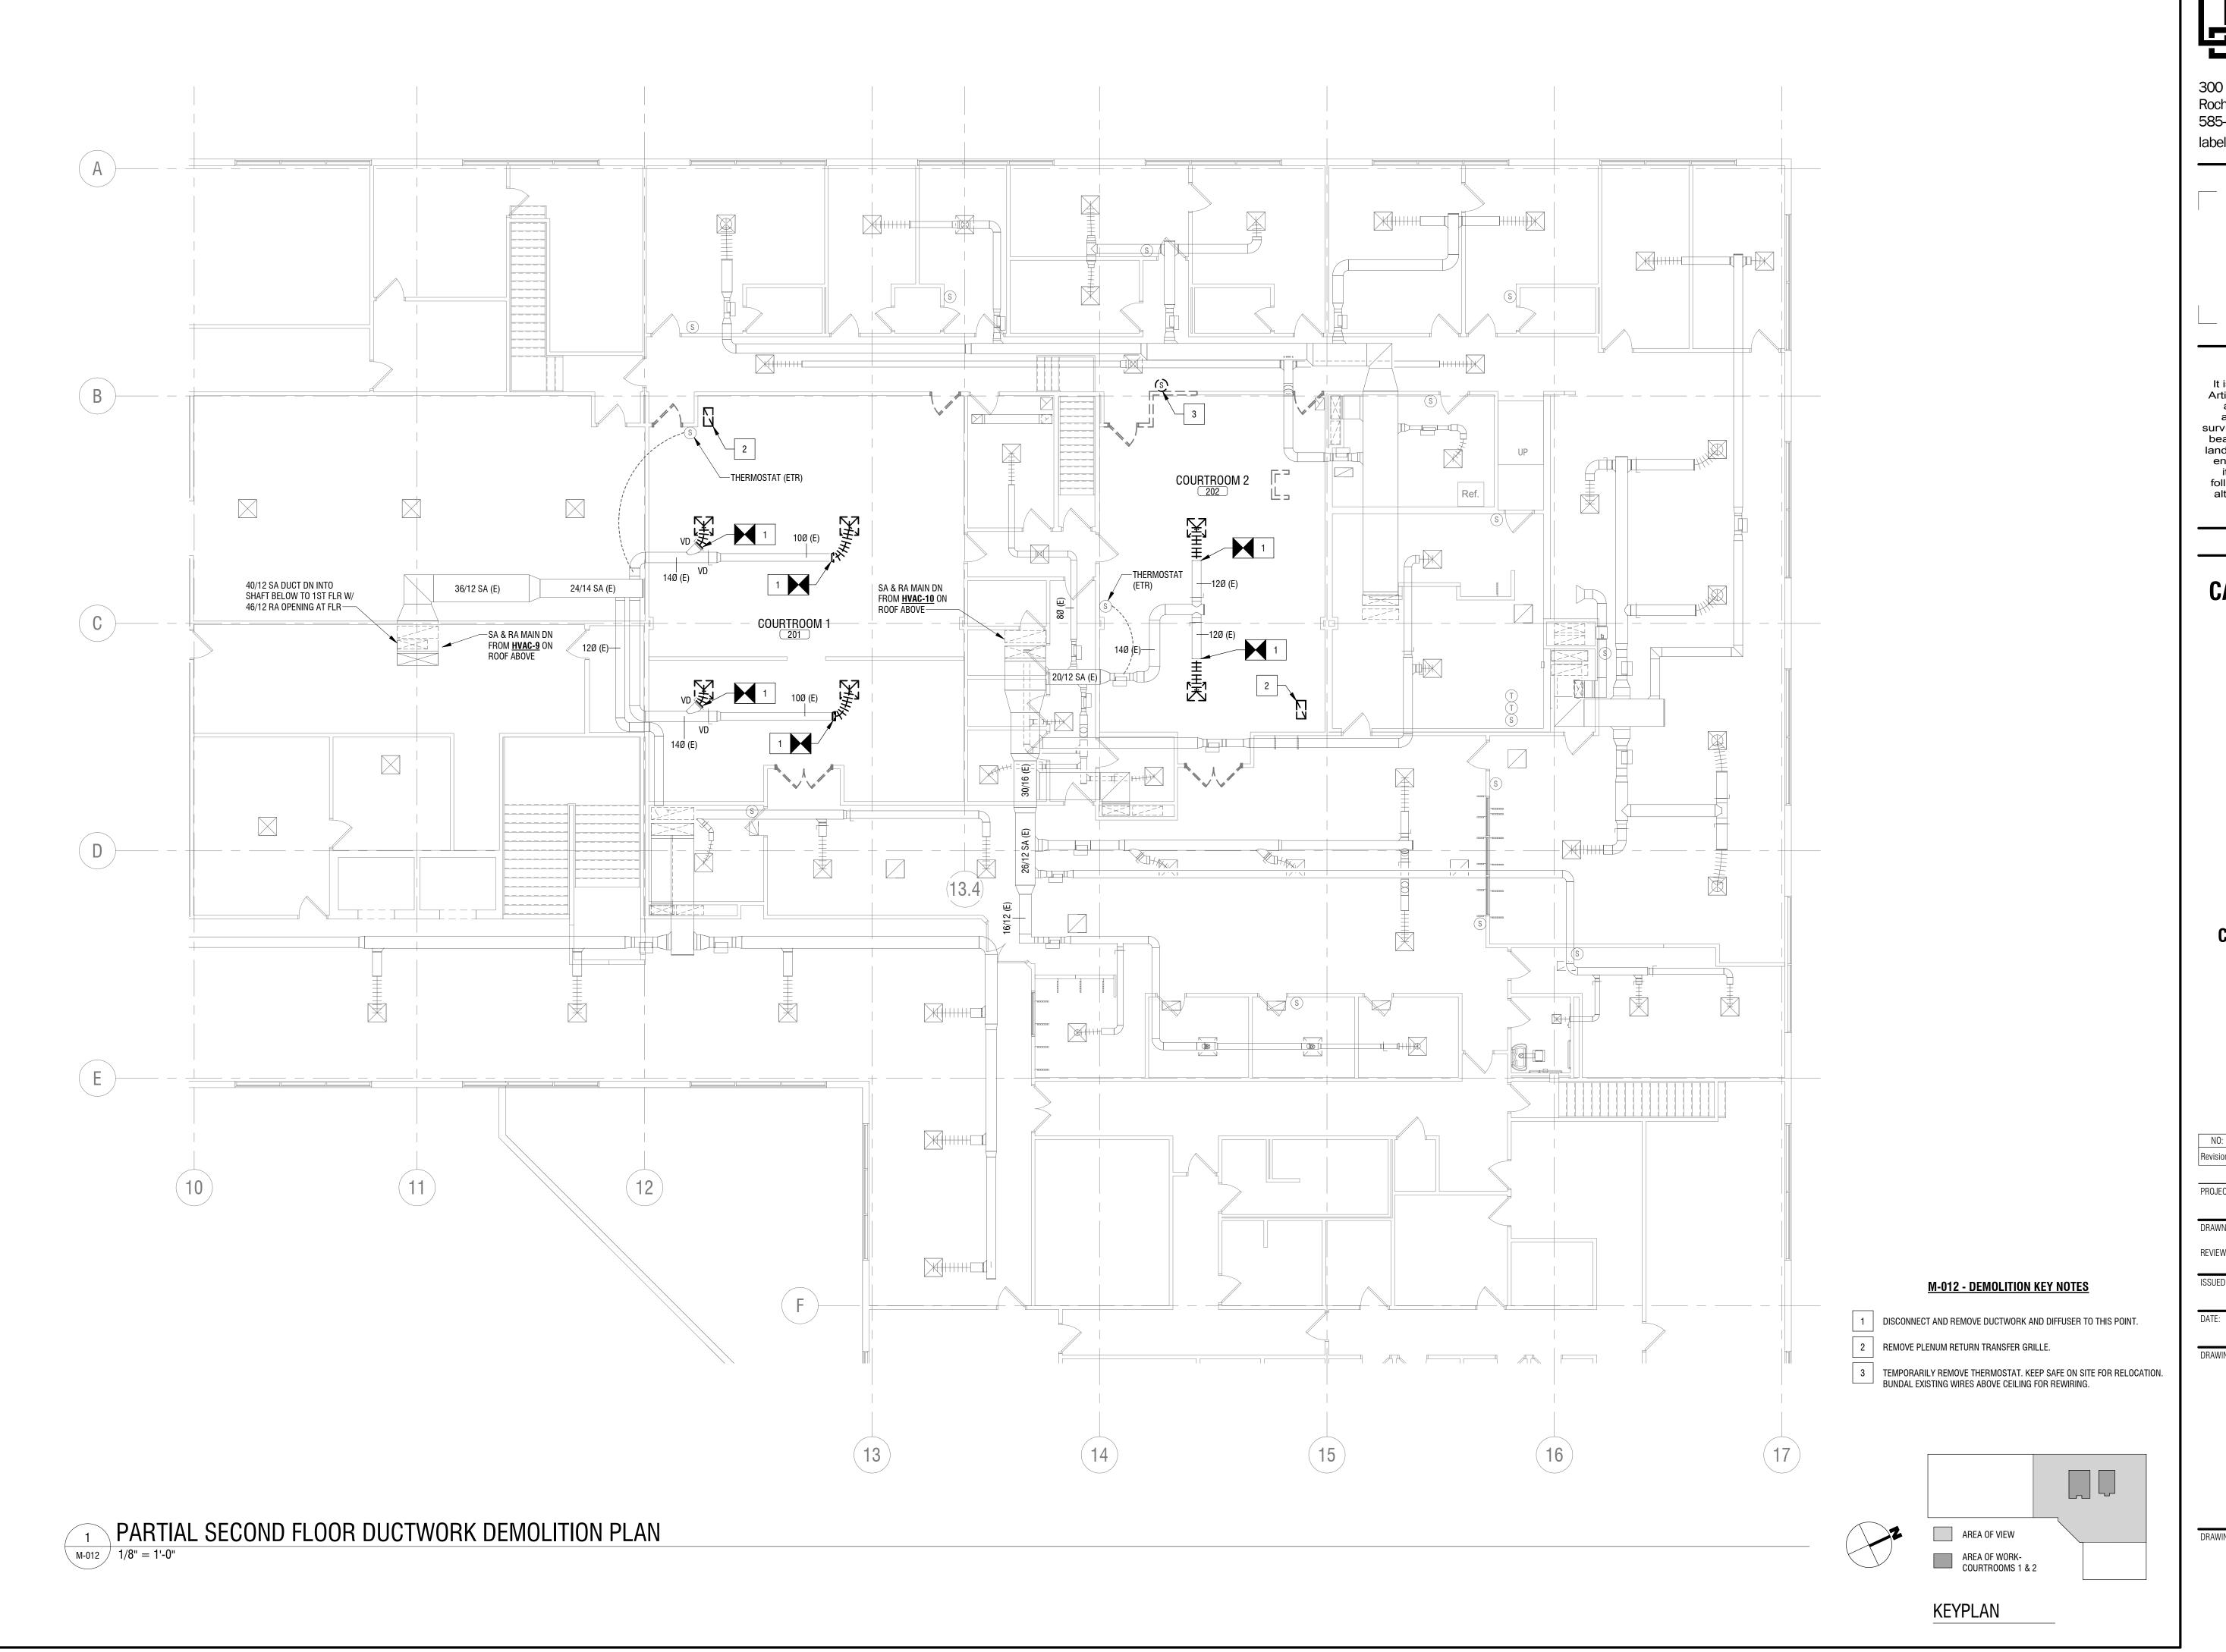

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CATTARAUGUS COUNTY DEPARTMENT OF PUBLIC WORKS

alteration.

COUNTY COURT COURTROOM **RENOVATIONS**

1 LEO MOSS DRIVE OLEAN, NEW YORK 14760

NO: DATE: DESCRIPTION: PROJECT NUMBER: 2180593.01 DRAWN BY: ZAZ REVIEWED BY:


MARCH 25, 2019

DRAWING NAME:

SECOND FLOOR **DUCTWORK DEMOLITION PLAN**

DRAWING NUMBER:

M-012

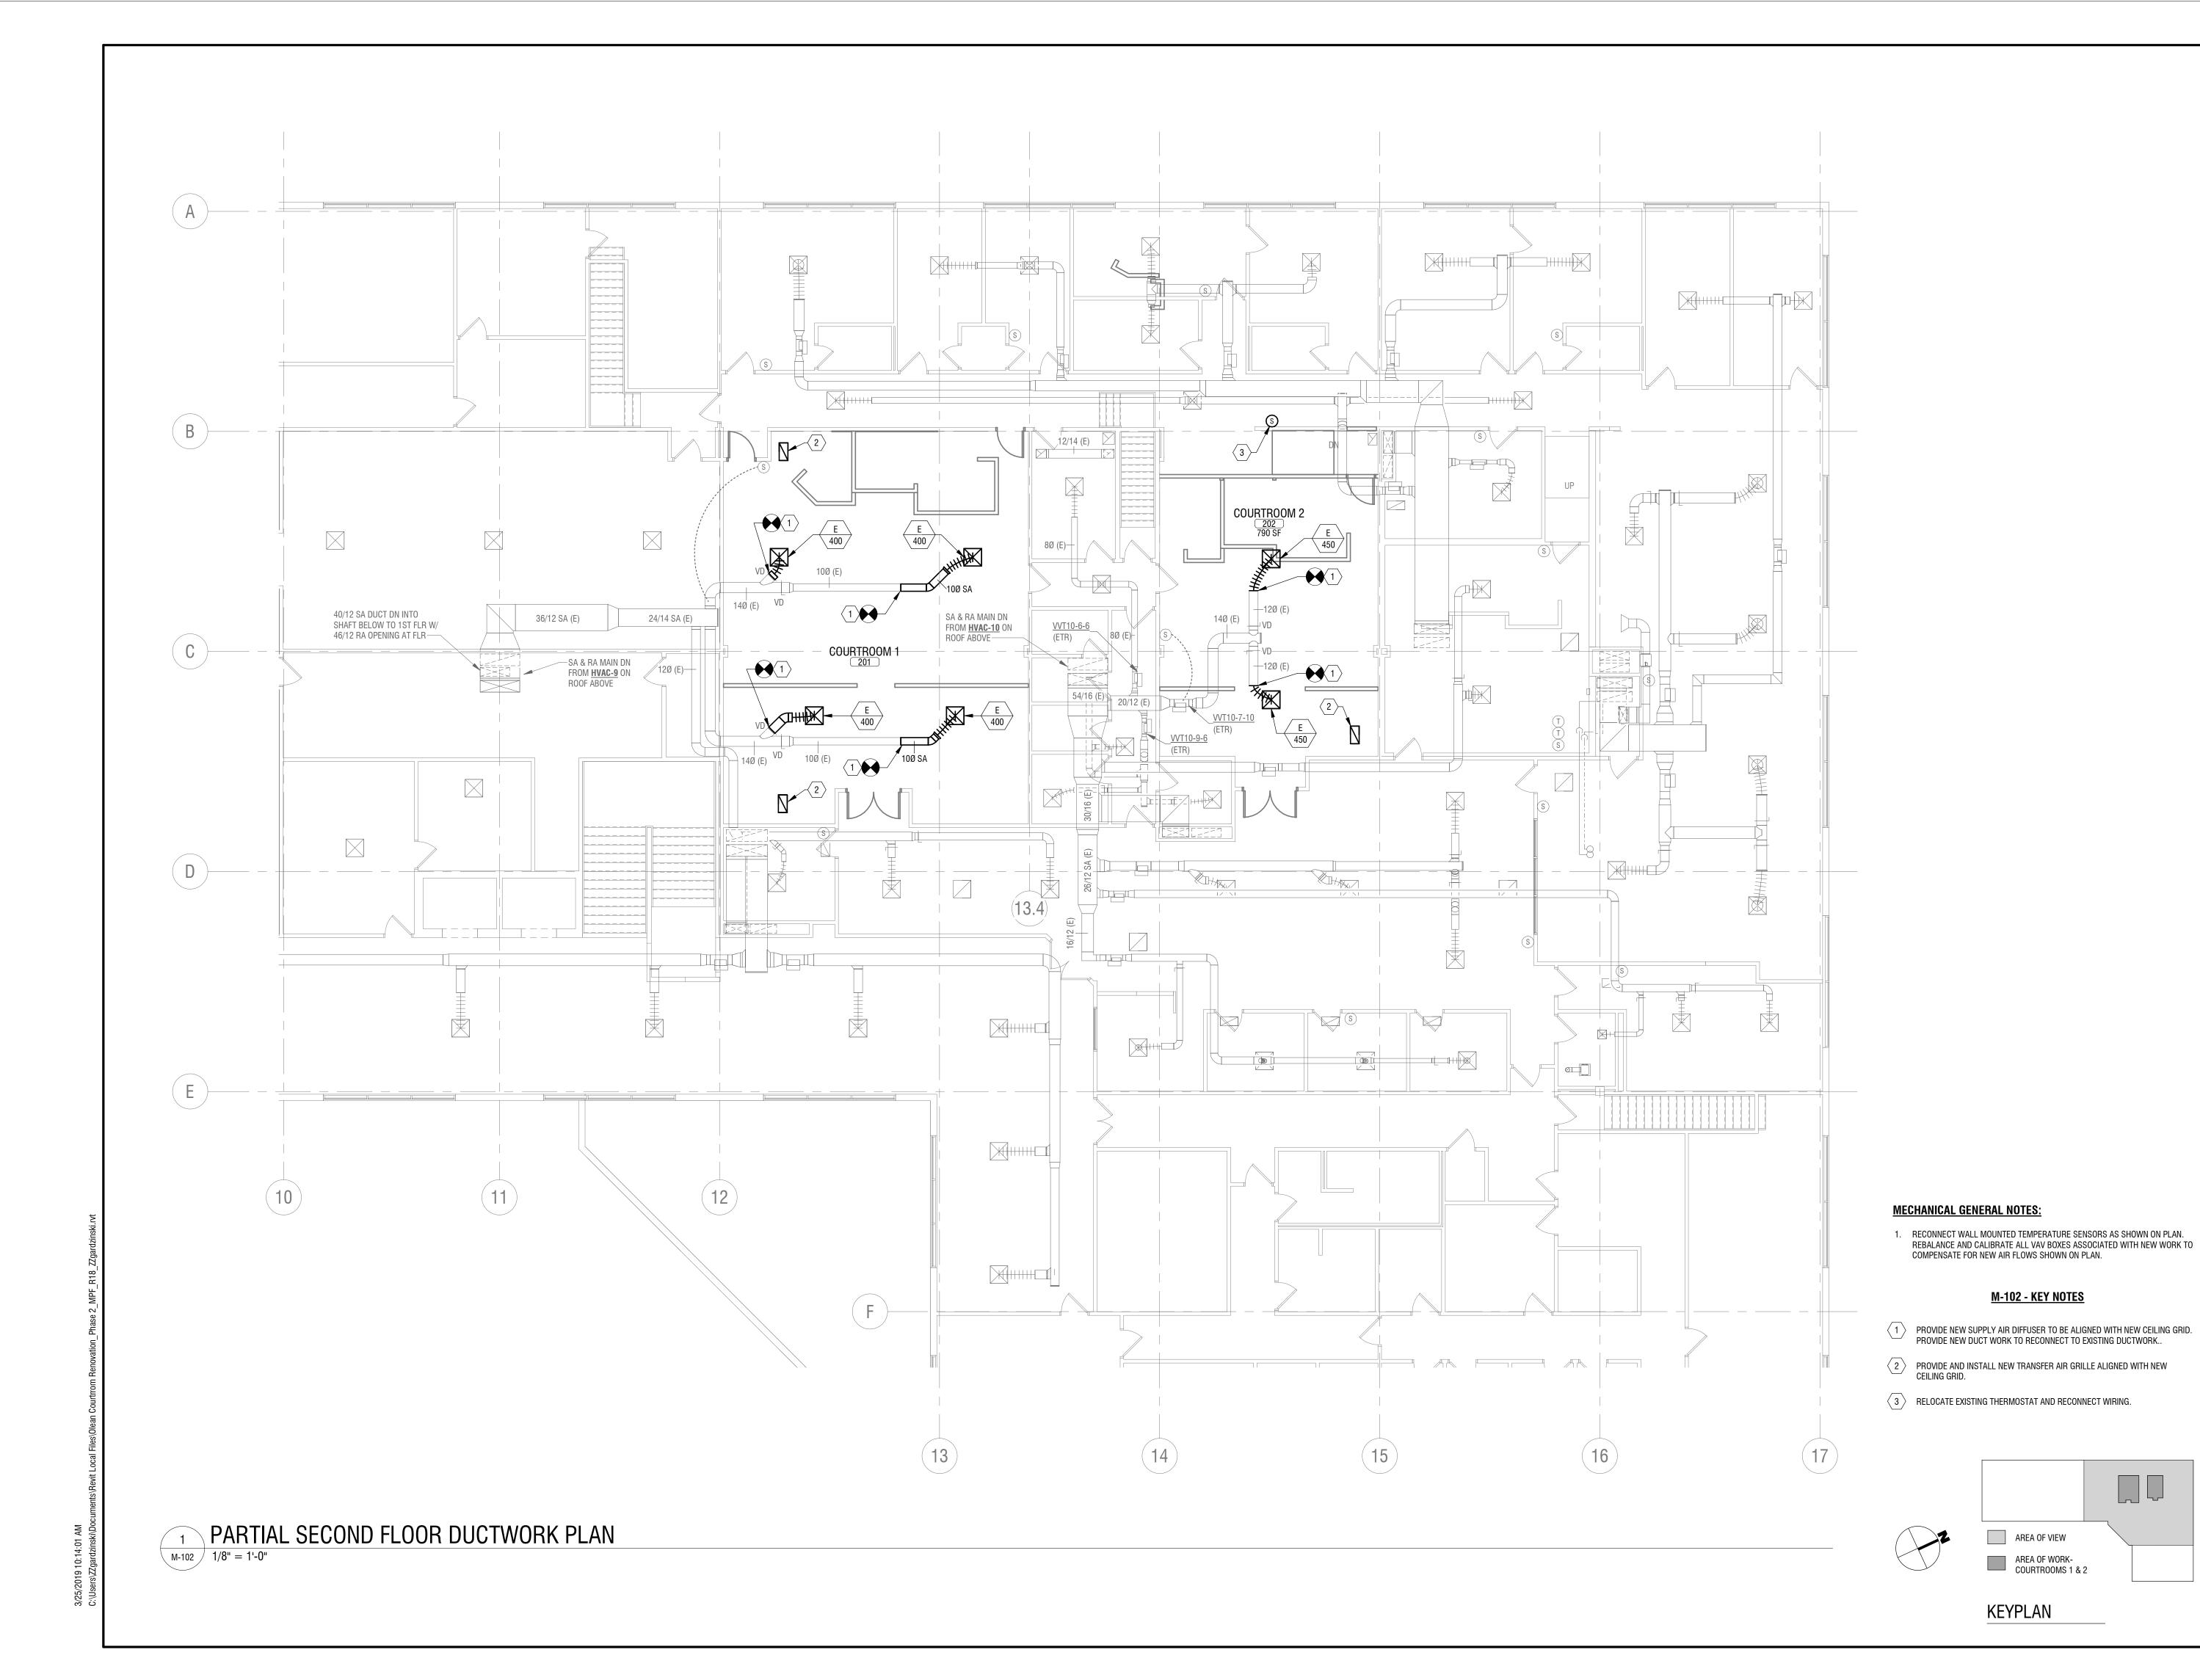



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alteration, and a specific description of the

CATTARAUGUS COUNTY DEPARTMENT OF PUBLIC WORKS

alteration.

COUNTY COURT COURTROOM RENOVATIONS

1 LEO MOSS DRIVE OLEAN, NEW YORK 14760

NO:	DATE:	DESCRIPTION:
Revisions		
PROJECT I	NUMBER:	2180593.01
DRAWN BY	Y :	ZAZ
REVIEWED	BY:	EJL
ISSUED FO	DR:	BID
DATE:		MARCH 25, 2019

SECOND FLOOR DUCTWORK PLAN


DRAWING NUMBER:

DRAWING NAME:

M-102

DIFFUSER SCHEDULE MOUNTING FINISH DESCRIPTION MANUFACTURER FACE SIZE MATERIAL DAMPER USE MODEL NOTES 12" Ø 24"x24" STEEL NONE LAY-IN WHITE SUPPLY ADJ. LOUVERS KRUEGER 1400A

				RI	EGISTER AND G	RILLE SCHEDU	LE				
No.	NECK SIZE	FACE SIZE	MATERIAL	DAMPER	MOUNTING	FINISH	USE	DESCRIPTION	MANUFACTURER	MODEL	NOTES
1	22"x10"	24"x12"	ALUMINUM	NONE	LAY-IN	WHITE	RETURN	TRANSFER GRILLE	TITUS	50F	

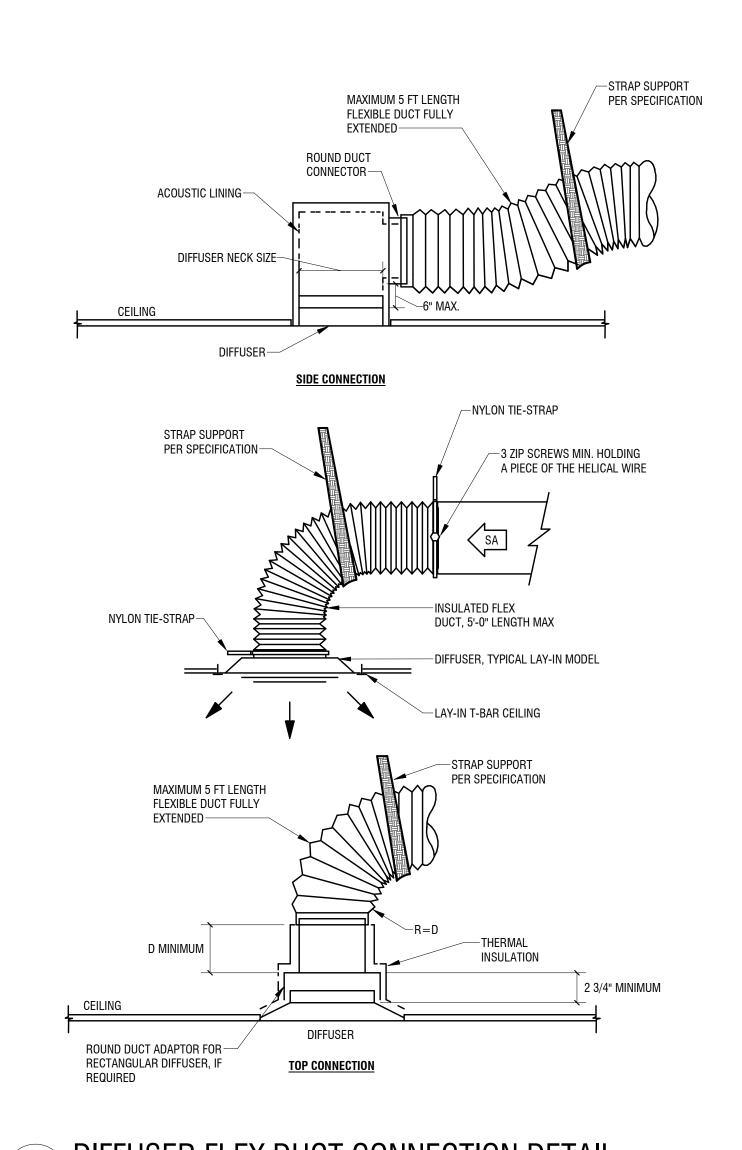

1 DIFFUSER FLEX DUCT CONNECTION DETAIL
M-501 N.T.S.



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CATTARAUGUS COUNTY DEPARTMENT OF PUBLIC WORKS

COUNTY COURT COURTROOM RENOVATIONS

1 LEO MOSS DRIVE OLEAN, NEW YORK 14760

NO:	DATE:	DESCRIPTION:
Revisions		
PROJECT NI	JMBER:	2180593.01
DRAWN BY:		ZAZ
REVIEWED E	BY:	EJL
ISSUED FOR	?:	BID
DATE:		MARCH 25, 2019

MECHANICAL DETAILS AND SCHEDULES

DRAWING NUMBER:

DRAWING NAME:

M-501

s/z3/z019 10:14:02 AWI C:\Users\ZZgardzinski\Documents\Revit Local Files\Olean Courtrrom Renovation_Phase 2_M

ELECTRICAL LEGEND **ELECTRICAL GENERAL NOTES PANELBOARDS** FOR EXACT LOCATIONS AND SURFACE FINISH CONDITIONS OF CEILINGS, WALLS, OR FLOORS, REFER TO ARCHITECTURAL DRAWINGS. PANELBOARD - ONE-LINE NOTATION: REFER TO HAZARDOUS MATERIALS DRAWINGS FOR LOCATIONS OF HAZARDOUS OR POSSIBLE HAZARDOUS MATERIALS BEFORE PERFORMING ANY WORK ON EXISTING STRUCTURES. —208/120V OR 240V SYSTEM -480/277V SYSTEM FOR EXACT LOCATION OF FACILITY EXPANSION JOINTS, FIRE RATED WALLS, AND SMOKE WALLS, REFER TO ARCHITECTURAL DRAWINGS. FOR EXACT LOCATIONS OF DUCT MOUNTED SMOKE DETECTORS, WATER FLOW SWITCHES, AND TAMPER SWITCHES REFER TO HVAC / FP SHADING INDICATES BRANCH TYPE <u> MCB</u> - TEXT INDICATES LUG/ BREAKER TYPE FEEDER BREAKERS (BRANCH BREAKERS SHOWN ON EACH PANELBOARD SCHEDULE) 150A-3P VERIFY EXACT LOCATION OF CONNECTION POINTS PRIOR TO ROUGH-IN COORDINATE LOCATIONS OF ALL RECEPTACLES AND LUMINAIRES IN MECHANICAL SPACES WITH HVAC CONTRACTOR PRIOR TO ROUGH-IN TO AVOID CONFLICTS WITH EQUIPMENT AND DUCTWORK. MOUNTING HEIGHTS ARE TO CENTER OF DEVICE OR EQUIPMENT UNLESS NOTED OTHERWISE, EXCEPT FOR PENDANT LIGHTING WHICH ARE PANELBOARD - FLOOR PLAN NOTATION: TO THE BOTTOM OF THE LUMINAIRE. FOR AREAS WITH DIFFERENT FLOOR LEVELS. HEIGHT IS BASED UPON CLOSEST FLOOR OR LANDING TO DEVICE, EQUIPMENT, OR LUMINAIRE. ELEVATIONS GIVEN ON LEGEND SHEET ARE UNLESS NOTED OTHERWISE ON DRAWINGS. **DOOR STYLE (DESIGNATES VOLTAGE):** PROVIDE RACEWAY, WIRE AND CABLE, ASSOCIATED FITTINGS AND CONNECTORS, AND COMPLETE CONNECTIONS REQUIRED FOR DESIGNATED BRANCH CIRCUITS FROM DEVICE(S) TO FINAL OVERCURRENT DEVICE AND TO LOCAL CONTROL DEVICE(S) PER 208/120V OR 240V SYSTEM 480/277V SYSTEM MINIMUM BRANCH CIRCUIT WIRE SIZE SHALL BE #12 AWG [EXCEPT LIFE SAFETY/EMERGENCY BRANCH CIRCUIT WIRING WHICH SHALL BE MINIMUM #10 AWG]. SIZE BRANCH CIRCUIT CONDUCTORS AS PER NEC AND AS SCHEDULED ON THIS DRAWING BASED ON ACTUAL CIRCUIT DISTANCE. INCLUDE GROUND CONDUCTOR DERATINGS. SIZE (DESIGNATES PANELBOARD TYPE) PULL A SEPARATE NEUTRAL CONDUCTOR FOR ALL BRANCH CIRCUITS REQUIRING A NEUTRAL CONNECTION. DERATE CONDUCTORS PER PANELBOARD NEC ACCORDINGLY. MULTIWIRE BRANCH CIRCUITS ARE NOT ACCEPTABLE. DISTRIBUTION PANELBOARD PROVIDE GROUNDING PER NEC & TIA 607B. PROVIDE GREEN GROUND CONDUCTOR IN ALL BRANCH AND FEEDER CIRCUITS. DO NOT INSTALL ANY NEW WORK DIRECTLY ABOVE ANY ELECTRICAL PANELS, SWITCHBOARDS, SWITCHGEAR, OR TRANSFORMERS **DATA/TELECOMMUNICATION OUTLETS** CIRCUIT NUMBERS SHOWN FOR EQUIPMENT TO BE CONNECTED TO EXISTING PANELBOARD(S) IS SHOWN FOR DESIGN INTENT ONLY AND MAY NOT CORRESPOND TO ACTUAL CIRCUIT BREAKER MOUNTING POSITION IN THE PANEL. UPDATE THE RECORD DRAWINGS & PANELBOARD DIRECTORY WITH THE ACTUAL CIRCUIT NUMBERS USED TO CORRESPOND TO THE PANEL DIRECTORY. NOTE: PROVIDE 1-1/2" CONDUIT FROM BOX STUBBED INTO ACCESSIBLE CEILING SPACE IN NEAREST CORRIDOR, REFER TO DATA/TELECOMMUNICATION OUTLET SCHEDULE FOR ADDITIONAL DETAILS. CONFIRM ALL LABELS AND ROOM NUMBERS WITH OWNER PRIOR TO FINALIZING LABELING AND PROGRAMMING. DATA/TELECOMMUNICATIONS OUTLET FOR OCA NETWORK, 18" AFF UNLESS OTHERWISE NOTED, PROVIDE (1) BLUE OUTLET/JACK COORDINATE FINAL OUTLET LOCATION WITH ALL TRADES AND FURNITURE/MILLWORK PLACEMENT PRIOR TO ROUGH-IN. GENERAL AND ASSOCIATED CAT 6 CABLE. WHERE DENOTED WITH "#D": PROVIDE MULTIPLE OUTLETS/JACKS WITHIN SAME FACEPLATE AND CONTRACTOR SHALL PROVIDE ALL DRILLING AND GROMMETING IN FURNITURE/CASEWORK FOR CORD ACCESS IF REQUIRED. MULTIPLE CAT 6 CABLES WITHIN SAME BOX. # INDICATES QUANTITY. REFER TO SHEET **E50X** FOR DETAILS SHOWING PLACEMENT OF DEVICES INSTALLED AT DOORWAYS DATA/TELECOMMUNICATIONS OUTLET FOR COUNTY NETWORK, 18" AFF UNLESS OTHERWISE NOTED, PROVIDE (1) ORANGE OUTLET/JACK AND ASSOCIATED CAT 6 CABLE. WHERE DENOTED WITH "#C"; PROVIDE MULTIPLE OUTLETS/JACKS WITHIN SAME INSTALL DATA OUTLETS 6" ADJACENT TO ASSOCIATED ELECTRICAL OUTLET. FACEPLATE AND MULTIPLE CAT 6 CABLES WITHIN SAME BOX. # INDICATES QUANTITY. SWITCHES SHOWN SIDE BY SIDE OR GANGED SHALL BE INSTALLED UNDER A COMMON COVERPLATE, UNLESS NOTED OTHERWISE. DATA/TELECOMMUNICATIONS OUTLET INSTALLED IN FLOORBOX / DEVICE, WITH CONDUIT ROUGH-IN IN SLAB TO ACCESSIBLE CEILING. PROVIDE FIRESTOPPING AT ALL PENETRATIONS THROUGH FIRE RATED WALLS, FLOORS, CEILINGS, & ROOFS AS CALLED OUT ON WIRELESS ACCESS POINT. PROVIDE (2) CAT 6 TO LOCATION INDICATED, TERMINATE AND COIL UP 15' OF SPARE CABLE ABOVE ARCHITECTURAL PLANS. PROVIDE ACOUSTICAL SEALANT AT PENETRATIONS THROUGH ALL NON-FIRE RATED WALLS, FLOORS, & CEILINGS. PROVIDE CONDUIT EXPANSION JOINTS AT ALL EXPANSION JOINTS AS CALLED OUT ON ARCHITECTURAL PLANS. SECURITY DEVICES & ACCESS CONTROL SITE PLAN CONDUIT ROUTING SHOWN FOR INTENT. REFERENCE CIVIL DRAWINGS FOR UNDERGROUND COORDINATION AND DISTANCE OF DURESS BUTTON, MOUNT 3'-0" AFF OR UNDERSIDE OF DESK RUNS. COORDINATE WITH ALL TRADES. FINAL QUANTITY AND LOCATION OF WIRELESS DATA OUTLETS IDENTIFIED ON THE FLOOR PLANS SHALL BE VERIFIED WITH THE WIRELESS ACCESS POINT MANUFACTURER BASED ON THE MODEL NUMBER UTILIZED PRIOR TO INSTALLATION/ROUGH-IN. **COMMUNICATION DEVICES ELECTRICAL DEMOLITION GENERAL NOTES** SPEAKER, FLUSH CEILING MOUNTED REMOVE ALL ELECTRICAL EQUIPMENT ON OR IN EXISTING WALLS, CEILINGS AND PARTITIONS WHICH ARE TO BE DEMOLISHED. WHERE MICROPHONE JACK, 18" AFF EQUIPMENT IS SCHEDULED TO BE REMOVED, ABANDON CONCEALED RACEWAY AND REMOVE CONDUCTORS BACK TO SOURCE OR LAST SCHEDULED DEVICE TO REMAIN. REMOVE EXPOSED RACEWAY AND CONDUCTORS BACK TO POWER SOURCE OR LAST DEVICE SCHEDULED. TO REMAIN IN ALL OTHER AREAS. FIRE ALARM, GAS DETECTION, & MASS NOTIFICATION DEVICES WHERE EXISTING WALLS ARE TO REMAIN, REMOVE ALL EXPOSED RACEWAYS, SURFACE AND RECESSED OUTLET BOXES, ETC. WHICH ARE NOT TO BE REUSED. WHERE NEW CONDUITS AND OUTLETS ARE TO BE ADDED TO EXISTING WALLS IN FINISHED ROOMS, THEY SHALL BE HEAT DETECTOR, COMBINATION RATE OF RISE/FIXED 135°F, CEILING MOUNT ('R' INDICATES RATE OF RISE TEMPERATURE SENSOR. CONCEALED BY CUTTING AND PATCHING THE WALLS UNLESS OTHERWISE NOTED. 'F' INDICATES FIXED TEMPERATURE SENSOR, 'R/F' INDICATES COMBINATION RATE OF RISE & FIXED TEMPERATURE SENSOR) UTILIZE EXISTING OUTLET BOXES AND RACEWAY SYSTEMS WHEREVER PRACTICAL IN RENOVATION AREAS. WHERE SUCH EXISTING SMOKE DETECTOR, CEILING MOUNTED OUTLET BOXES ARE USED, INSTALL NEW WIRING DEVICES, COVERPLATES, AND WIRING. PROVIDE SPECIAL COVERPLATES TO SUIT FIELD FIRE ALARM STROBE LIGHT, WALL MOUNTED, MIN 80"/ MAX 96" AFF (# INDICATES CANDELA RATING) REARRANGE EXISTING CONDUITS AND WIRING TO ACCOMMODATE NEW CIRCUIT ARRANGEMENTS INDICATED AND TO MAINTAIN FIRE ALARM HORN/STROBE[EMERGENCY VOICE/ALARM SPEAKER & STROBE], 90 dB, WALL MOUNTED, MIN 80"/ MAX 96" AFF (# CONTINUITY OF EXISTING CIRCUITS FEEDING DEVICES THAT ARE TO REMAIN. INDICATES CANDELA RATING) CONTRACTOR SHALL BE RESPONSIBLE TO REMOVE AND REINSTALL EXISTING ELECTRICAL EQUIPMENT TO ACCOMMODATE THE WORK OF FIRE ALARM MANUAL PULL STATION, 44" AFF UNLESS NOTED OTHERWISE OR DISTURBED BY ALL TRADES **ELECTRICAL DEVICES** STORE REMOVED ELECTRICAL EQUIPMENT SUCH AS LUMINAIRES, POWER AND COMMUNICATION DEVICES, DISTRIBUTION EQUIPMENT, CONTROLLERS, ETC. ON JOB SITE FOR REUSE UNTIL SUBSTANTIAL COMPLETION OR PROJECT CLOSEOUT. PROVIDE OWNER RIGHT OF FIRST REFUSAL OF ELECTRICAL EQUIPMENT OTHERWISE REMOVE THOSE FROM SITE AT CONTRACTORS EXPENSE IN ACCORDANCE WITH GENERAL ELECTRICAL DEVICE NOTATION: APPLICABLE LAWS AND REGULATIONS THAT THE OWNER DOES NOT WISH TO SALVAGE. EXISTING DEVICE LOCATIONS WERE IDENTIFIED AS COMPLETELY AS POSSIBLE BY A SITE SURVEY AND BY RECORD DOCUMENTS AS INSTALLATION HEIGHT TO CENTER OF DEVICE IN INCHES (IF OTHER TIME OF DEVICE IN AVAILABLE. BE RESPONSIBLE FOR PROPER DEMOLITION AND REWORK OF DEVICES NOT SHOWN ON DRAWINGS BUT NECESSARY FOR NOTED ON SHEET/CIRCUIT BOUNDARY) PROJECT RENOVATIONS TO CONFORM WITH INTENT OF DOCUMENTS. VISIT THE SITE TO DETERMINE THE EXACT EXTENT OF FI FCTRICAL DEMOLITION WORK REQUIRED TO COMPLETE THE NEW CONSTRUCTION. CONTRACTOR SHALL PROVIDE IN BASE BID A NOMINAL AMOUNT SUBSCRIPT (IF APPLICABLE) OF UNKNOWN BRANCH CIRCUITS, FIXTURES, DEVICES, AND SYSTEMS WIRING BEING REMOVED OR RELOCATED FOR NEW WORK. WHERE DEMOLITION OF DEVICE OR EQUIPMENT AND REMOVAL OF CONDUIT OR OTHER ACCESSORY LEAVES OPENINGS IN THE FLOORS, NEMA 5-20R SIMPLEX RECEPTACLE, 18" AFF WALLS, OR CEILINGS, SAME SHALL BE PATCHED AND PAINTED TO MATCH EXISTING ADJACENT FINISH. ALL OPENINGS IN FLOORS SHALL NEMA 5-20R SIMPLEX RECEPTACLE, INSTALLED FLUSH IN CEILING REFER TO DEMOLITION DRAWINGS & NOTES OF ALL CONTRACTS OR TRADES FOR COORDINATION NEMA 5-20R DUPLEX RECEPTACLE, 18" AFF IN AREAS OF DEMOLITION WHERE THE REMOVAL OF ELECTRICAL EQUIPMENT INTERFERES WITH THE NORMAL BUILDING OPERATIONS AND NEMA 5-20R DUPLEX RECEPTACLE, INSTALLED FLUSH IN CEILING SYSTEMS, CONSULT WITH THE OWNER PRIOR TO PERFORMING ANY DEMOLITION. NEMA 5-20R GFCI DUPLEX RECEPTACLE, 18" AFF WHERE UNFORESEEN CONDITIONS CONFLICT WITH CONTRACT DOCUMENTS, SUBMIT AN RFI PRIOR TO PROCEEDING WITH ANY WORK NEMA 5-20R QUADPLEX (DOUBLE DUPLEX) RECEPTACLE, 18" AFF WHERE DEVICES ARE SCHEDULED FOR RELOCATION, DISCONNECT AND REMOVE EXISTING DEVICE AND REMOVE ASSOCIATED WIRING. RELOCATE DEVICE AS SHOWN, EXTEND WIRING AS REQUIRED, AND MATCH EXISTING. LIGHTING CONTROL DEVICES WHERE REMOVALS AFFECT EXISTING CIRCUITS SCHEDULED TO REMAIN, MAINTAIN CONTINUITY OF POWER TO THESE CIRCUITS AND EXTEND WIRING AS NEEDED. NOTE: LIGHTING CONTROL DEVICES SHOW FUNCTIONAL REQUIREMENTS, NOT ALL DEVICES NEEDED FOR A FULLY FUNCTIONING WHERE ANY EMPTY BACKBOXES OR EMPTY JUNCTION BOXES REMAIN DUE TO ELECTRICAL DEMOLITION, PROVIDE COVERPLATE(S) OVER SYSTEM. DEPENDING ON CONFIGURATION AND MANUFACTURER, DEVICES SUCH AS POWER PACKS, RELAYS, SINGLE/DOUBLE/TRIPLE OUTPUT ROOM CONTROLLERS MAY BE NECESSARY. REFER TO DETAILS & SPECIFICATIONS. WHERE EQUIPMENT CONNECTIONS ARE SHOWN, REMOVE ELECTRICAL CONNECTION, CONDUIT AND WIRE BACK TO POWER SOURCE. SINGLE POLE TOGGLE SWITCH, 44" AFF DISCONNECT AND REMOVE ASSOCIATED CONTROLLER SERVING EQUIPMENT AND ASSOCIATED CONTROL WIRING. 3-WAY TOGGLE SWITCH, 44" AFF DISCONNECT AND REMOVE EXISTING ELECTRIC WORK NOT NECESSARY FOR EXISTING OR NEW INSTALLATION, BUT INTERFERING WITH NEW CONSTRUCTION. DIMMING SWITCH, SINGLE OR MULTIPLE LOCATION FUNCTIONALITY AS SHOWN, LOW VOLTAGE 0-10V WITH ON-OFF, 44" AFF DISCONNECT, REMOVE, RELOCATE, AND RECONNECT ANY AND ALL EXISTING ELECTRIC WORK REQUIRED TO REMAIN, BUT INTERFERING RACEWAY, BOXES, & BUSWAY WHERE DEMOLITION NOTES SCHEDULE EXISTING WIRING DEVICES, LIGHTING FIXTURES, SYSTEMS DEVICES, EQUIPMENT CONNECTIONS, JUNCTION BOX, HEIGHT AS INDICATED ETC. TO BE "DISCONNECTED AND REMOVED IN THE ENTIRETY", THE CONTRACTOR SHALL DISCONNECT AND REMOVE THE EXISTING LIGHTING FIXTURE, WIRING DEVICES, COVERPLATES, BRANCH CIRCUIT WIRING, CONDUIT OR RACEWAY, OUTLET AND/OR SPLICE BOX(ES) MULTISERVICE BOX, 6" FIRE RATED POKE-THRU. PROVIDE DEVICES INDICATED IN FLOOR PLANS. ETC. BACK TO EITHER LAST DEVICE SCHEDULED TO REMAIN, OR BACK TO POWER SOURCE. DESIGN BASE: HUBBELL SYSTEM-ONE WITH BRUSHED ALUMINUM COVER. PROPERLY DISPOSE OF ALL PCB CONTAINING FLUORESCENT BALLASTS MANUFACTURED PRIOR TO 1980 ACCORDING TO STATE AND CABINETS / RACKS

OPEN FRAME DATA RACK - FLOOR MOUNTED (BOLD LINE INDICATES FRONT OF RACK, CABLE MANAGEMENT SPACE SHOWN)

FEDERAL REGULATIONS.

IF ADDITIONAL SUSPECT ASBESTOS-CONTAINING MATERIALS ARE DISCOVERED DURING THE COURSE OF THE WORK, THE CONTRACTOR

THE OWNER AND ARCHITECT TO WITH REGARD TO CONDUCTING ADDITIONAL BULK SAMPLING AND ABATEMENT AT THE OWNER'S

DISCONNECT AND REMOVE RECEPTACLES, LIGHTING, & ABANDONED DEVICES & RACEWAY, UNLESS NOTED OTHERWISE.

SHALL IMMEDIATELY STOP WORK AND NOTIFY THE OWNER AND ARCHITECT IMMEDIATELY. THE CONTRACTOR SHALL COOPERATE WITH

DEVICE SUBSCRIPTS ROMAN NUMERAL INDICATES QUANTITY OF GANGED DEVICES UNDER COMMON FACEPLATE HEIGHT OF DEVICE ABOVE FINISHED FLOOR (IN INCHES) LOWER CASE LETTER(S) INDICATES SWITCH CONTROL ARRANGEMENT NUMERAL INDICATES BRANCH CIRCUIT NUMBER (POWER & LIGHTING)/CANDELA RATING (FIRE ALARM DEVICES) WITH AUXILIARY CONTACTS INSTALL ABOVE COUNTER, AT 40" AFF. COORDINATE WITH GC REMOVE DEVICE AND INSTALL BLANK COVERPLATE BLANKFACE GFCI CORD DROP RECEPTACL **CLOCK HANGER RECEPTACLE** INSTALL FLUSH IN CEILING INSTALL ON SURFACE OF CEILING CONTROL POINT IDENTIFIER (* INDICATES CONTROL NUMBER) RECEPTACLE FOR COPIER . INSTALL 18" AFF RECEPTACLE FOR COFFEE, INSTALL 44" AFF DIMMER SWITCH (LIGHTING CONTROL) EXISTING BACKBOX TO REMAIN AND BE REUSED EXISTING BACKBOX WITH NEW DEVICE **FQUIPMENT SUPPLIED BY OWNER** INSTALL IN EQUIPMENT/CASEWORK EXISTING TO BE REMOVED FXISTING TO REMAIN RECEPTACLE FOR WATER COOLER. COORDINATE EXACT LOCATION WITH GC & PC PRIOR TO ROUGH-IN EXPLOSION PROOF INSTALL FLUSH IN FLOOR INSTALL IN FLOORBOX/POKETHRU FIRE RATED ASSEMBLY GROUND FAULT CIRCUIT INTERRUPTING RECEPTACLE GROUND FAULT CIRCUIT INTERRUPTING BREAKER PROTECTED FEED THROUGH GROUND FAULT CIRCUIT INTERRUPTING PROTECTED INSTALL HORIZONTALLY HIGH ABUSE COVERPLATE WITH CENTER PIT REJECT SCREWS ISOLATED GROUND RECEPTACLE KFY OPFRATED LOCATOR STYLE TOGGLE SWITCH (PILOT LIGHT 'ON' WHILE DEVICE IS OFF OR UNPOWERED) LOW VOLTAGE MONITORING POINT IDENTIFIER (* INDICATES MONITORING POINT NUMBER) RECEPTACLE FOR MICROWAVE, INSTALL IN UPPER CABINET, COORDINATE EXACT LOCATION WITH GC PRIOR TO ROUGH-IN INDICATES NEW DEVICE NOT IN CONTRACT/PROVIDE BY OTHERS NIGHT LIGHT LUMINAIRE (UNSWITCHED / INTEGRAL NIGHT LIGHT STYLE RECEPTACLE INTEGRAL NIGHT LIGHT STYLE GFCI RECEPTACLE OCCUPANCY SENSOR (AUTOMATIC 'ON' LIGHTING SENSOR SWITCH) PILOT STYLE TOGGLE SWITCH (PILOT LIGHT 'ON' WHILE DEVICE IS ON OR POWERED) FOR PHONE, INSTALL 54" AFF POWER INDICATING RECEPTACI F RECEPTACLE FOR PROJECTOR, INSTALL FLUSH IN CEILING BACKBOX FOR AUTODOOR PUSH PLATE RELAY DESIGNATION (* INDICATES RELAY NUMBER RECEPTACLE FOR REFRIGERATOR, INSTALL 44" AFF INSTALL ON SURFACE SURGE PROTECTOR STYLE RECEPTACLE INSTALL IN SURFACE RACEWAY SPLIT WIRED RECEPTACLE FOR REMOTE SWITCHING DIGITAL ELECTRONIC INTERVAL TIMER (LIGHTING SWITCH) TAMPER RESISTANT DIGITAL ELECTRONIC PROGRAMMABLE TIME SWITCH (LIGHTING SWITCH) FOR TELEVISION/MONITOR, INSTALL 72" AFF INSTALL UNDER COUNTER. COORDINATE EXACT LOCATION WITH GC PRIOR TO ROUGH-IN RECEPTACLE WITH USB CHARGING PORTS RECEPTACLE FOR VENDING MACHINE, INSTALL 44" AFF VACANCY SENSOR (MANUAL 'ON' LIGHTING SENSOR SWITCH) INSTALL 44" AFF WIRE GUARD WEATHERPROOF DEVICE / WEATHERPROOF WHILE-IN-USE EXTRA DUTY COVER & WEATHER RESISTANT RECEPTACLE WEATHERPROOF SPRING LOADED COVER (WEATHERPROOF WHEN CLOSED), WEATHER RESISTANT RECEPTACLE WEATHER RESISTANT DEVICE/WEATHER RESISTANT RECEPTACLE DEVICE ZONE IDENTIFIER (* INDICATES ZONE NUMBER) **GENERAL LINEWORK DESCRIPTIONS & DRAWINGS NOTES** EXISTING WORK / FUTURE PROVISIONS / NOT IN CONTRACT WORK WORK TO BE REMOVED (DEMO PLANS) - DEVICE AND ALL ASSOCIATED — — — — — — — — — — — — ELECTRICAL WORK SHALL BE REMOVED BACK TO THE SOURCE, UNLESS NOTED OTHERWISE / UNDERFLOOR CONDUIT (NEW PLANS) WIRE AND / OR CONDUIT RUN CONTINUED ON REFERENCED DETAIL ■ ■ ■ ■ ■ ■ ■ ■ ■ ■ ■ MATCH LINE REFERENCING CONTINUATION ON OTHER DRAWING →●──●●──●●──●●──●●──● CALLOUT BOUNDARY - DETAIL AND / OR SECTION REFERENCE / SCOPE OF WORK ■ • ■ ■ • ■ • ■ BRANCH CIRCUIT BOUNDARY DRAWING KEYED NOTES BRANCH CIRCUITING NOTES DEMO NOTE / FEEDER IDENTIFICATION # KITCHEN / LAB EQUIPMENT TAG SYMBOL WITH TAIL INDICATES WALL INSTALLATION, HEIGHT AS INDICATED INDICATES MULTIPLE DEVICES OF DIFFERENT TYPES INSTALLED UNDER COMMON COVERPLATE AT ONE LOCATION (DEVICES SHALL BE INSTALLED UNDER A COMMON COVERPLATE) BRANCH CIRCUIT CONDUCTOR SIZING CIRCUIT NOTATION: 11,13 ———CIRCUIT NUMBER(S) TLNL1 ——SOURCE PANELBOARD (IF OTHER THAN NOTED ON SHEET/CIRCUIT BOUNDARY) PROVIDE MINIMUM WIRE SIZE AS FOLLOWED UNLESS NOTED OTHERWISE: 20A CB - #12 AWG 30A CB - #10 AWG 40A CB - #8 AWG INCREASE SIZE OF CONDUCTOR FOR DISTANCE AS SHOWN BELOW IN 20A BRANCH CIRCUIT CONDUCTOR SIZING SCHEDULE. 20A BRANCH CIRCUIT CONDUCTOR SIZING SCHEDULE: CONDUCTOR SIZE (AWG) #12 | #10 | #8 | #6 | #4 90 | 140 | 225 | 355 | 565 MAXIMUM BRANCH CIRCUIT LENGTH AT 120V (FEET) 205 325 520 825 1310 MAXIMUM BRANCH CIRCUIT LENGTH AT 277V (FEET) INCREASE ALL BRANCH CIRCUIT CONDUCTORS AS INDICATED BASED ON LENGTH OF CIRCUIT, INCLUDING EQUIPMENT GROUNDING

TRANSITION FROM LARGER CONDUCTOR SIZE TO #12 AWG FOR FINAL TERMINATION TO OUTLET DEVICE. PROVIDE JUNCTION BOX

3. LENGTHS ARE FROM OVERCURRENT PROTECTIVE DEVICE, ALONG CIRCUIT ROUTING, TO CENTER OF EQUIPMENT LOAD.

WITHIN 10' OF OUTLET AND EXTEND #12 AWG CONDUCTORS TO OUTLET.

4. SCHEDULE ASSUMES 12A LOAD, FOR LOADS HIGHER THAN 12A, INCREASE CONDUCTOR SIZE



5 a SWITCHLEG CONTROL ARRANGEMENT

LUMINAIRE SCHEDULE

TAIL INDICATES WALL

PATTERN INDICATES LUMINAIRE CONNECTED TO UNSWITCHED LIGHTING CIRCUIT

GEOMETRIC SHAPE LUMINAIRE, RECESSED OR SURFACE MOUNTED PER LUMINAIRE SCHEDULE

REMOTE LIGHTING LAMP HEAD(S) - CONNECT TO REMOTE BATTERY PACK IN INTERIOR ACCESSIBLE

ILLUMINATED EXIT SIGN - SINGLE/DOUBLE FACE AS SHOWN - DIRECTION OF ARROWS AS

INDICATED - CEILING, SURFACE WALL. OR PERPENDICULAR WALL AS SHOWN

LIGHTING TRACK WITH TRACK MOUNTED LUMINARIES

SELF CONTAINED BATTERY LIGHTING UNIT

MOUNT STYLE LUMINAIRE

-RELAY DESIGNATION (IF APPLICABLE)

-DOTS INDICATE PENDANT HUNG

NOTED ON SHEET/CIRCUIT BOUNDARY)

ARROW INDICATES AIMING DIRECTION (WHERE —

SCHEDULE/LUMINAIRE SCHEDULE

APPLICABLE)

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CATTARAUGUS COUNTY **DEPARTMENT OF PUBLIC WORKS**

LITTLE VALLEY, NEW YORK 14755

COUNTY COURT COURTROOM RENOVATIONS

1 LEO MOSS DRIVE OLEAN, NEW YORK 14760

NO: DATE: DESCRIPTION:

PROJECT NUMBER: 2180593.01 DRAWN BY CSP REVIEWED BY ISSUED FOR:

MARCH 25, 2019

DRAWING NAME

DATE:

ELECTRICAL NOTES SYMBOL LEGEND,

DRAWING NUMBER:



GENERAL DEMOLITION NOTES:

1. EXISTING CIRCUITING AND BACKBOX TO REMAIN FOR DEVICES THAT ARE REMOVED, UNLESS OTHERWISE NOTED.

DEMOLITION KEY NOTES:

- EXISTING DEVICE AND BACK BOX TO BE REMOVED. EXISTING CIRCUITING/CABLING TO REMAIN TO ACCOMMODATE NEW DEVICE. REFER TO SHEET E102 FOR NEW DEVICE LOCATION.
- EXISTING DEVICE AND BACK BOX TO BE REMOVED. EXISITING CIRCUITING/CABLING TO BE REMOVED BACK TO SOURCE OR NEAREST EXISTING TO REMAIN DEVICE WHERE BOXES ARE BEING REMOVED.
- EXISTING DEVICE AND BACK BOX TO BE REMOVED. REMOVE EXISTING CIRCUITING/CABLING TO NEAREST JUNCTION BOX OR PULL LOCATION FOR EXTENSION TO NEW DEVICE LOCATION.



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COUNTY COURT COURTROOM RENOVATIONS

1 LEO MOSS DRIVE OLEAN, NEW YORK 14760

Revisions

NO: DATE: DESCRIPTION:

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2180593.01

DRAWN BY:

CSP

REVIEWED BY:

NCH

ISSUED FOR:

BID

MARCH 25, 2019

DRAWING NAME:

DATE:

SECOND FLOOR ELECTRICAL DEMOLITION PLAN

DRAWING NUMBER:

ED102



GENERAL POWER NOTES:

- 1. CONCEAL CONDUIT IN WALLS WHEREVER FEASABLE. WHERE EXPOSED RACEWAY IS REQUIRED IN FINISHED SPACES, PROVIDE SURFACE METALLIC RACEWAY, DESIGN BASE: WIREMOLD 700 SERIES.
- 2. CONNECT NEW DEVICES TO EXISTING CIRCUITING SERVING THE AREA UNLESS
 OTHERWISE NOTED. UTILIZE EXISTING BACK BOXES AS NOTED IN DEMOLITION DRAWING
 ED102

POWER KEY NOTES:

PROVIDE A NEW BACKBOX. CONNECT NEW DEVICE TO EXISTING CIRCUITING.
EXTEND/REWORK EXISTING CIRCUITING AS REQUIRED TO ACCOMMODATE NEW DEVICE LOCATION.



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DATE:

SECOND FLOOR POWER PLAN

DRAWING NUMBER:

E102



GENERAL LIGHTING NOTES:

- 1. FEED ALL LIGHTING FROM EXISTING 277V AREA LIGHTING CIRCUITS. UPDATE HPD PANEL SCHEDULE WITH CHANGES.
- 2. PROVIDE POWER TO EMERGENCY/NIGHT-LIGHTS FROM EXISTING EMERGENCY LIGHTING CIRCUIT(S) WITH SPARE CAPACITY.
- 3. PROVIDE POWER TO EXIT SIGNS FROM NEAREST UNSWITCHED LIGHTING CIRCUIT.
- 4. PROVIDE 0-10V DIMMING CONTROL OF EMERGENCY/NIGHT-LIGHTS WHERE SWITCHING ZONE IS INDICATED.

LIGHTING KEY NOTES:

- PROVIDE NEW DEVICE AND BACK BOX. RUN NEW CONDUIT WITHIN EXISTING WALL TO NEW LIGHT FIXTURES.
- PROVIDE A NEW BACKBOX. CONNECT NEW DEVICE TO EXISTING CIRCUITING. EXTEND/REWORK EXISTING CIRCUITING TO ACCOMMODATE NEW DEVICE LOCATION.



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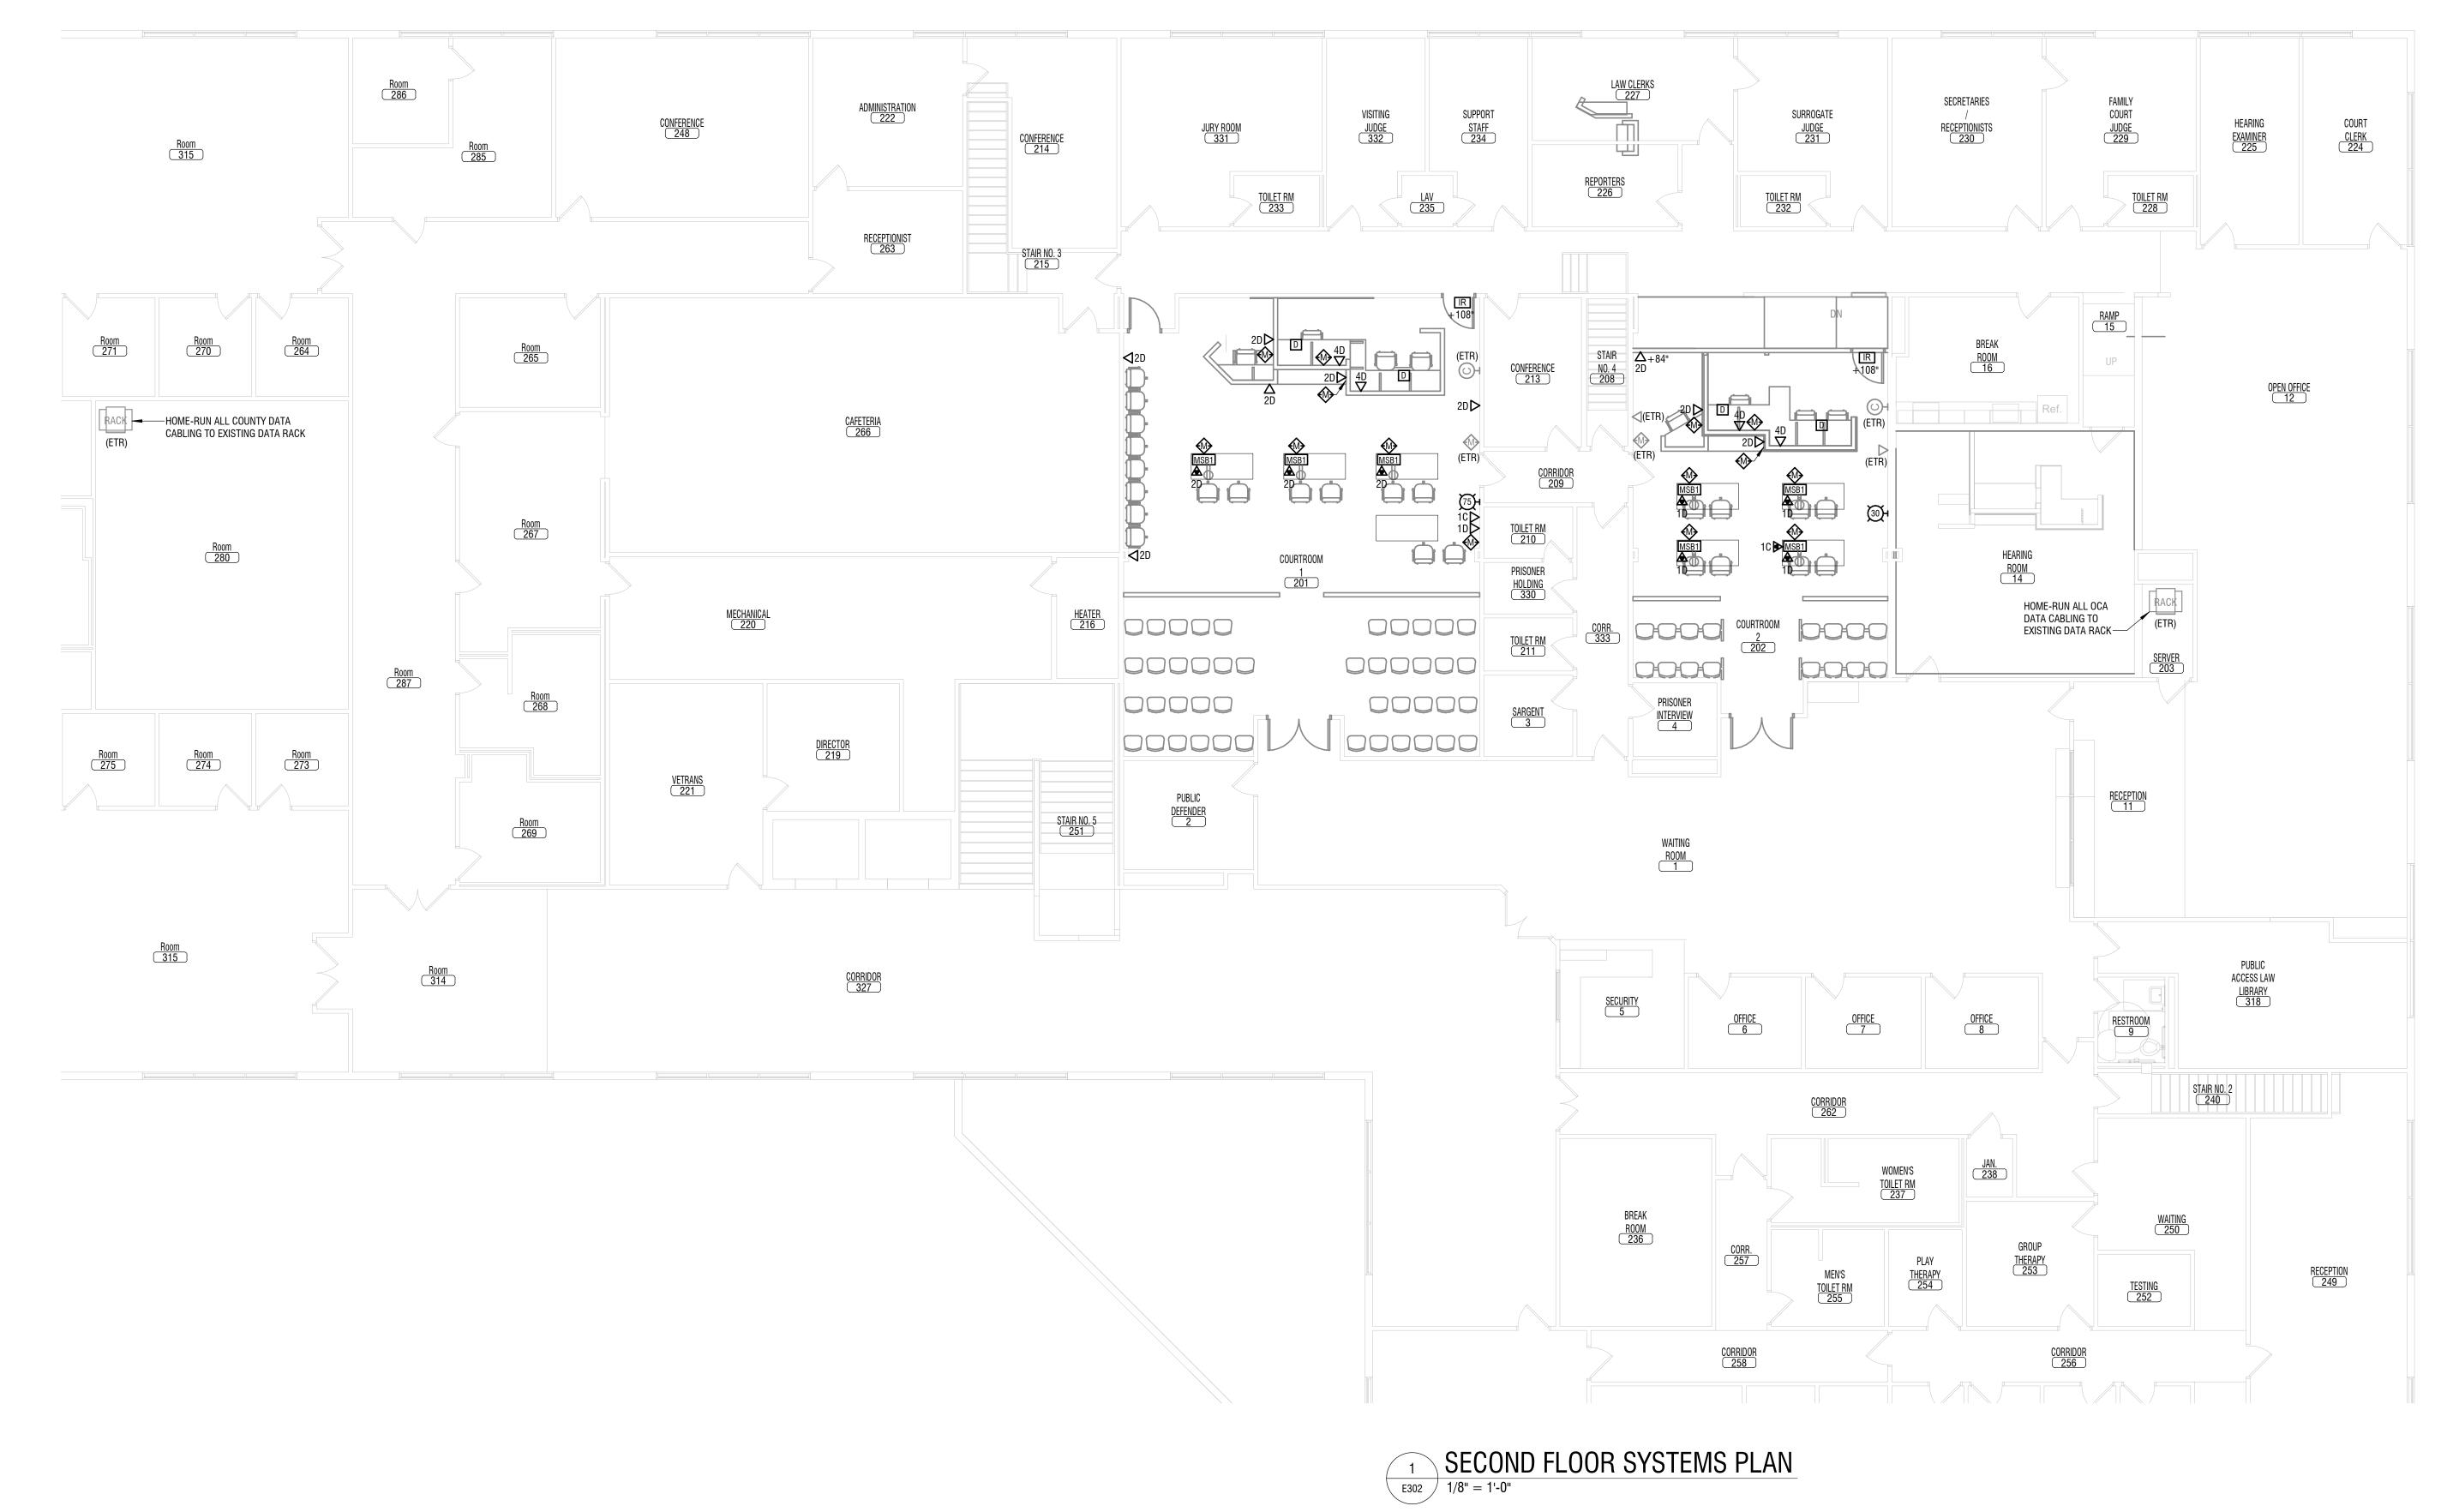
DATE: **MARCH 25, 2019**

DRAWING NAME:

SECOND FLOOR LIGHTING AND CEILING SPECIAL SYSTEMS PLAN


DRAWING NUMBER:

E202



GENERAL SYSTEMS NOTES:

- 1. PROVIDE (4) NEW 24 PORT, RACK MOUNTED, PUNCHDOWN PANELS IN EXISTING RACK IN SERVER 13. HOME-RUN ALL DATA CABLING TO NEW PUNCHDOWN PANELS.
- 2. HOME-RUN ALL SPEAKER CABLE TO SERVER 13. PROVIDE 10' OF SLACK CABLE FOR MIC AND SPEAKER RUNS ENDING IN SERVER 13.
- 3. REFER TO SHEET E202 FOR LOCATIONS OF SPECIAL SYSTEMS CEILING DEVICES.
- 4. DURESS BUTTON DEVICES SHALL HOMERUN BACK TO EXISTING SYSTEM.

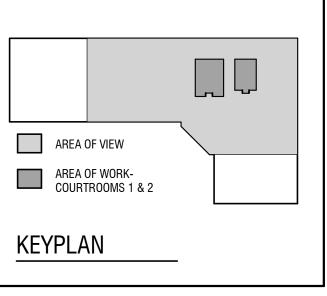

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DRAWING NAME:

SECOND FLOOR SYSTEMS PLAN

DRAWING NUMBER:

E302

DESIGNATION: LPF2

LOCATION: OPEN OFFICE 12

FED FROM: LMDP
SERVICE ENTRANCE LABEL:
OPTIONS:

DESIGN BASE: SQUARE D XX SERIES
DISTRIBUTION VOLTAGE: 208Y/120V
OF PHASES: 3
OF WIRES: 4
MOUNTING: RECESSED
ENCLOSURE TYPE: NEMA 1

FULLY RATED AIC: 10,000

MAIN TYPE: MLO

BUS RATING: 225 A

MCB TRIP:

MODIFICATIONS:

PANELBOARD SCHEDULE NOTATION:

* PROVIDE GFCI TYPE BREAKER

** REFER TO POWER DISTRIBUTION ONE-LINE DIAGRAM OR EQUIPMENT CONNECTION SCHEDULE(S) FOR TRIP RATING.

*** COORDINATE CIRCUIT BREAKER RATING WITH SPD MANUFACTURER

СКТ	CIRCUIT DESCRIPTION	BKR	POLES		Α	I	В	C	;	POLES	BKR	CIRCUIT DESCRIPTION	СКТ
1	EXISTING CIRCUIT	20 A	1	0	0					1	20 A	EXISTING CIRCUIT	2
3	EXISTING CIRCUIT	20 A	1			0	0			1	20 A	EXISTING CIRCUIT	4
5	EXISTING CIRCUIT	20 A	1					0	0	1	20 A	EXISTING CIRCUIT	6
7	EXISTING CIRCUIT	20 A	1	0	0					1	20 A	EXISTING CIRCUIT	8
9	EXISTING CIRCUIT	20 A	1			0	0			1	20 A	EXISTING CIRCUIT	10
11	EXISTING CIRCUIT	20 A	1					0	0	1	20 A	EXISTING CIRCUIT	12
13	EXISTING CIRCUIT	20 A	1	0	0					1	20 A	EXISTING CIRCUIT	14
15	EXISTING CIRCUIT	20 A	1			0	0			1	20 A	EXISTING CIRCUIT	16
17	EXISTING CIRCUIT	20 A	1					0	0	1	20 A	EXISTING CIRCUIT	18
19	EXISTING CIRCUIT	20 A	1	0	0					1	20 A	EXISTING CIRCUIT	20
21	EXISTING CIRCUIT	20 A	1			0	0			1	20 A	EXISTING CIRCUIT	22
23	EXISTING CIRCUIT	20 A	1					0	720	1	20 A	Receptacles (Floorbox) - Courtroom 2	24
25	EVICTIMO CIDOLIIT	20.4	0	0	720					1	20 A	Receptacles (Bench) - Courtroom 2	26
27	EXISTING CIRCUIT	20 A	2			0	720			1	20 A	Receptacles (Floorbox) - Courtroom 1	28
29	Receptacles (IR) - Courtroom 1&2	20 A	1					360	1080	1	20 A	Receptacles - Courtroom 1	30
31	Receptacle (Copier) - Courtroom 1	20 A	1	180	0					1	20 A	SPARE	32
33	SPARE	20 A	1			0	0			1	20 A	SPARE	34
35	SPARE	20 A	1					0	0	1	20 A	SPARE	36
37	SPARE	20 A	1	0	0					1	20 A	SPARE	38
39	SPARE	20 A	1			0	0			1	20 A	SPARE	40
41	SPARE	20 A	1					0	0	1	20 A	SPARE	42
	TOTAL CONNECTED PHAS	E LOADS:		900	0 VA	720	VA	2160) VA		•		<u> </u>
	TOTAL CONNECTED PHASE CO	JRRENTS:		8	3 A	6	Α	18	Α				

	FOOT CANDLE SCHEDULE									
ROOM	AVERAGE	MAXIMUM	MINIMUM	AVG/MIN	MAX/MIN					
COURTROOM 1	57.47	89.2	13.0	4.42	6.86					
COURTROOM 2	51.98	72.6	15.1	3.44	4.81					

	LUMINAIRE SCHEDULE								
TYPE	SOURCE	DESIGN BASE	DESCRIPTION	NOTES					
В	LED	METALUX #22EN-LD2-43-UNV-L835-CD1-U	2X2 ARCHITECTURAL LED TROFFER - 0-10V DIMMING						
BE	LED	METALUX #22EN-LD2-43-UNV-L835-CD1-EL14W	2X2 ARCHITECTURAL LED TROFFER - 0-10V DIMMING, EM BATTERY PACK						
С	LED	METALUX #22GR-LD5-24-F1-UNV-L835-CD1-U	2X2 LENSED LED TROFFER - 0-10V DIMMING						
D	LED	HALO #PR820DLV-PR8M12WDMW	8" LED DOWNLIGHT - 0-10V DIMMING						
Е	LED	HALO #RA4069S1EWH	4" WALL WASH LED DOWNLIGHT - 0-10V DIMMING	1					
EX	LED	SURE-LITES #CX71-SD	ALUMINUM EXIT WITH WHITE PAINTED SINGLE FACE, AND SELF DIAGNOSTICS						

NOTES:

1. PROVIDE HALO LED HOUSING UNIT, H995ICAT.



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ELECTRICAL SCHEDULES

DRAWING NUMBER:

E600

FIRE PROTECTION NOTES **GENERAL NOTES** THE PRELIMINARY DESIGN SHOWN ON THESE CONTRACT DOCUMENTS IS TO PROVIDE GUIDANCE FOR 1. BY EXECUTING THE CONSTRUCTION AGREEMENT, THE CONTRACTOR REPRESENTS THAT THEY HAVE VISITED THE SITE, FAMILIARIZED THEMSELVES WITH THE LOCAL CONDITIONS UNDER WHICH THE WORK BIDDING AND TO OBTAIN APPROVAL OF THE AUTHORITIES HAVING JURISDICTION. SUBMIT COMPLETE IS TO BE PERFORMED. CORRELATED THEIR OBSERVATIONS WITH ALL THE REQUIREMENTS OF THE FIRE SPRINKLER SHOP DRAWINGS AS REQUIRED BY CONTRACT DOCUMENTS TO THE OWNER'S CONTRACT DOCUMENTS, AND IS AWARE OF THE OWNER'S INTENDED USE OF THE PROJECT AREA. ANY DESIGNATED REVIEWER. BASE DESIGN UPON THESE DRAWINGS AND AS REQUIRED BY THE AREAS WHERE ADDITIONAL INFORMATION ARE TO BE IMMEDIATELY BROUGHT TO THE ATTENTION OF THE SPECIFICATIONS. SHOP DRAWINGS SHALL INCLUDE ELEVATIONS, HANGER LOCATIONS, PIPE LENGTHS, DIMENSIONS, FABRICATION METHODS, MATERIAL DATA, AND ADDITIONAL INFORMATION NECESSARY TO CLARIFY THE INTENT OF INSTALLATION. CONTRACTOR SHALL PROVIDE PIPE SIZE, SPRINKLER SPACING, AND SYSTEM CONFIGURATION AS SHOWN. ALTERNATES MUST BE APPROVED IN WRITING BY FIRE THE CONTRACTOR SHALL INSTALL WORK SUBSTANTIALLY AS INDICATED ON THE DRAWINGS. VERIFY PROTECTION ENGINEER OF RECORD DOCUMENTS PRIOR TO BID. EXACT LOCATION AND ELEVATIONS AT THE SITE. DO NOT SCALE THE DRAWINGS. MAKE NECESSARY CHANGES IN ELEVATION, FITTINGS, OR OFFSETS TO ACCOMMODATE OBSTACLES OR INTERFERENCES ALL DIMENSIONS ARE TO BE FIELD VERIFIED BEFORE START OF WORK. NOTE CAREFULLY THAT THE FIRE PROTECTION DRAWING ARE INTENDED TO INDICATE, ONLY DIAGRAMMATICALLY, TO THE EXTENT AND GENERAL CHARACTER AND LOCATIONS OF THE WORK INCLUDED, PROVIDE ALL WORK OBVIOUSLY INTENDED. BUT HAVING MINOR DETAILS OMITTED OR NOT THE CONTRACTOR IS TO PROTECT FURNISHINGS, EQUIPMENT, ETC. AND PROPERLY STORE MATERIAL SHOWN. COMPLETE AS REQUIRED TO PERFORM THE FUNCTIONS INTENDED. FOLLOW THE CONTRACT DOCUMENTS FOR BUILDING DETAILS AND FIT THE WORK OF THE FIRE PROTECTION DRAWINGS AND SPECIFICATIONS THERETO. CONTRACTOR TO VERIFY ALL MEASUREMENTS BEFORE ORDERING MATERIALS OR DOING ANY WORK. NO EXTRA COMPENSATION OR CHANGE ORDERS WILL BE ISSUED DUE TO DIFFERENCES BETWEEN ACTUAL MEASUREMENT AND DIMENSIONS ON THE DRAWINGS. CONTRACTOR SHALL LAY OUT ALL EQUIPMENT PRIOR TO FABRICATION OR INSTALLATION TO ASSURE PROPER FIT AND AVOIDANCE OF OBSTRUCTIONS, METHOD AND ENGAGING A NICET LEVEL 3 DESIGNER AS PER SPECIFICATIONS. AND SHALL THOROUGHLY COORDINATE WORK WITH ALL TRADES AND DETERMINE EXACT ROUTE AND LOCATION OF EACH ELEMENT AND PIECE OF EQUIPMENT BEFORE FABRICATION AND INSTALLATION.

CONTRACTOR IS RESPONSIBLE FOR VERIFYING THAT 50 PSIG MIN PRESSURE IS AVAILABLE TO THE BUILDING AND GENERATIONOF WORKING DRAWINGS OF THE SYSTEM BASED ON PIPE SCHEDULE

COORDINATE LOCATIONS OF FIRE PROTECTION COMPONENTS, INCLUDING PIPING, ALARMS, RAINS, TEST POINTS, ETC. WITH ARCHITECTURAL, STRUCTURAL, MECHANICAL, AND ELECTRICAL COMPONENTS. OBSTRUCTION TO SPRINKLER DISCHARGE MUST BE CONSIDERED DURING SHOP DRAWING PRODUCTION AND INSTALLATION: ADDITIONAL SPRINKLERS MAY BE REQUIRED AT NO ADDITIONAL COST TO OWNER, REFER TO SPECIFICATIONS FOR ADDITIONAL REQUIREMENTS.

SUBMIT A REQUEST FOR INFORMATION FOR QUESTIONS REGARDING THE FIRE PROTECTION DOCUMENTS.

CONTRACTOR MUST REVIEW ALL CONSTRUCTION DOCUMENTS PRIOR TO BID. SHOULD MODIFICATIONS TO THESE PLANS BECOME NECESSARY TO PROPERLY COORDINATE THE SYSTEM WITH ALL OTHER TRADES. IT WILL BE THE CONTRACTOR'S RESPONSIBILITY TO OBTAIN APPROVAL OF THE CHANGES FROM BOTH THE AUTHORITY HAVING JURISDICTION AND THE OWNER'S DESIGNATED REVIEW CONSULTANT IN ADDITION TO OBTAINING THE NECESSARY APPROVALS. THE CONTRACTOR MUST MAKE NOTE OF ANY FIELD OR COORDINATION CHANGES ON THE INSTALLATIONS DRAWINGS, AND PROVIDE A SET OF AS-BUILT DRAWINGS ONCE COMPLETE.

CONTRACTOR SHALL ROUTE PIPING AROUND ALL OBSTRUCTIONS AND PROVIDE SPRINKLER PROTECTION UNDER OBSTRUCTIONS AS DETAILED IN NFPA 13 AS PART OF THE FIELD COORDINATION AT NO ADDITIONAL COST TO OWNER.

ALL SPRINKLER DEFLECTOR DISTANCE REQUIREMENTS SHALL BE IN ACCORDANCE WITH NFPA 13.

PENETRATIONS OF RATED ASSEMBLIES SHALL BE FIRE STOPPED WITH APPROVED MATERIALS PER METHODS DESCRIBED BY THE UL FIRE RESISTANCE DIRECTORY.

PROVIDE FLUSHING CONNECTIONS IN ACCORDANCE WITH NFPA 13.

PROVIDE ALL NECESSARY OFFSETS, RAISES, OR DROPS IN PIPING AND AUXILIARY DRAINS REQUIRED BY BUILDING CONDITIONS. PIPE ELEVATION CHANGES ARE APPROXIMATE DIMENSIONS ONLY.

ALL MATERIALS SHALL BE UL LISTED OR FM APPROVED. SPRINKLER PIPE SHALL BE MANUFACTURED TO STANDARDS RECOGNIZED BY NFPA 13. THREADED PIPE SHALL HAVE A CORROSION RESISTANCE RATING OF 1.0 OR GREATER. CRIMP-TYPE COUPLERS SHALL NOT BE USED.

HYDROSTATICALLY TEST NEW ABOVE GROUND SPRINKLER PIPING FOR LEAKAGE IN PRESENCE OF

ROUTE SPRINKLER MAINS ABOVE BOTTOM CHORD OF JOISTS AND FOLLOW PITCH/SLOPE OF ALL CEILING

MFG

MIN

MISC

MOCP

MPC

MTG

MECHANICAL

MINIMUM

MANUFACTURER

MISCELLANOUS

NOT APPLICABLE

NORMALLY CLOSED

MAXIMUM OVERCURRENT PROTECTION


MEDIUM PRESSURE CONDENSATE

MEDIUM PRESSURE STEAM

ABBREVIATIONS

NOTE: SOME ABBREVIATIONS MAY NOT BE USED ON DRAWINGS

REFER TO ARCHITECTURAL DRAWINGS FOR ALL CEILING AND WALL ELEVATIONS.

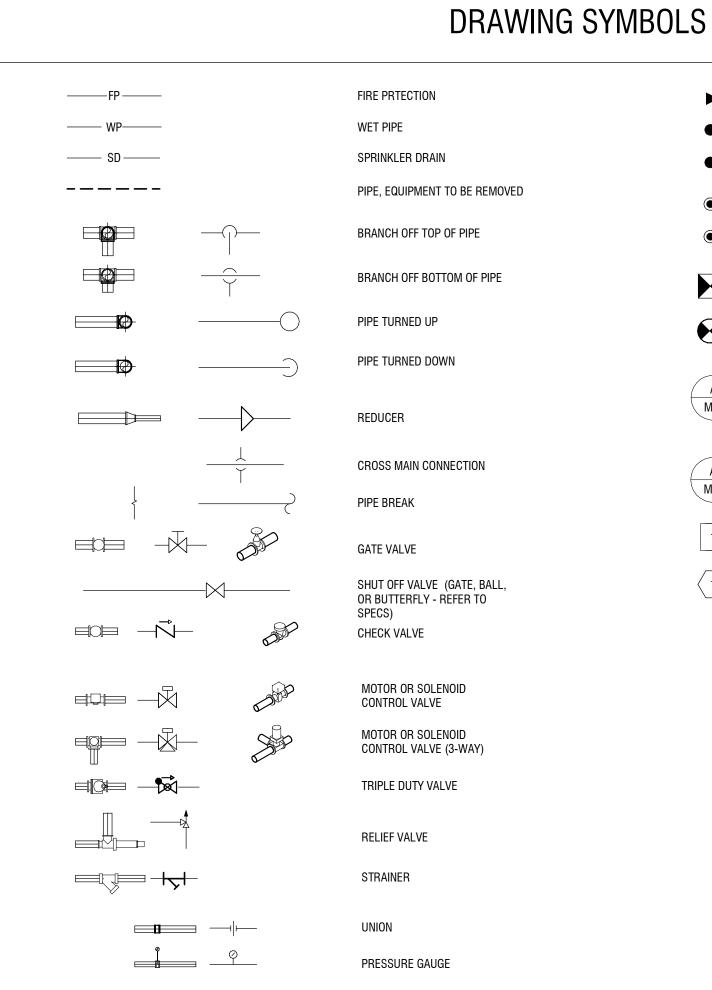

EQUIPMENT TO BE REMOVED

L __ _ _ _ _

SIDEWALL SPRINKLER HEAD SEMI-RECESSED PENDANT SPRINKLER HEAD (REPLACEMENT OF EXISTING SPRINKLER HEAD) SEMI-RECESSED PENDANT SPRINKLER HEAD (NEW SPRINKLER W/ NEW PIPING CONNECTIONS) CONCEALED PENDANT SPRINKLER HEAD (REPLACEMENT OF EXISTING SPRINKLER HEAD) CONCEALED PENDANT SPRINKLER HEAD (NEW SPRINKLER W/ NEW PIPING CONNECTIONS) POINT OF REMOVAL POINT OF CONNECTION SECTION CALLOUT DETAIL NUMBER M-2 / **DEMOLITION KEYNOTE**

KEYNOTE

alteration, and a specific description of the alteration. **CATTARAUGUS COUNTY**

It is a violation of New York Education Law

Article 145 Sec.7209, for any person, unless

acting under the direction of a licensed

architect, professional engineer, or land

surveyor, to alter an item in any way. If an item

bearing the seal of an architect, engineer, or

land surveyor is altered; the altering architect,

engineer, or land surveyor shall affix to the

item their seal and notation "altered by"

followed by their signature and date of such

300 State Street, Suite 201

Rochester, NY 14614

585-454-6110

labellapc.com

DEPARTMENT OF PUBLIC WORKS

COUNTY COURT COURTROOM RENOVATIONS

1 LEO MOSS DRIVE OLEAN, NEW YORK 14760

NO: DATE: DESCRIPTION: PROJECT NUMBER: 2180593.01 DRAWN BY: REVIEWED BY: EJL ISSUED FOR: BID

DATE: MARCH 25, 2019

FIRE PROTECTION LEGEND

DRAWING NUMBER:

DRAWING NAME:

BUILDING CODE JURISDICTION: CITY OF OLEAN

BUILDING CODE OF NEW YORK STATE.

CONTRACTOR IS TO BE RESPONSIBLE FOR KEEPING THE GENERAL WORK AREA CLEAN AND FREE FROM

DIRT AND CONSTRUCTION MATERIALS, AND CLEANING THE AREA THE END OF EACH DAY. ANY AND ALL

DAMAGE TO THE EXISTING WALLS, CEILINGS, FLOOR, ETC. THAT OCCURS DURING THE WORK, SHALL BE

REPAIRED AND PATCHED. IF THE SPECIFIC METHOD OF REPAIR IS IN QUESTION, THE CONTRACTOR IS TO

THE CONTRACTOR SHALL MAINTAIN ON THE SITE FOR THE OWNER A COMPLETE SET OF CONTRACT

AND BULLETINS, PROGRESSIVELY FILED AND UPDATED TO REFLECT THE LATEST CHANGES.

THE CONTRACTOR IS TO PROVIDE AS-BUILT DRAWINGS AT THE COMPLETION OF THE PROJECT.

MANUFACTURER'S RECOMMENDATIONS AND SPECIFICATIONS, UNLESS NOTED OTHERWISE.

DOCUMENTS AND ALL COPIES OF APPROVED SHOP DRAWINGS. ALL CHANGE ORDERS, FIELD ORDERS,

CONTRACTOR ACKNOWLEDGES THEY HAVE VERIFIED WITH THE OWNER'S REPRESENTATIVE ALL OF THE

DETAILS OF THE WORK PERFORMED INCLUDING THE ACCURACY OF ALL CONTRACT DRAWINGS AND

SPECIFICATIONS. ALL MATERIALS AND EQUIPMENT ARE TO BE INSTALLED IN ACCORDANCE WITH THE

ALL DEFECTS IN EQUIPMENT OR MATERIALS, OR ERRORS IN THE DRAWINGS DISCOVERED DURING THE

PERFORMANCE OF THE WORK SHALL BE REPORTED PROMPTLY TO THE OWNER'S REPRESENTATIVE. IN

THE CONTRACTOR SHALL GIVE ALL NOTICES AND COMPLY WITH ALL LAWS, RULES, REGULATIONS, AND

ORDERS OF ANY PUBLIC AUTHORITY BEARING ON THE PERFORMANCE OF THE WORK, BOTH ON AND OFF

SITE. IF ANY OF THE CONTRACT DOCUMENTS ARE AT VARIANCE THEREWITH IN ANY RESPECT,

CONTRACTOR REPRESENTS AND WARRANTS COMPLIANCE WIT HALL FEDERAL, STATE, AND LOCAL

PERFORM ALL OF THE WORK REQUIRED TO COMPLETE THE PROJECT, INCLUDING THE SATISFACTORY

PORTIONS OF THE PROJECT TO THE SATISFACTION OF THE OWNER'S REPRESENTATIVE, SETTLE ALL

CLAIMS AND SECURE RELEASE OF ALL MECHANICS LIEN OR LEINS OF A LIKE NATURE, AND SECURE THE

ISSUANCE BY AN APPROPRIATE GOVERNMENT AUTHORITY OF A CERTIFICATE OF OCCUPANCY. REMOVE

ALL RUBBISH, SURPLUS MATERIALS, SCAFFOLDING, AND EQUIPMENT FROM THE SITE WHETHER OR NOT

OPERATION OF ALL EQUIPMENT, AND THE CORRECTION OF ALL UNACCEPTABLE OR INCOMPLETE

LAWS, ORDNANCES AND REGULATIONS APPLICABLE TO THIS ORDER, INCLUDING THE NEW YORK STATE

CONTRACTOR SHALL PROMPTLY NOTIFY THE OWNER'S REPRESENTATIVE IN WRITING.

NO EVENT SHALL THE WORK PROCEED UNTIL DEFECTS AND/OR ERRORS HAVE BEEN RESOLVED.

CODES AND REGULATIONS:

FINAL COMPLETION:

BUILDING CODE, AND LOCAL GOVERNING BODY.

LEFT BY OR BELONGING TO THE CONTRACTOR.

CONFER WITH THE OWNER'S REPRESENTATIVE BEFORE COMMENCING THE REPAIR.

2. ENERGY CODE OF NEW YORK STATE.

PLUMBING CODE OF NEW YORK STATE.

4. MECHANICAL CODE OF NEW YORK STATE.

FIRE CODE OF NEW YORK STATE.

6. ENERGY CONVERSATION CODE OF NEW YORK STATE.

7. ACCESSIBLE AND USABLE BUILDING AND FACILITIES -CABO/ANSI.A117.1 - 1998

8. NATIONAL ELECTRIC CODE 2005

9. NATIONAL FIRE CODE: NFPA 13.

10. CODE OF THE CITY OF OLEAN

CONTACT INFORMATION

DOCUMENTS INCLUDE JURISDICTIONAL REQUIREMENTS AS APPROVED BY THE FOLLOWING CONTACTS:

CITY OF OLEAN CODES ENFORCEMENT: OLEAN, NY 14760

PHONE: (716) 376-5683 **CITY OF OLEAN FIRE DEPARTMENT**

OLEAN, NY 14760

PHONE: (716) 376-5687

ALTERNATING CURRENT ABOVE FINISHED FLOOR ABOVE FINISHED GRADE ALTERNATE AMBIENT AMPERE (AMP, AMPS) AMERICAN NATIONAL STANDARD ANSI APPORXIAMTE (LY) AVERAGE BACKFLOW PREVENTER BLDG BRAKE HORSEPOWER BUILDING BSMT BOTTOM OF BASEMENT **BRITISH THERMAL UNIT** BALANCING VALVE CAPACITY CAST IRON PIPE CLG CLR CEILING CLEAR **CLEANOUT or CARBON MONOXIDE** CONN COLUMN CONC CONNECTION CONT CONCRETE CONTINUOUS CUBIC FFFT VALVE FLOW COEFFICIENT DCDA DOMESTIC COLD WATER DOUBLE CHECK DETECTOR ASSEMBLY DCV DETECTOR CHECK VALVE DEMO DOMESTIC COLD WATER DHW DEMOLISH or DEMOLITION DOMESTIC HOT WATER DUCTILE IRON PIPE DWV DOMESTIC WATER HEATER DWG DRAIN, WASTE, & VENT DRAWING EXISTING ENGINEER EQUAL FSTIMATED ETR EXISTING TO REMAIN ELECTRIC WATER HEATER ENTERING WATER TEMPERATURE EXIST EXISTING EXPANSION

EXTERIOR

DEGREES FAHRENHEIT

FIRE DEPARTMENT CONNECTION FULL LOAD AMPS FEET PER MINUTE FEET PER SECOND FOOT OR FFFT FUTURE GAGE OR GAUGE GALLONS GENERAL CONTRACTOR GALLONS PER MINUTE GALLONS PER DAY GALLONS PER HOUR MERCURY **HORIZ** HORIZONTAL HORSEPOWER HIGH PRESSURE CONDENSATE HIGH PRESSURE STEAM HVAC HEATING, VENTILATING, AND AIR CONDITIONING FREQUENCY DIAMTER, INSIDE INSULATION IRON PIPE SIZE KW KWH KILOWATT KILOWATT HOUR LBS POUNDS LINEAR FEET LENGTH LOCATION LOW PRESSURE CONDENSATE LOW PRESSURE STEAM LWT LOCKED ROTOR AMPS MATL LEAVING WATER TEMPERATURE MAX MECH BTU PER HOUR (THOUSAND)

PSIG PSI GUAGE PRV PRESSURE REDUCING VALVE RCVR RECEIVER RECIRCULATE RECIRC HOT WATER RE-CIRCULATION **ROUGH OPENING** REDUCED-PRESSURE DETECTOR ASSY. RPM REVOLUTIONS PER MINUTE REDUCED-PRESSURE ZONE SPECIFICATION SPLY SUPPLY SQUARE FOOT (FEET) SQUARE INCH (INCHES) STD STANDARD SUCT SUCTION T'STAT THERMOSTAT TO BE DETERMINED TEMPERATURE DIFFERENCE TEMPERATURE THERMOSTATIC MIXING VALVE TAMPER SWITCH V0LT VACUUM VARIABLE VELOCITY **VERIFY IN FIELD** VOLUME WATT WITH WITH OUT WALL CLEANOUT WATER HAMMER ARRESTER WHA WATER METER WATER PRESSURE DROP WPD

NOT IN CONTRACT

NORMALLY OPEN

NON-RISING STEM

DIAMETER, OUTSIDE

PHASE (ELECTRICAL)

OUTSIDE SCREW AND YOKE

POUNDS PER SQUARE FOOT

POUNDS PER SQUARE INCH

WORKING WATER PRESSURE

PLUMBING CONTRACTOR

NOT TO SCALE

ON CENTER

PLUMBING

PRESSURE

PSF

NATIONAL PIPE TREAD

SPRINKLER HEAD TYPES SPRINKLER HEAD TEMP. RATING MANUFACTURER MODEL HORIZON 06697B **ROOMS WITH SUSPENDED CEILINGS** SEMI-RECESSED CHROME 165 F MICROMATIC 10138 **ROOMS WITH NO CEILINGS** UPRIGHT BRASS 165 F VIKING HORIZON MIRAGE ALL VESTIBULES, LOBBIES, AND CORRIDORS CONCEALED 165 F 2'-0" ABOVE BOTTOM OF ELEVATOR SHAFT SIDEWALL MICROMATIC HP HIGH (286 F) VIKING VARIES 0'-0" TO 7'-0" FROM FACE OF UNIT HEATERS VARIES BRASS INTERMEDIATE VIKING VARIES 7'-0" TO 20'-0" FROM FACE OF UNIT HEATERS BRASS (200 F)

NOT ALL SYMBOLS, ABBREVIATIONS AND

PARTICULAR PROJECT. ANY ADDITIONS OR


PARTICULAR ITEM FROM THIS PROJECT.

EQUIPMENT DESIGNATIONS MAY APPLY TO THIS

OMISSIONS FROM THIS LEGEND SHEET DOES NOT

IMPLY INCLUSION AND/ OR EXCLUSIONS OF ANY

		FIRE PROTECT	ION CRITERIA LI	<u>EGEND</u>		
HAZARD CLASSIFICATION	LOCATION DESCRIPTION	SPRINKLER System type	SPRINKLER Density	APPLICATION AREA (MOST HYD. REMOTE)	SPRINKLER HEAD TEMP. RATED	REMARKS
LIGHT HAZARD	ALL SPACES	WET PIPE SYSTEM	0.10 GPM/SQ. FT.	1500 SQ. FT.	167 °F	100 GPM INSIDE HOSE STREAM ALLOWANCE

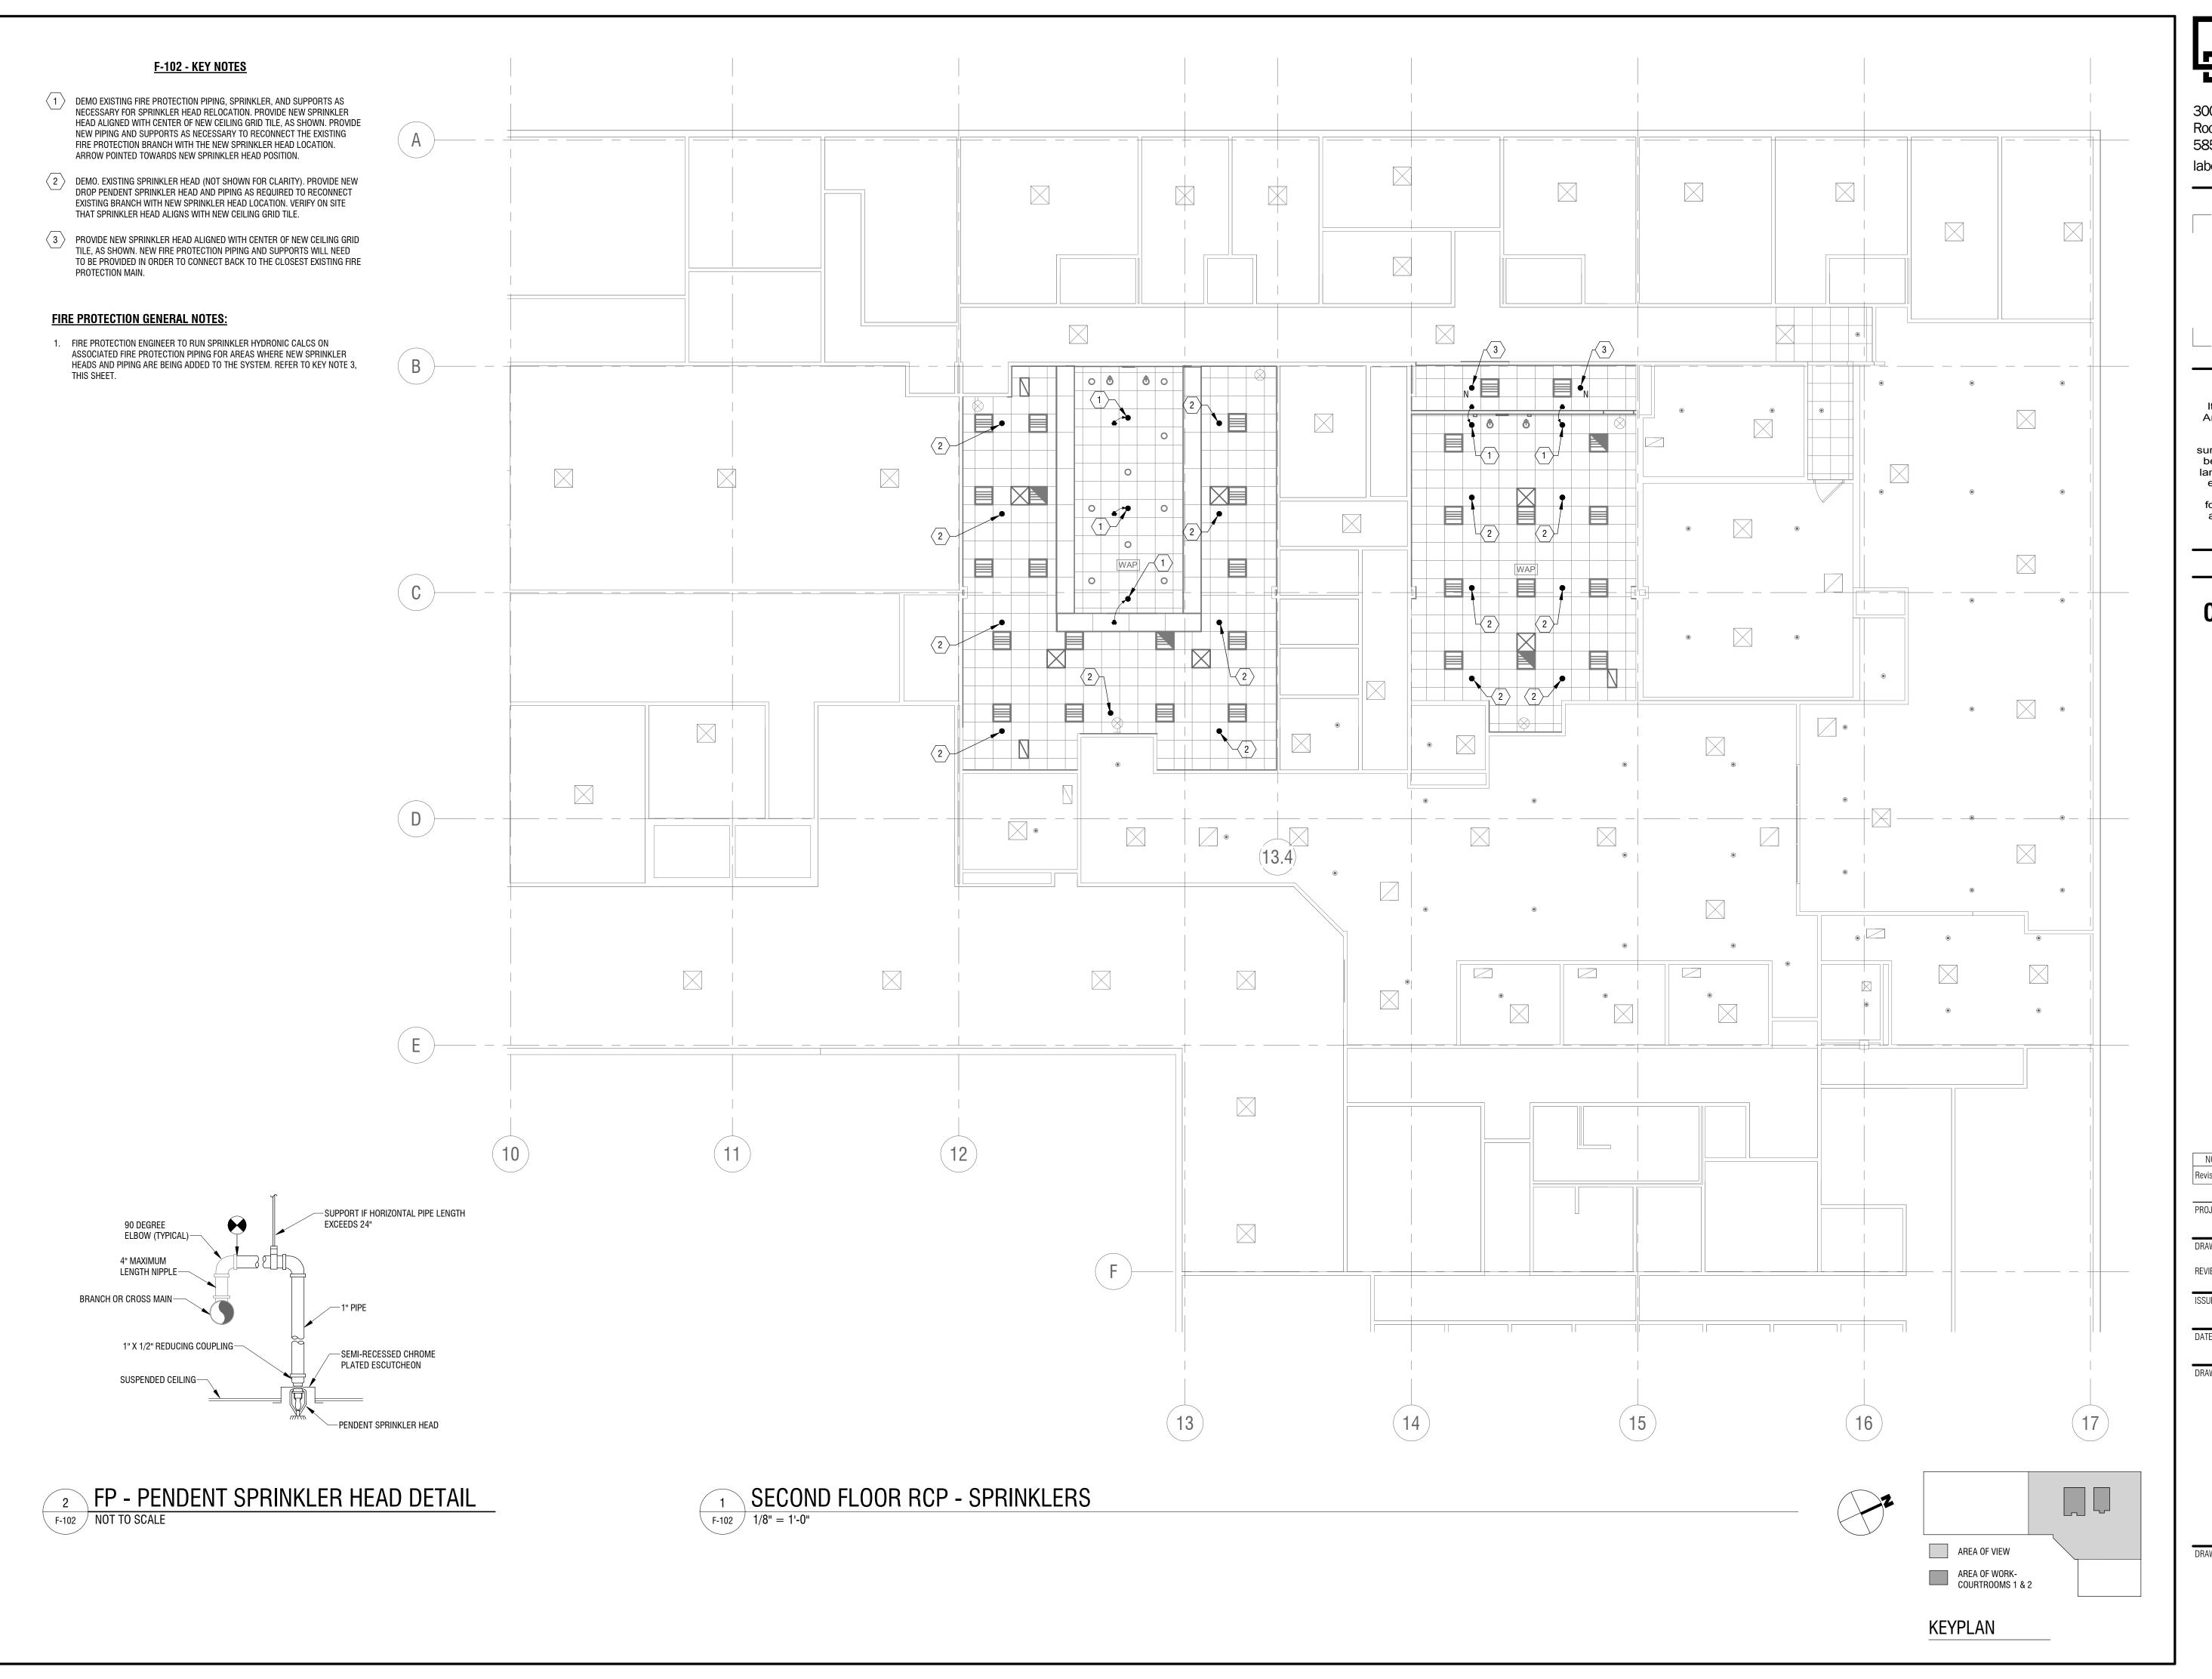

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alteration.

CATTARAUGUS COUNTY DEPARTMENT OF PUBLIC WORKS

COUNTY COURT COURTROOM RENOVATIONS

1 LEO MOSS DRIVE OLEAN, NEW YORK 14760

ISSUED FOR	EJL	
DRAWN BY:	ZAZ	
PROJECT N	2180593.01	
Revisions	DESCRIPTION:	

DRAWING NAME:

SECOND FLOOR CEILING FIRE PROTECTION PLAN

DRAWING NUMBER:

F-102